


SUMMARY OF FLOWS

	EXISTING CONDITION				
	PEAK RUNOFF TO GUTTER				
EVENT	SCS (CFS)	DELMARVA (CFS)			
WTR QUAL	0.06	0.06			
2 YR	0.12	0.10			
10 YR	0.22	0.20			
100 YR	0.36	0.36			

REFRENCE PLAN
TOPOGRAPHIC SURVEY
LOT 3, IN BLOCK 14105
JERSEY CITY, HUDSON COUNTY, NJ
BY: BEHAR SURVEY ASSOC, PC
WILLIAM B. KLAPPER, PLS
DATED: 08/30/21

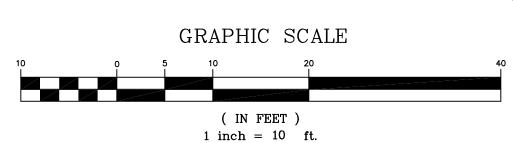



2.

1.

REV.

= EXIST. "B" INLET

™ = EXIST. WATER VALVE

= EXIST. FIRE HYDRANT

⇔ = EXIST. GAS VALVE

© = EXIST. GAS METER

= EXIST. UTILITY POLE

— — — = EXIST. WOOD FENCE

- x - x - = EXIST. VINYL FENCE

= EXIST. SIGN (MISC.)
= EXIST. STREET SIGN

-\$\dagger\$ = EXIST. TRAFFIC LIGHT
-\$\begin{align*}
= EXIST. OLD FIRE ALARM POLE

= EXIST. WOODS/BRUSH LINE $\begin{array}{c}
\circ \\
\circ \\
\circ'
\end{array}$ = EXIST. TREE WITH SIZE

 $\begin{array}{rcl}
&=& \text{EXIST. CONTOURS} \\
&\stackrel{115.8}{\times} &=& \text{EXIST. SPOT ELEVATION}
\end{array}$

-6"W─────────── = EXIST. 6" D.I.C.L.P. WATER MAIN SERVICE AND WATER VALVE

- S --- S - = EXIST. 8" PVC SANITARY SEWER PIPE

EX. PROP LINE (TBR)

EXISTING TREELINE

EX. PROP LINE

S = EXIST. SANITARY SEWER MANHOLE

= EXIST. UTILITY POLE WITH STREET LIGHT

= PROPOSED "B" INLET

2 = PROPOSED CONTOUR

→= PROPOSED 8" WATER VALVE

×94.62= PROPOSED SPOT ELEVATION

92.42 BC = PROPOSED BOTTOM OF CURB

FFF = 98.38 = PROPOSED FINISHED FIRST FLOOR ELEV

= PROPOSED FINISHED WOODS/BRUSH LINE

PCO = PROPOSED PRESSURE CLEANOUT

= PROPOSED DECIDUOUS TREE

= PROPOSED EVERGREEN TREE

= PROPOSED TREE PROTECTION

PROPOSED PROP LINE

FGF = 96.38 = PROPOSED FINISHED GARAGE FLOOR ELEV

92.92 TC = PROPOSED TOP OF CURB

CO = PROPOSED CLEANOUT

= PROP SIGN (MSG)

_____= PROPOSED BOLLARD LIGHT

PROPOSED TREELINE

SL9 = SOIL LOG LOCATION

6 = SHRUBS 4(3)AG

ELY

CIVIL & ARCHITECTURAL ENGINEERING

1701 Pennington Rd. — Ewing, NJ 08618

Phone (609)865—1596

Email: dcpeliken@verizon.net

DESCRIPTION

DCP
DESCRIPTION

DCP
DCP
DATE BY

OCT 20, 2021

DOUGLAS C. PELIKAN
N.J. LIC. PROFESSIONAL ENGINEER – GE27632

DOUGLAS C. PELIKAN, PE
CIVIL & ARCHITECTURAL ENGINEERING
1701 Penning on Rd. - Ewing, NJ 08618
Phone (609)865-1596
Email: dcpenken@verizon.net

4 STORY RESIDENTIAL
292 GRAND STREET
LOT 3 - BLOCK 14105
situate in


Situate in
JERSEY CITY


HUDSON COUNTY


SCALE: 1" = 20'

DRAWN BY: PROJECT NO. DRAWING FILE: SHEET NO

DCP

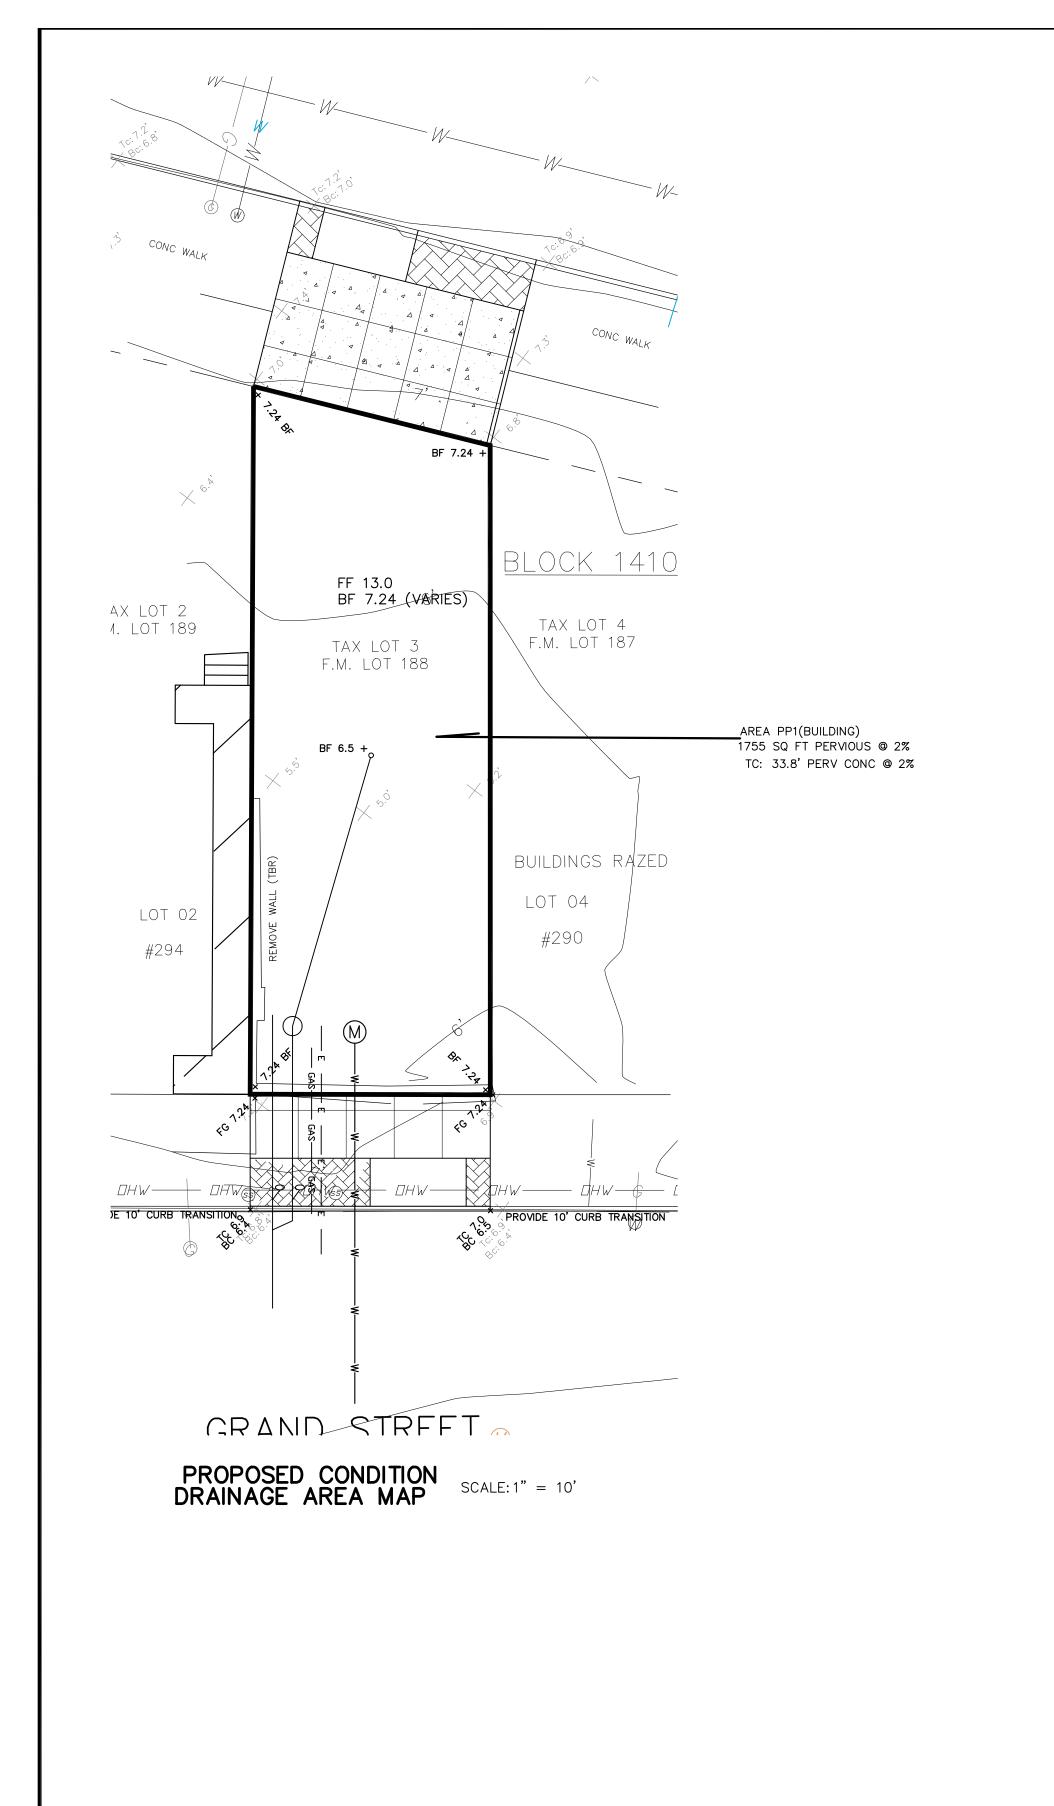


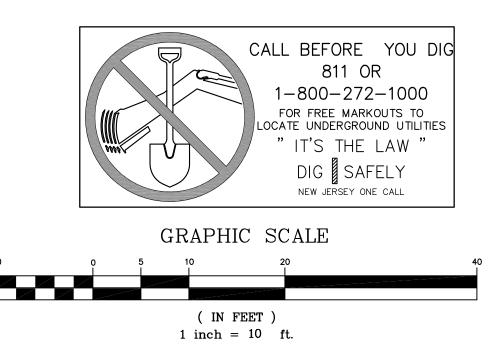

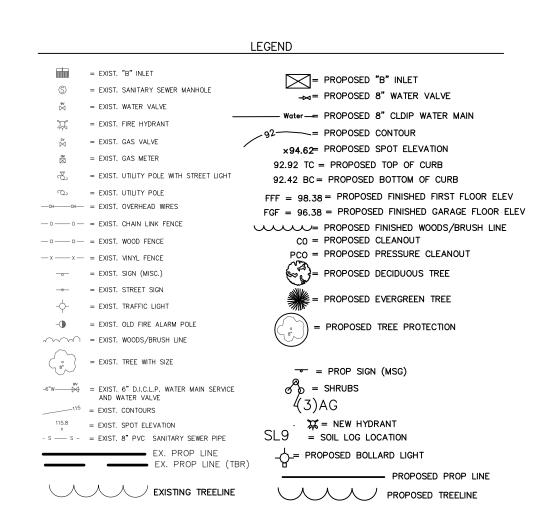

SUMMARY OF FLOWS

	EXISTING C	ONDITION	PROPOSED (CONDITION	PROPOSED	CONDITION
EVENT	PEAK RUNG TO GUTTE SCS (CFS)			RUNOFF SEWER DELMARVA (CFS)		ELEVATION DELMARVA (CFS)
WTR QUAL	0.06	0.06	0.00	0.00	6.51	6.51
2 YR	0.12	0.10	0.01	0.11	6.63	6.63
10 YR	0.22	0.20	0.05	0.05	6.83	6.83
100 YR	0.36	0.36	0.16	0.16	7.07	7.07

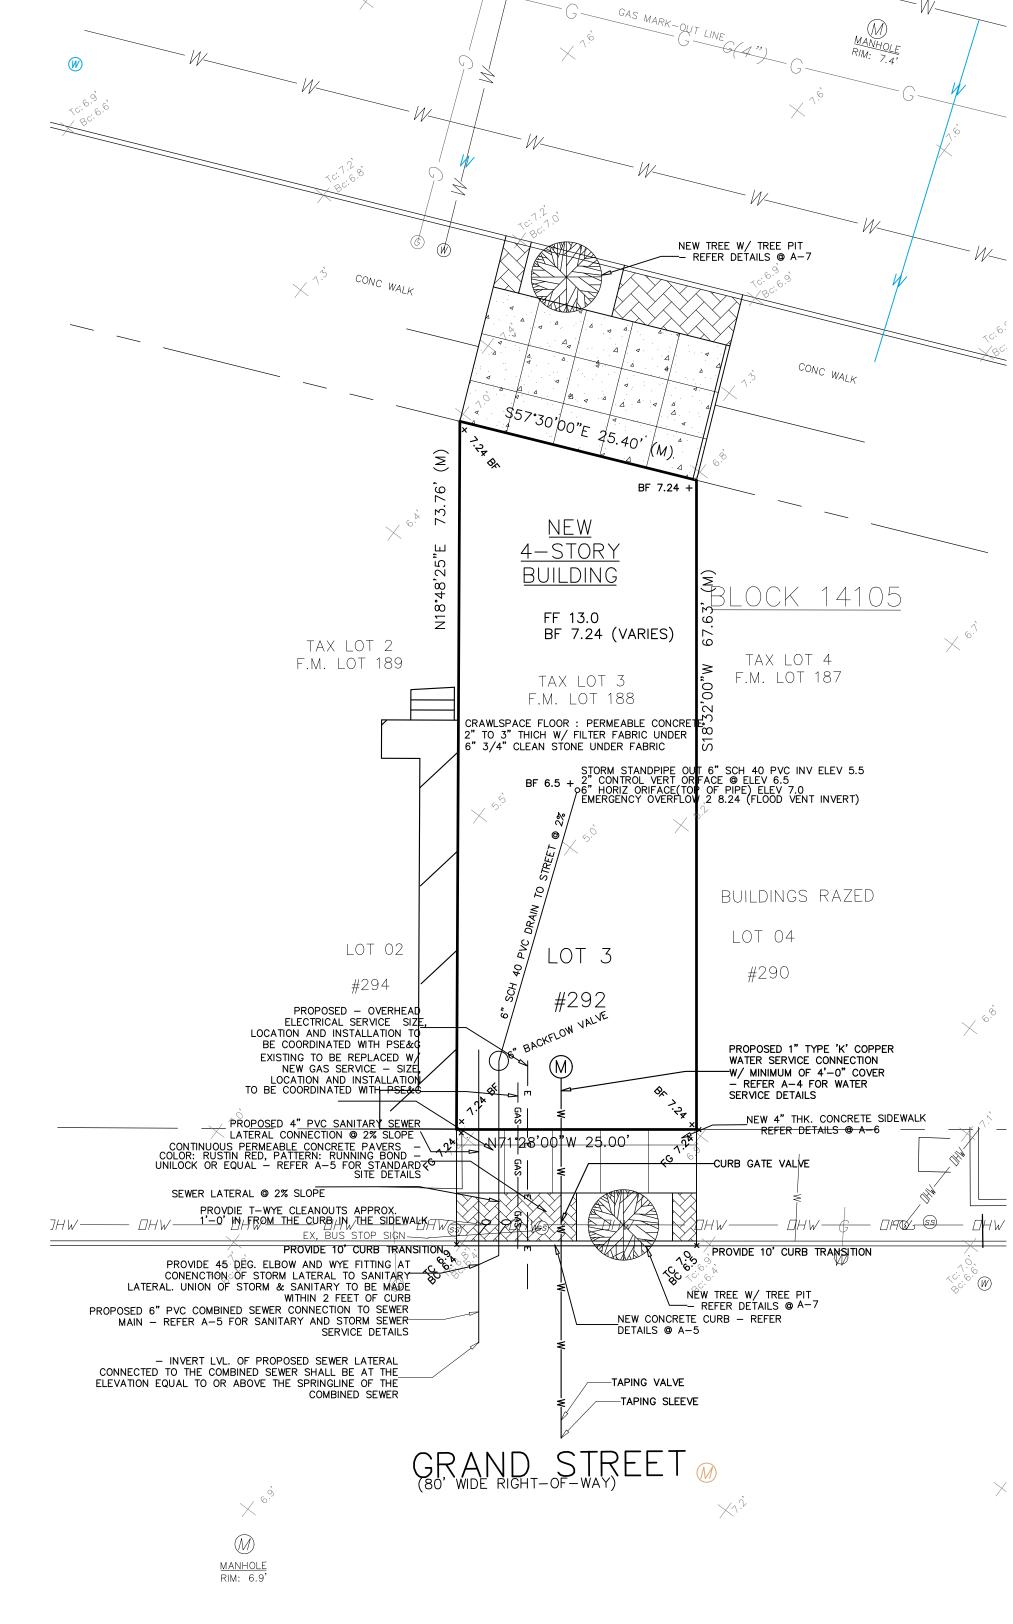

GRADING & UTILITY PLAN

SCALE: 1" = 10"

REFRENCE PLAN TOPOGRAPHIC SURVEY
LOT 3, IN BLOCK 14105
JERSEY CITY, HUDSON COUNTY, NJ
BY: BEHAR SURVEY ASSOC, PC
WILLIAM B. KLAPPER, PLS
DATED: 08/30/21

	PR			OPOSED STORMWATER DOUGLAS C. PELIKAN, PE CIVIL & ARCHITECTURAL ENGINEERING 1701 Pennington Rd. – Ewing, NJ 08618 Phone: (609)865-1596	GRADING & DRAINAGE PLAN FOR RUNOFF EVALUATION			
6.				Email: Achenan@verizon.net			Y RESIDENTI	AL
5.						LOT 3 -	AND STREET BLOCK 14105	
4.							ituate in SEY CITY	
3.				OCT 20, 2021		OUNTY	NEV	W JERSEY
2.				DOUGLAS	SCALE: AS DRAWN BY:			20, 2021 SHEET NO.
REV.	DESCRIPTION	DATE	BY	N.J. LIC. PROFESSIONAL ENGINEER – GE27632	DCP			2