


VIEW FROM ENOS PLACE

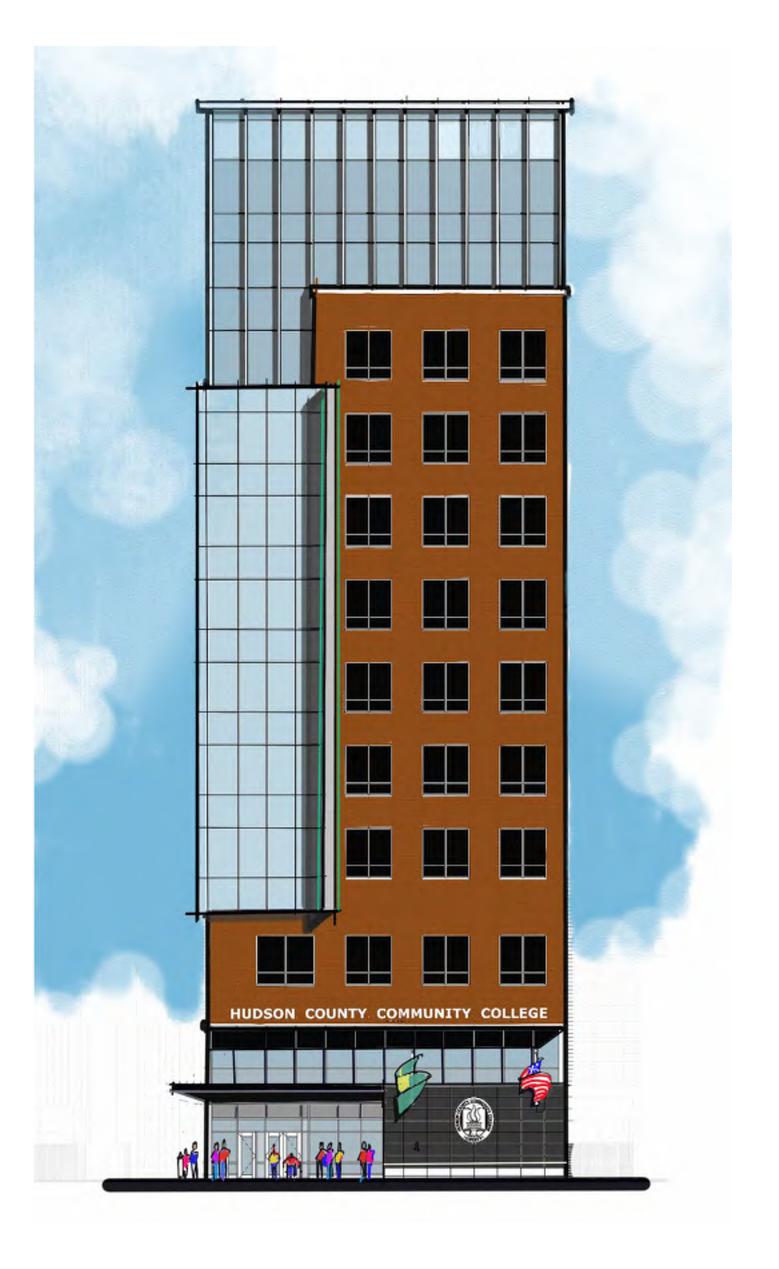



ELEVATIONS FOR REFERENCE



PROPOSE NEW

MIXED-USE ACADEMIC BUILDING

Jersey City, NJ

PROJECT DIRECTORY

HUDSON COMMUNITY COLLEGE JERSEY CITY, NEW JERSEY 07306 (201) 360-4052

OWNER REPRESENTATIVE MAST CONSTRUCTION SERVICE, INC 96 EAST MAIN STREET, SUITE 2

LITTLE FALLS, NJ 07424 CONTACT: TROY MARZZIOTTI, VICE-PRESIDENT

CIVIL ENGINEER NEGLIA ENGINEERING ASSOCIATES 34 PARK AVENUE, PO BOX 246 LYNDHURST, NJ 07071

MORRISTOWN, NJ 07960 CONTACT: STEPHEN P. ALUOTTO

STRUCTURE STUDIO 93 WASHINGTON STREET MORRISTOWN, NJ 07960

MEP ENGINEER

CONTACT: ANTHONY KURUS, P.E.

ARCHITECTS/INTERIOR DESIGNERS NK ARCHITECTS 95 WASHINGTON STREET

CONTACT: MARK VON BRADSKY, PE

LUONGO ASSOCIATES, P.A. 501 AMERICAN LEGION WAY POINT PLEASANT BEACH, NEW JERSEY, 08742 CONTACT: GERARD C. LUONGO, P.E., P.P.

TECHNOLOGY CONSULTANT THE CLARIENT GROUP 485C ROUTE 1 SOUTH, SUITE 200

ISELIN, NJ 08830

(212) 586-5840

CONTACT: CHARLES J. BUSCARINO STRUCTURAL ENGINEER

KEY PLAN



STEPHEN P. ALUOTTO, AIA AI 17503 AI 10867 WALTER J. KNEIS, AIA ALLEN R. KOPELSON, AIA DANIEL J. TOPPING, AIA

THE WOOLWORTH BUILDING 233 BROADWAY SUITE 2150, NEW YORK, NY 10279 t. 212.982.7900

INFORMATION IT CONTAINS MAY NOT BE REPRODUCED OR USED FOR OTHER THAN THE SPECIFIC PROJECT FOR WHICH IT WAS PREPARED WITHOUT THE EXPLICIT CONSENT OF NK ARCHITECTS.



COMMUNITY COLLEGE

MIXED-USE ACADEMIC BUILDING Jersey City, NJ

KEY PLAN


GENERAL INFORMATION


09/15/2022 SCALE

CHECKED

DRAWING NUMBER

G0.01

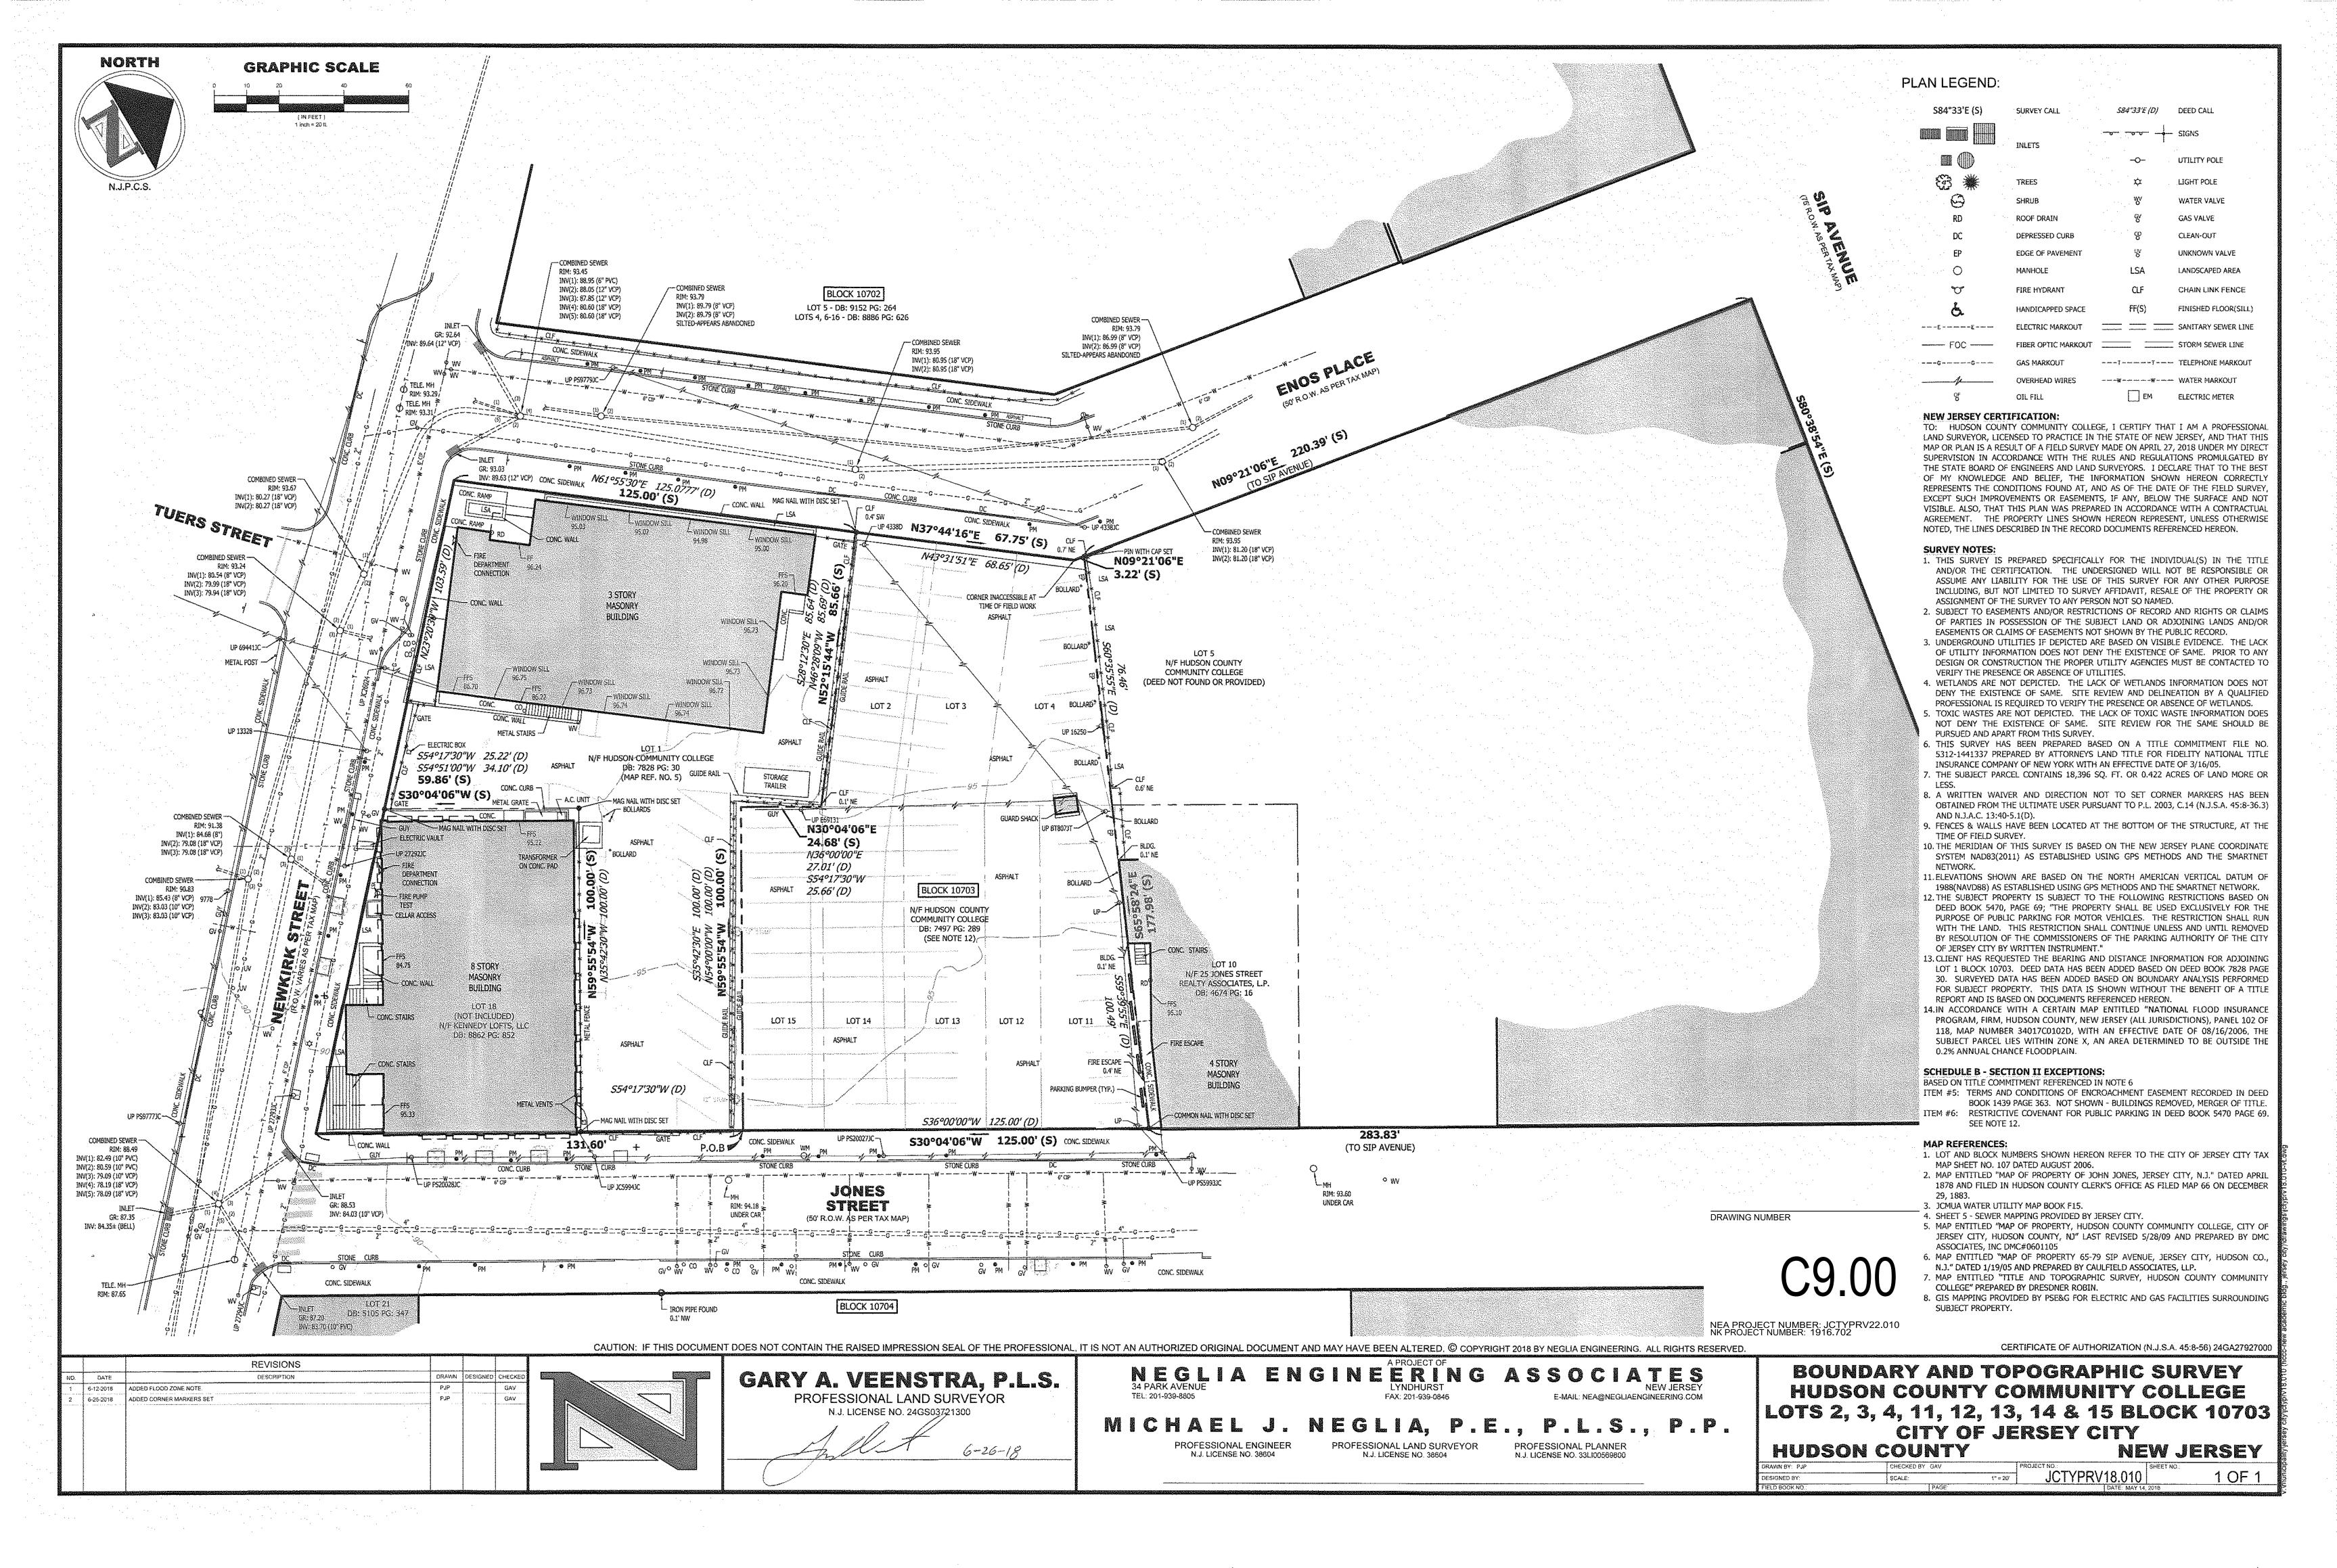

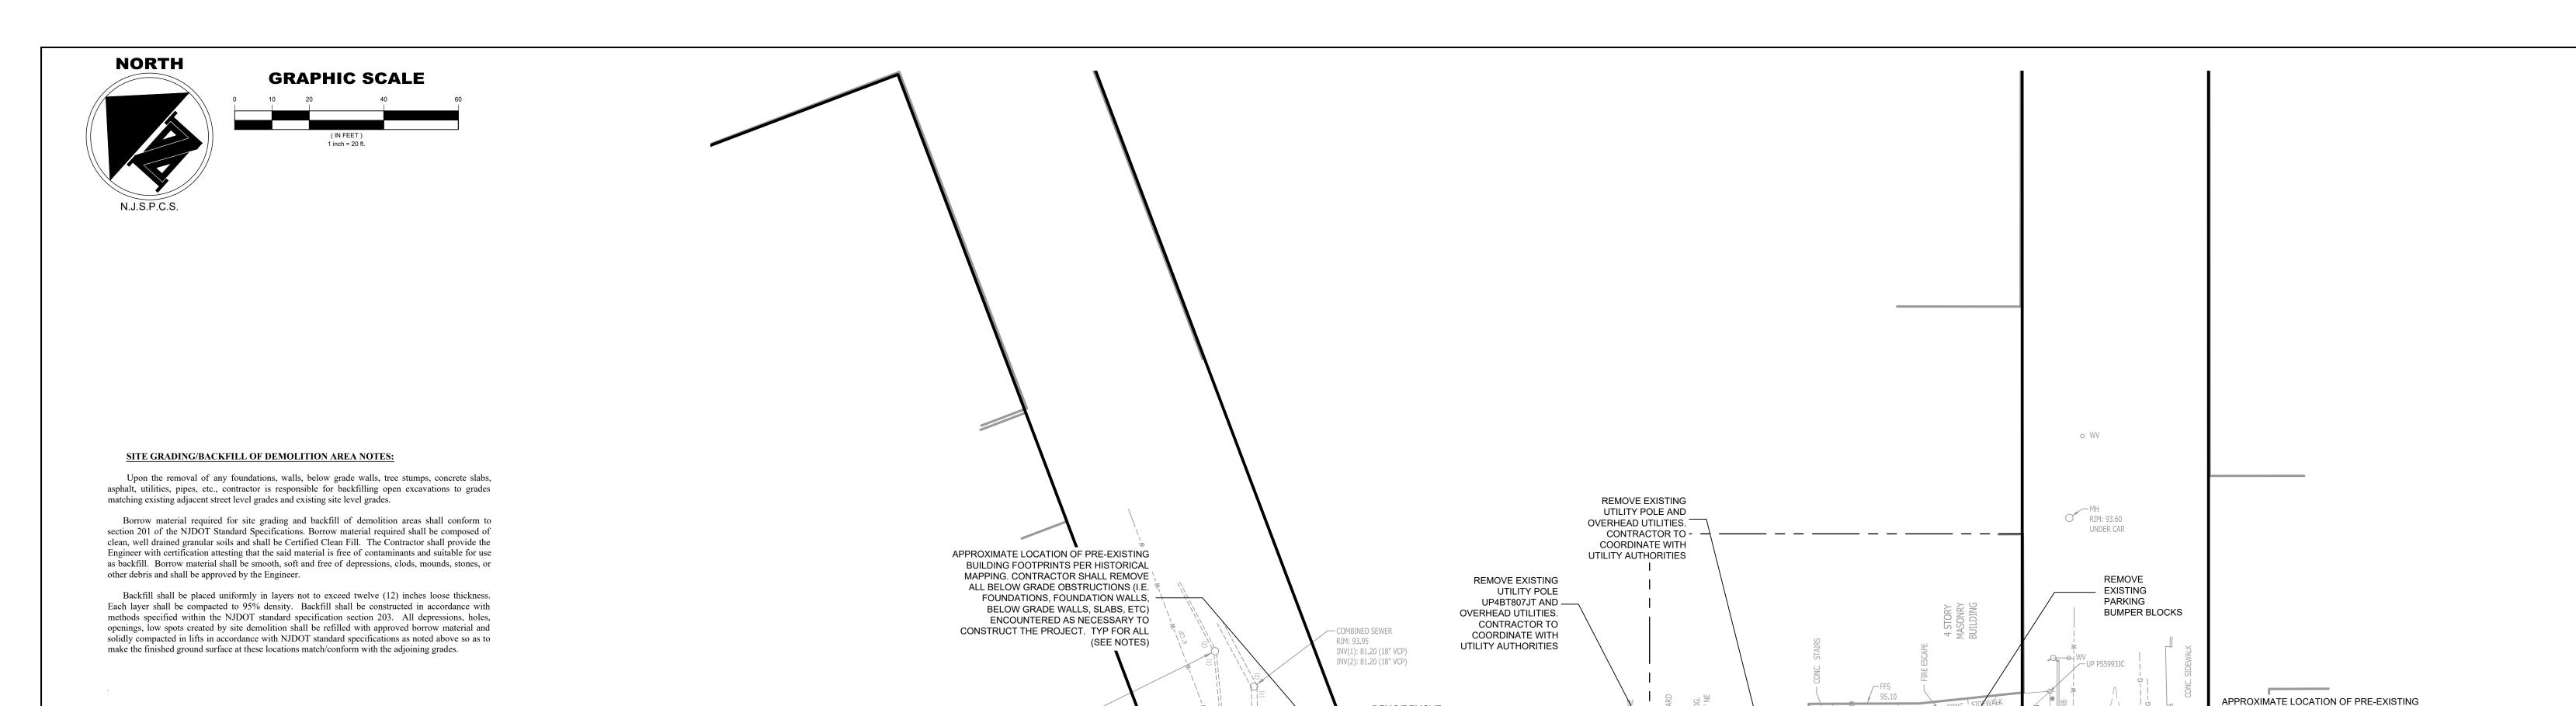

COMBINED SEWER -

CONSTRUCTION

REMOVE EXISTING

OVERHEAD UTILITIES.

CONTRACTOR TO

COORDINATE WITH

UTILITY AUTHORITIES

COMBINED SEWER -

INV(1): 80.95 (18" VCP)

DEMO/REMOVE

GUARD RAIL

AND FENCING

CONTRACTOR TO

OF 2 ENOS FIBER

DESIGN BY OTHERS

RELOCATION/RE-FEEDING -

CONNECTION WITH UTILITY AUTHORITY AND TELCOM

COMBINED SEWER —

INV(1): 89.79 (8" VCP)

INV(2): 89.79 (8" VCP)

SILTED-APPEARS ABANDONED

COMBINED SEWER —

RIM: 93,45 INV(1): 88.95 (6" PVC)

RIM: 93.79

COORDINATE

RIM: 93.95

ENOS

COMBINED SEWER -

INV(1): 80.27 (18" VCP) INV(2): 80.27 (18" VCP)

RIM: 93.67

COMBINED SEWER — RIM: 93.24

INV(1): 80.54 (8" VCP)

INV(2): 79.99 (18" VCP)

INV(3): 79.94 (18" VCP)

UTILITY POLE UP4338D AND -

FENCE (SEE NOTES

DEMO/REMOVE

BOLLARDS

DISCONNECT

UTILITIES AND >

REMOVE

TRAILER

STORAGE

WINDOW SILL

WINDOW SILL -

WINDOW SILL —

REMOVE

GUARD

SHACK

EXISTING ASPHALT

REMOVE EXISTING

CONTRACTOR TO

REMOVE .

COORDINATE WITH

UTILITY AUTHORITIES

UTILITY POLE UP4BT807JT

AND OVERHEAD UTILITIES.

DEMO/REMOVE

AND FENCING

CONSTRUCTION

FENCE AND

RIM: 90.83

INV(1): 85.43 (8" VCP)

INV(2): 83,03 (10" VCP) INV(3): 83.03 (10" VCP)

RIM: 91.38

INV(1): 84,68 (8")

INV(2): 79.08 (18" VCP)

INV(3): 79.08 (18" VCP)

ACCESS GATE

GUIDE RAIL

TREE STUMP

NK ARCHITECTS 95 WASHINGTON STREET, MORRISTOWN, NJ 07960

f. 973.539.0916 THE WOOLWORTH BUILDING 233 BROADWAY SUITE 2150, NEW YORK, NY 10279 t. 212.982.7900

f. 212.982.8111 www.nkarchitects.com

STEPHEN P. ALUOTTO, AIA PAUL J. DRAGO, AIA AI 17503 WALTER J. KNEIS, AIA AI 10867 ALLEN R. KOPELSON, AIA AI 05644 BEN P. LEE, AIA AI 07017 DANIEL J. TOPPING, AIA

THIS DOCUMENT IS THE EXCLUSIVE PROPERTY OF NK ARCHITECTS. THE DOCUMENT AND THE INFORMATION IT CONTAINS MAY NOT BE REPRODUCE OR USED FOR OTHER THAN THE SPECIFIC PROJECT FOR WHICH IT WAS PREPARED WITHOUT THE EXPLICIT CONSENT OF NK ARCHITECTS.



HUDSON COUNTY COMMUNITY COLLEGE MIXED-USE ACADEMIC **BUILDING**

Jersey City, New Jersey





MICHAEL J. NEGLIA PROFESSIONAL ENGINEER PROFESSIONAL LAND SURVEYOR PROFESSIONAL PLANNE N.J. LICENSE NO. 38604 N.J. LICENSE NO. 5698

GREGORY J. POLYNIAK, P.E., P.P. PROFESSIONAL ENGINEER PROFESSIONAL PLANNER
N.J. LICENSE NO. 43136 NJ. LICENSE NO. 5883

ANTHONY KURUS, P.E., P.P. PROFESSIONAL ENGINEER PROFESSIONAL PLANNER
N.J. LICENSE NO. 46445 N.J. LICENSE NO. 6145

KEY PLAN

ISSUED FOR BID

SITE DEMOLITION **PLAN**

DESCRIPTION

09/15/2022 SCALE

RIM: 86.24

COMBINED SEWER —

INV(1): 77,69 (10" VCP)

INV(2): 77.49 (10" VCP)

RIM: 86.69

└─ TELE. MH

RIM: 87.65

1" = 20'DRAWN

DRAWING TITLE

CHECKED DRAWING NUMBER

NEA PROJECT NUMBER: JCTYPRV22.010 NK PROJECT NUMBER: 1916.702

Demolition Plan Notes Before the demolition work is started, contractor shall obtain all permits required by Federal, State, and local jurisdictions for all phases and operations of the Work.

- 2. Burning debris is prohibited.
- The use of explosives is prohibited.
- 4. Protect utilities during the Work of this Section.
- 5. Contractor shall verify the location and status of all utilities within and surrounding the demolition limits.
- 6. Disconnection of all utility services, including sewer, water, gas, and electric lines, and plugging and capping of services shall be in accordance with the requirements of all Municipal and Public Services Corporations.
- 7. Remove and dispose of concrete and bituminous pavement and sidewalk, trees, shrubs, hedges, brush, stumps, roots, dirt, stone, debris, surplus materials and rubbish, as shown or otherwise directed.
- 8. Remove curbs, slabs on grade, and fences as shown or directed otherwise.
- Repair any and all damages or injury to the adjoining properties caused by the work and leave the properties in as good condition as before work was started. The Contractor shall relieve the Owner of all responsibility for any claims due to such injury and shall defend any action brought by reason thereof.
- 10. If so directed, the Contractor shall thoroughly wet the work to prevent dust.
- 11. Protect trees not designated for removal as shown on the Plans.
- 11. Remove demolition debris and excess fill from the project site as soon as practicable.
- 12. Transport demolition debris and excess fill to designated disposal area as soon as practicable. Grade disposal areas to adjacent contours and slope to drain.
- 13. Do not store, sell, or burn materials on Borough property.
- The removal and disposal of materials and debris accumulated by clearing site is regulated under the Solid Waste Management Act (NJSA 13:1 E-1) and is governed by NJAC 7:26 et seq. The Contractor shall dispose of the material and debris according to the solid waste management plan developed by the solid waste management district of origin. Proper documentation from the disposal facility shall be submitted to the Engineer.
- 15. All demolition work shall be in accordance with local, county, state and federal regulations.
- 16. The contractor is specifically cautioned that the location and or records of the various utilities shown on these plans is based on records of the various utility companies and where possible field measurements. The information is not to be relied on as being complete or exact. A ground penetrating radar survey has not been conducted for the project. The contractor must contact all the appropriate utility companies at least 48 hours before any work or excavation to request a field mark out of existing utilities. The contractor must call 1800-242-1000 before commencement of work. It shall be the contractor's responsibility to locate all on site utilities prior to start of demolition work.
- 17. Contractor shall prepare and submit for approval by the owners engineer a plan detailing the locations of the temporary fencing, gates, barricades and other items required to secure the demolition work area and to protect the public. Location of temporary construction fencing and gates shown on plan is approximate and is subject to approval of owner prior to construction. Contractor shall include in his price bid all costs to secure project site with fencing, barricades, and gates.

GENERAL NOTES:

- 1. EXISTING TOPOGRAPHIC AND BOUNDARY SURVEY INFORMATION WAS OBTAINED FROM A PLAN ENTITLED "BOUNDARY AND TOPOGRAPHIC SURVEY, HUDSON COUNTY COMMUNITY COLLEGE, LOTS 2, 3, 4, 11, 12, 13, 14 & 15, BLOCK 10703, CITY OF JERSEY CITY, HUDSON COUNTY, NEW JERSEY" PREAPRED BY NEGLIA ENGINEERING AND ASSOCIATES, DATED MAY 14, 2018.
- 2. DEMOLITION WORK SHALL INCLUDE ITEMS DENOTED ON THIS PLAN AND ANY ADDITIONAL DEMOLITION WORK NECESSARY FOR PROPOSED SITE WORK AS DEPICTED ON THE SITE PLAN DRAWINGS.
- 3. CONTRACTOR SHALL BE ADVISED THAT THERE MAY BE BURIED/BELOW GRADE BUILDING FOUNDATIONS, BURIED/BELOW GRADE CONCRETE WALLS, BURED/BELOW GRADE CONCRETE SLABS ASSOCIATED WITH STRUCTURES THAT PREVIOUSLY EXISTING ON THE PROPERTY. THE LOCATION OF THE PRE-EXISTING BUILDING FOUNDATIONS SHOWN ON THIS PLAN ARE APPROXIMATED AS PER HISTORICAL SANBORN MAPPING. CONTRACTOR SHALL REMOVE ANY BELOW GRADE OBSTRUCTIONS AS NECESSARY TO CONSTRUCT THE PROJECT AS PER PLANS AND SPECIFICATIONS.
- 4. ANY UTILITIES ENCOUNTERED ON SITE THAT ARE TO BE DISCONTINUED SHALL BE CUT/CAPPED AT THE PROPERTY LINE IN ACCORDANCE WITH ALL UTILITY AUTHORITY REQUIREMENTS.

RIM: 88.49

INV(2): 80.59 (10" PVC)

INV(3): 79.09 (10" VCP)

INV(4): 78.19 (18" VCP)

INV(5): 78.09 (18" VCP)

INV(1): 82.49 (10" PVC) INV: 84.35± (BELL)

GR: 87.35

BUILDING FOOTPRINTS PER HISTORICAL

MAPPING. CONTRACTOR SHALL REMOVE

FOUNDATIONS, FOUNDATION WALLS,

BELOW GRADE WALLS, SLABS, ETC) ENCOUNTERED AS NECESSARY TO

(SEE NOTES)

CONSTRUCTION


(SEE NOTES)

FENCE

STREET

ALL BELOW GRADE OBSTRUCTIONS (I.E.

CONSTRUCT THE PROJECT. TYP FOR ALL

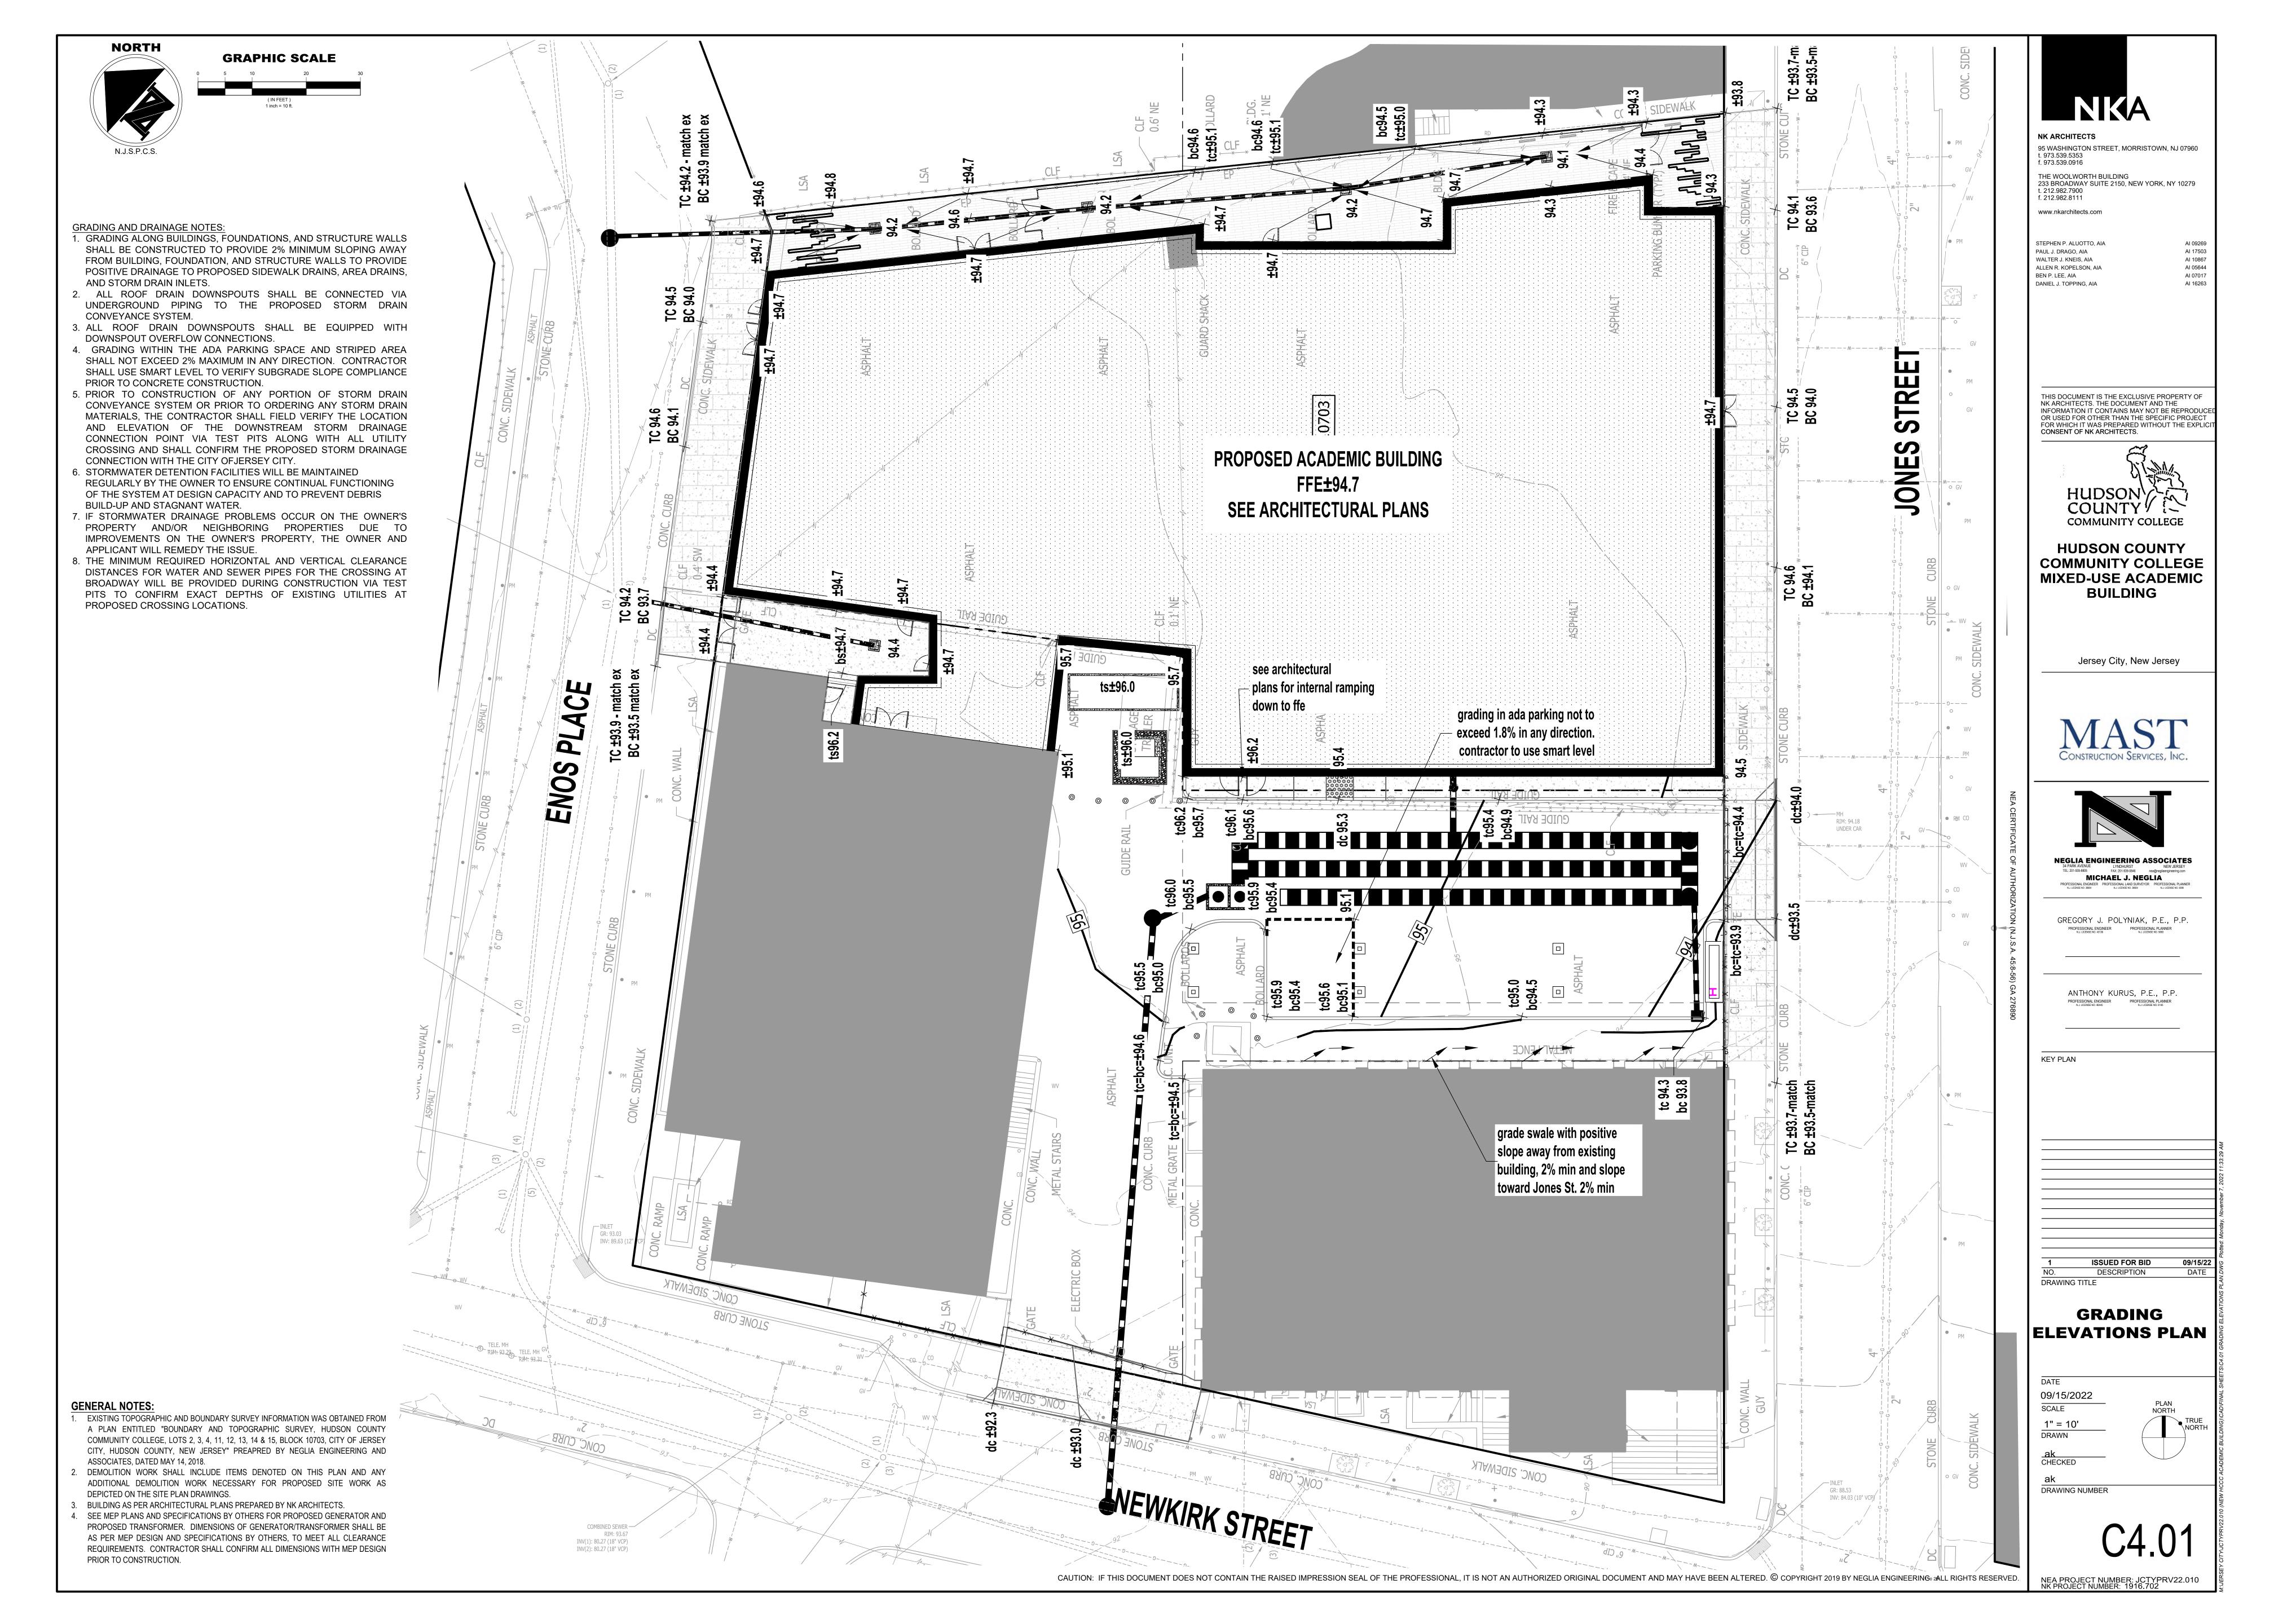





NK ARCHITECTS

FRAMES ARE TO BE INSTALLED, PLACE DOOR AS INDICATED (U.O.N.) CONSTRUCTION. REFER TO DRAWING A0.30 FOR

WHERE NEW DOORS &

PARTITION TYPE. **NEW MASONRY** CONSTRUCTION. REFER TO DRAWING A0.30 FOR PARTITION TYPE. EXISTING WALL TO REMAIN

FEC RECESSED FIRE **EXTINGUISHER** CABINET CONTROL JOINT

- SCOPE OF CONSTRUCTION WORK IS NOT LIMITED TO WORK SHOWN ON CONSTRUCTION DRAWINGS.
- REFER TO DRAWING A0.20 FOR BARRIER FREE DETAILS. ALL PARTITIONS TO BE TYPE 'A0S' UNLESS OTHERWISE
- NOTED ON PLAN. REFER TO DRAWING SERIES A0.30 FOR PARTITION TYPES.
- REFER TO DRAWING SERIES A11.00 FOR TOILET ACCESSORY REFER TO DRAWING SERIES A7.00 FOR DOOR TYPES,
- DETAILS & SCHEDULE. REFER TO DRAWING SERIES A7.10 FOR WINDOW TYPES AND
- REFER TO DRAWING SERIES A10.00 AND/OR SPECIFICATIONS
- FOR FINISH SCHEDULE. REFER TO DRAWING SERIES A11.00 FOR EQUIPMENT
- BOX OUT ALL EXPOSED PIPING, VALVES, AND FITTINGS FROM FLOOR LINE TO A MINIMUM OF 4" ABOVE CEILING LINE
- . PROVIDE MASONRY CONTROL JOINTS AT 30'-0" O.C., MAXIMUM, AT ALL MASONRY WALLS. REFER TO PLANS AND ELEVATIONS FOR JOINT LOCATIONS. IF MASONRY WALL IS PART OF THE STRUCTURAL SHEAR DESIGN, THEN REFER TO STRUCTURAL DRAWINGS FOR LOCATIONS & ADDITIONAL
- PROVIDE CONTROL JOINTS AT 30'-0" O.C., MAXIMUM FOR ALL GYPSUM BOARD PARTITIONS. REFER TO PLANS AND ELEVATIONS FOR JOINT LOCATIONS. IF GYPSUM BOARD WALL IS PART OF THE STRUCTURAL SHEAR DESIGN. THEN REFER TO STRUCTURAL DRAWINGS FOR LOCATIONS &
- B. MAINTAIN INTEGRITY OF ALL EXISTING FIREPROOFING ON ALL STRUCTURAL BEAMS, COLUMNS AND PENETRATIONS. REPAIR AS REQUIRED ON ALL STRUCTURAL STEEL, INCLUDING BUT NOT LIMITED TO BEAMS, COLUMNS AND METAL DECKING; MAINTAIN ALL EXISTING FIRESTOPPING. REPAIR WHEN DAMAGED IN COURSE OF WORK.

KEY NOTES - 1

KEYNOTE #	DESCRIPTION
1	ADA OPERATOR IN PEDESTAL
2	(2) FACE LAYERS AT THE OUTER SIDE OF THE ELEVATOR SHAFT AND STAIRCASE TO BE IMPACT-RESISTANT GYPSUM WALL BOARD W/ MIN. HARD BODY CLASSIFICATION LEVEL 2
3	FACE LAYER AT THE INTERIOR SIDE OF THE ROOM TO BE IMPACT-RESISTANT GYPSUM WALL BOARD W/ MIN. HARD BODY CLASSIFICATION LEVEL 2.
4	MOTORIZED TELESCOPING SEATING PLATFORM SYSTEM AS SPECIFIED
5	PARTITIONS UP TO STRUCTURE OF CATWALK/ FLOOR ABOVE
6	SUSPENDED 1-1/2" SCHED. 40 STL. PIPE GRID (TYP.). REFER TO ENLARGED THEATER SECTION AND DETAILS
7	WALK ALONG DRAPERY TRACK AND CURTAINS. REFER TO ENLARGED THEATER SECTION AND DETAILS
8	GRILLED SECURITY SHUTTER DOOR CEILING MOUNTED AS SPECIFIED
9	3RD LEVEL MEZZANINE MECHANICAL FLOOR AT 44' - 3" AFF. REFER TO ENLARGED FLOOR PLANS
10	MOTORIZED TELESCOPIC SEATING RISER SYSTEM AS SPECIFIED
11	INDOOR LED SCOREBOARD AS SPECIFIED
12	SCORES TABLE
13	RECESSED VOLEYBALL COURT SLEEVES
14	MOTORIZED SIDE-FOLD BASKETBALL BACKSTOP
15	PROTECTIVE WALL PADS AS SPECIFIED
16	3 1/2" MINERAL WOOL INSULATION LAYER PINNED BEHIND SHADOW BOX METAL BACK PAN FROM FLOOR TO UNDERSIDE OF DECK.
17	INTERIOR PARTITION TO BE CENTERED IN COL. GRID AS NOTED.
18	FILL IN FLOOR AROUND DUCT & PIPE PENETRATIONS W/ RATED HORIZ. ASSEMBLY (SEE DETAIL 8/A0.31)
19	INSTALL DUCT LINER ALL AROUND RETURN AIR PLENUM. REFER TO MEP DWGS FOR ADDITIONAL INFORMATION
20	APPROX.CENTER OF MULTIPLE SPORT COURT LAYOUTS.
21	ACCESS LADDER AS SPECIFIED. REFER TO ENLARGED FLOOR PLANS, SECTION AND DETAILS
22	ACCESS LADDER WITH LOCKABLE DOOR AS SPECIFIED. REFER TO ENLARGED FLOOR PLANS SECTION AND DETAILS

95 WASHINGTON STREET, MORRISTOWN, NJ 07960 t. 973.539.5353

THE WOOLWORTH BUILDING 233 BROADWAY SUITE 2150, NEW YORK, NY 10279

www.nkarchitects.com

STEPHEN P. ALUOTTO, AIA PAUL J. DRAGO, AIA WALTER J. KNEIS, AIA ALLEN R. KOPELSON, AIA BEN P. LEE, AIA DANIEL J. TOPPING, AIA

AI 17503

AI 10867

AI 05644

AI 07017

AI 16263

THIS DOCUMENT IS THE EXCLUSIVE PROPERTY OF NK ARCHITECTS. THE DOCUMENT AND THE INFORMATION IT CONTAINS MAY NOT BE REPRODUCED OR USED FOR OTHER THAN THE SPECIFIC PROJECT FOR WHICH IT WAS PREPARED WITHOUT THE EXPLICIT

CONSENT OF NK ARCHITECTS.



HUDSON COUNTY COMMUNITY COLLEGE

MIXED-USE ACADEMIC BUILDING Jersey City, NJ

KEY PLAN


1ST LEVEL FLOOR PLAN


09/15/2022 SCALE 1/8" = 1'-0" DRAWN

CHECKED

DRAWING NUMBER

A1.01

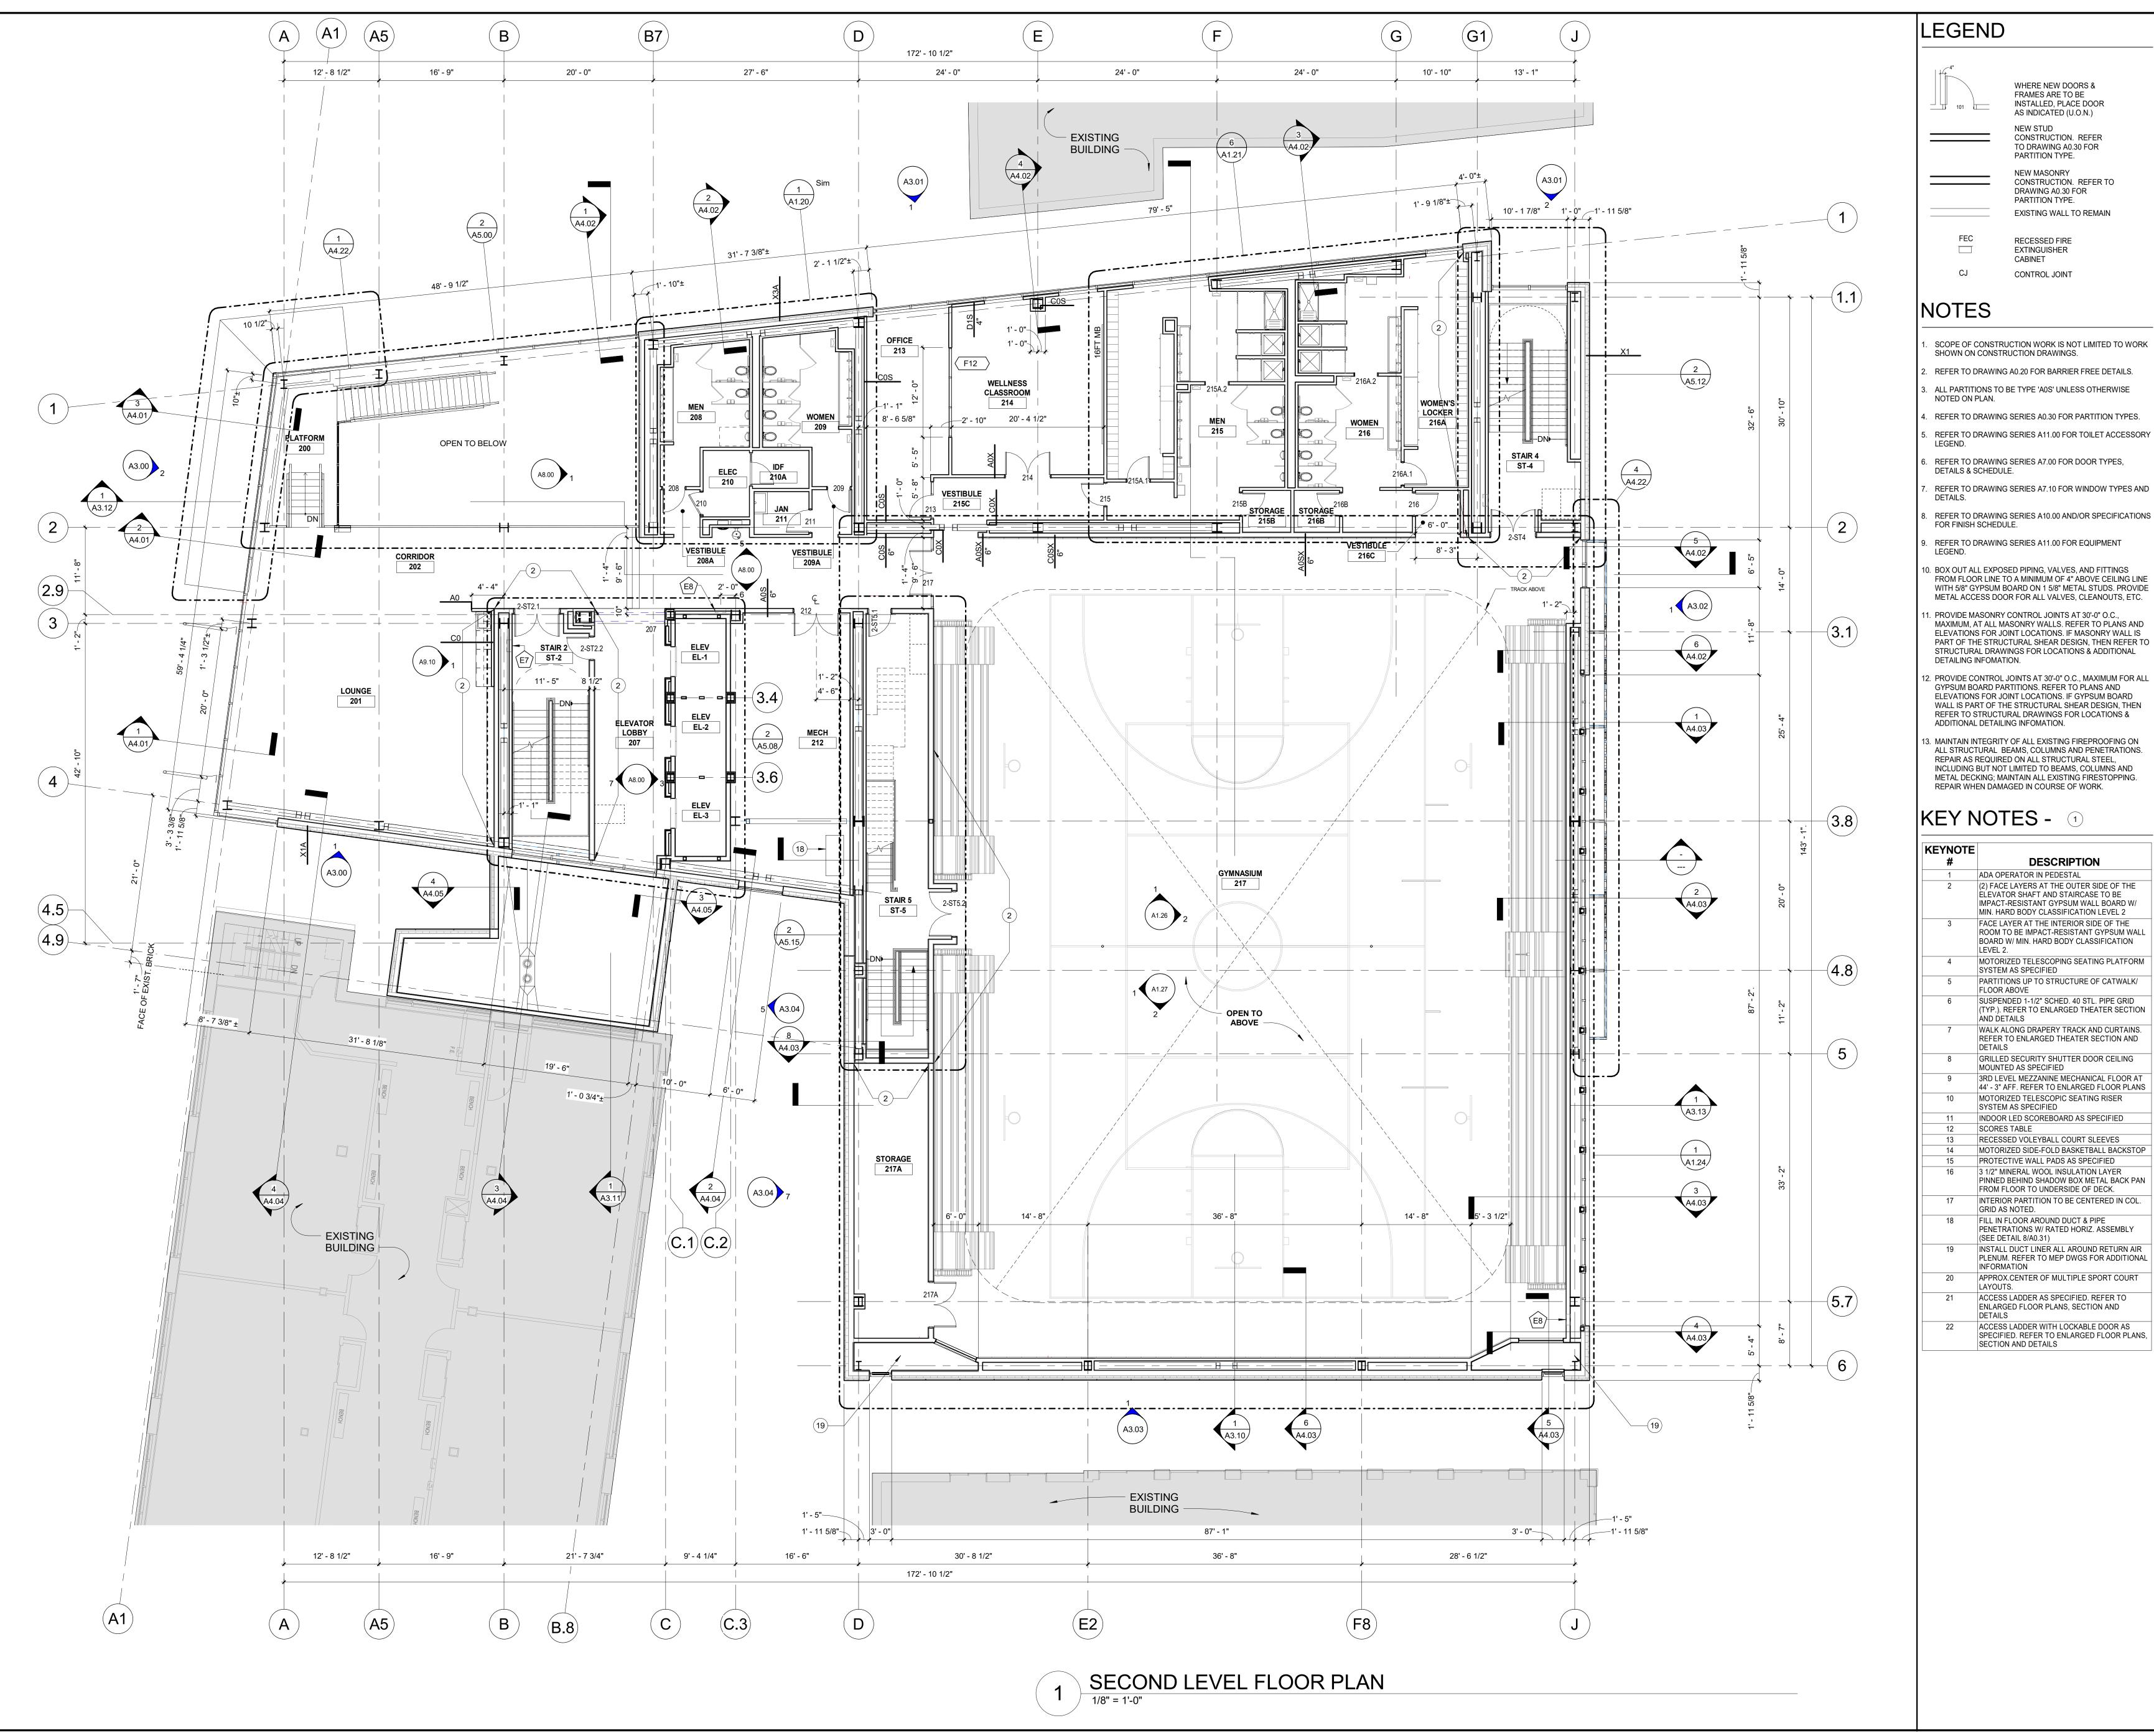

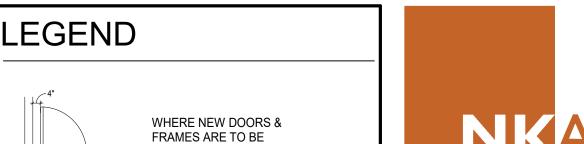

INSTALLED, PLACE DOOR AS INDICATED (U.O.N.)

CONSTRUCTION. REFER

TO DRAWING A0.30 FOR

CONSTRUCTION. REFER TO DRAWING A0.30 FOR

EXISTING WALL TO REMAIN

PARTITION TYPE.

NEW MASONRY

PARTITION TYPE.

RECESSED FIRE

EXTINGUISHER

CONTROL JOINT

CABINET

NK ARCHITECTS 95 WASHINGTON STREET, MORRISTOWN, NJ 07960

THE WOOLWORTH BUILDING 233 BROADWAY SUITE 2150, NEW YORK, NY 10279

> www.nkarchitects.com STEPHEN P. ALUOTTO, AIA

PAUL J. DRAGO, AIA WALTER J. KNEIS, AIA ALLEN R. KOPELSON, AIA BEN P. LEE, AIA DANIEL J. TOPPING, AIA

AI 17503

AI 10867

AI 05644

AI 07017

AI 16263

THIS DOCUMENT IS THE EXCLUSIVE PROPERTY OF NK ARCHITECTS. THE DOCUMENT AND THE INFORMATION IT CONTAINS MAY NOT BE REPRODUCED OR USED FOR OTHER THAN THE SPECIFIC PROJECT FOR WHICH IT WAS PREPARED WITHOUT THE EXPLICIT CONSENT OF NK ARCHITECTS.

COMMUNITY COLLEGE

HUDSON COUNTY COMMUNITY COLLEGE

MIXED-USE

ACADEMIC

BUILDING

PART OF THE STRUCTURAL SHEAR DESIGN, THEN REFER TO STRUCTURAL DRAWINGS FOR LOCATIONS & ADDITIONAL DETAILING INFOMATION. PROVIDE CONTROL JOINTS AT 30'-0" O.C., MAXIMUM FOR ALL GYPSUM BOARD PARTITIONS. REFER TO PLANS AND ELEVATIONS FOR JOINT LOCATIONS. IF GYPSUM BOARD

WALL IS PART OF THE STRUCTURAL SHEAR DESIGN, THEN REFER TO STRUCTURAL DRAWINGS FOR LOCATIONS & ADDITIONAL DETAILING INFOMATION. B. MAINTAIN INTEGRITY OF ALL EXISTING FIREPROOFING ON

ALL STRUCTURAL BEAMS, COLUMNS AND PENETRATIONS. REPAIR AS REQUIRED ON ALL STRUCTURAL STEEL, INCLUDING BUT NOT LIMITED TO BEAMS, COLUMNS AND METAL DECKING; MAINTAIN ALL EXISTING FIRESTOPPING. REPAIR WHEN DAMAGED IN COURSE OF WORK.

KEY NOTES - 1

KEYNOTE #	DESCRIPTION
1	ADA OPERATOR IN PEDESTAL
2	(2) FACE LAYERS AT THE OUTER SIDE OF THE ELEVATOR SHAFT AND STAIRCASE TO BE IMPACT-RESISTANT GYPSUM WALL BOARD W/ MIN. HARD BODY CLASSIFICATION LEVEL 2
3	FACE LAYER AT THE INTERIOR SIDE OF THE ROOM TO BE IMPACT-RESISTANT GYPSUM WALL BOARD W/ MIN. HARD BODY CLASSIFICATION LEVEL 2.
4	MOTORIZED TELESCOPING SEATING PLATFORM SYSTEM AS SPECIFIED
5	PARTITIONS UP TO STRUCTURE OF CATWALK/ FLOOR ABOVE
6	SUSPENDED 1-1/2" SCHED. 40 STL. PIPE GRID (TYP.). REFER TO ENLARGED THEATER SECTION AND DETAILS
7	WALK ALONG DRAPERY TRACK AND CURTAINS. REFER TO ENLARGED THEATER SECTION AND DETAILS
8	GRILLED SECURITY SHUTTER DOOR CEILING MOUNTED AS SPECIFIED
9	3RD LEVEL MEZZANINE MECHANICAL FLOOR AT 44' - 3" AFF. REFER TO ENLARGED FLOOR PLANS
10	MOTORIZED TELESCOPIC SEATING RISER SYSTEM AS SPECIFIED
11	INDOOR LED SCOREBOARD AS SPECIFIED
12	SCORES TABLE
13	RECESSED VOLEYBALL COURT SLEEVES
14	MOTORIZED SIDE-FOLD BASKETBALL BACKSTOP
15	PROTECTIVE WALL PADS AS SPECIFIED
16	3 1/2" MINERAL WOOL INSULATION LAYER PINNED BEHIND SHADOW BOX METAL BACK PAN FROM FLOOR TO UNDERSIDE OF DECK.
17	INTERIOR PARTITION TO BE CENTERED IN COL. GRID AS NOTED.
18	FILL IN FLOOR AROUND DUCT & PIPE PENETRATIONS W/ RATED HORIZ. ASSEMBLY (SEE DETAIL 8/A0.31)
19	INSTALL DUCT LINER ALL AROUND RETURN AIR PLENUM. REFER TO MEP DWGS FOR ADDITIONAL INFORMATION
20	APPROX.CENTER OF MULTIPLE SPORT COURT LAYOUTS.
21	ACCESS LADDER AS SPECIFIED. REFER TO ENLARGED FLOOR PLANS, SECTION AND DETAILS
22	ACCESS LADDER WITH LOCKABLE DOOR AS SPECIFIED. REFER TO ENLARGED FLOOR PLANS SECTION AND DETAILS

Jersey City, NJ

KEY PLAN


2ND LEVEL FLOOR PLAN

09/15/2022 SCALE 1/8" = 1'-0" DRAWN Author

CHECKED


Checker DRAWING NUMBER

A1.02

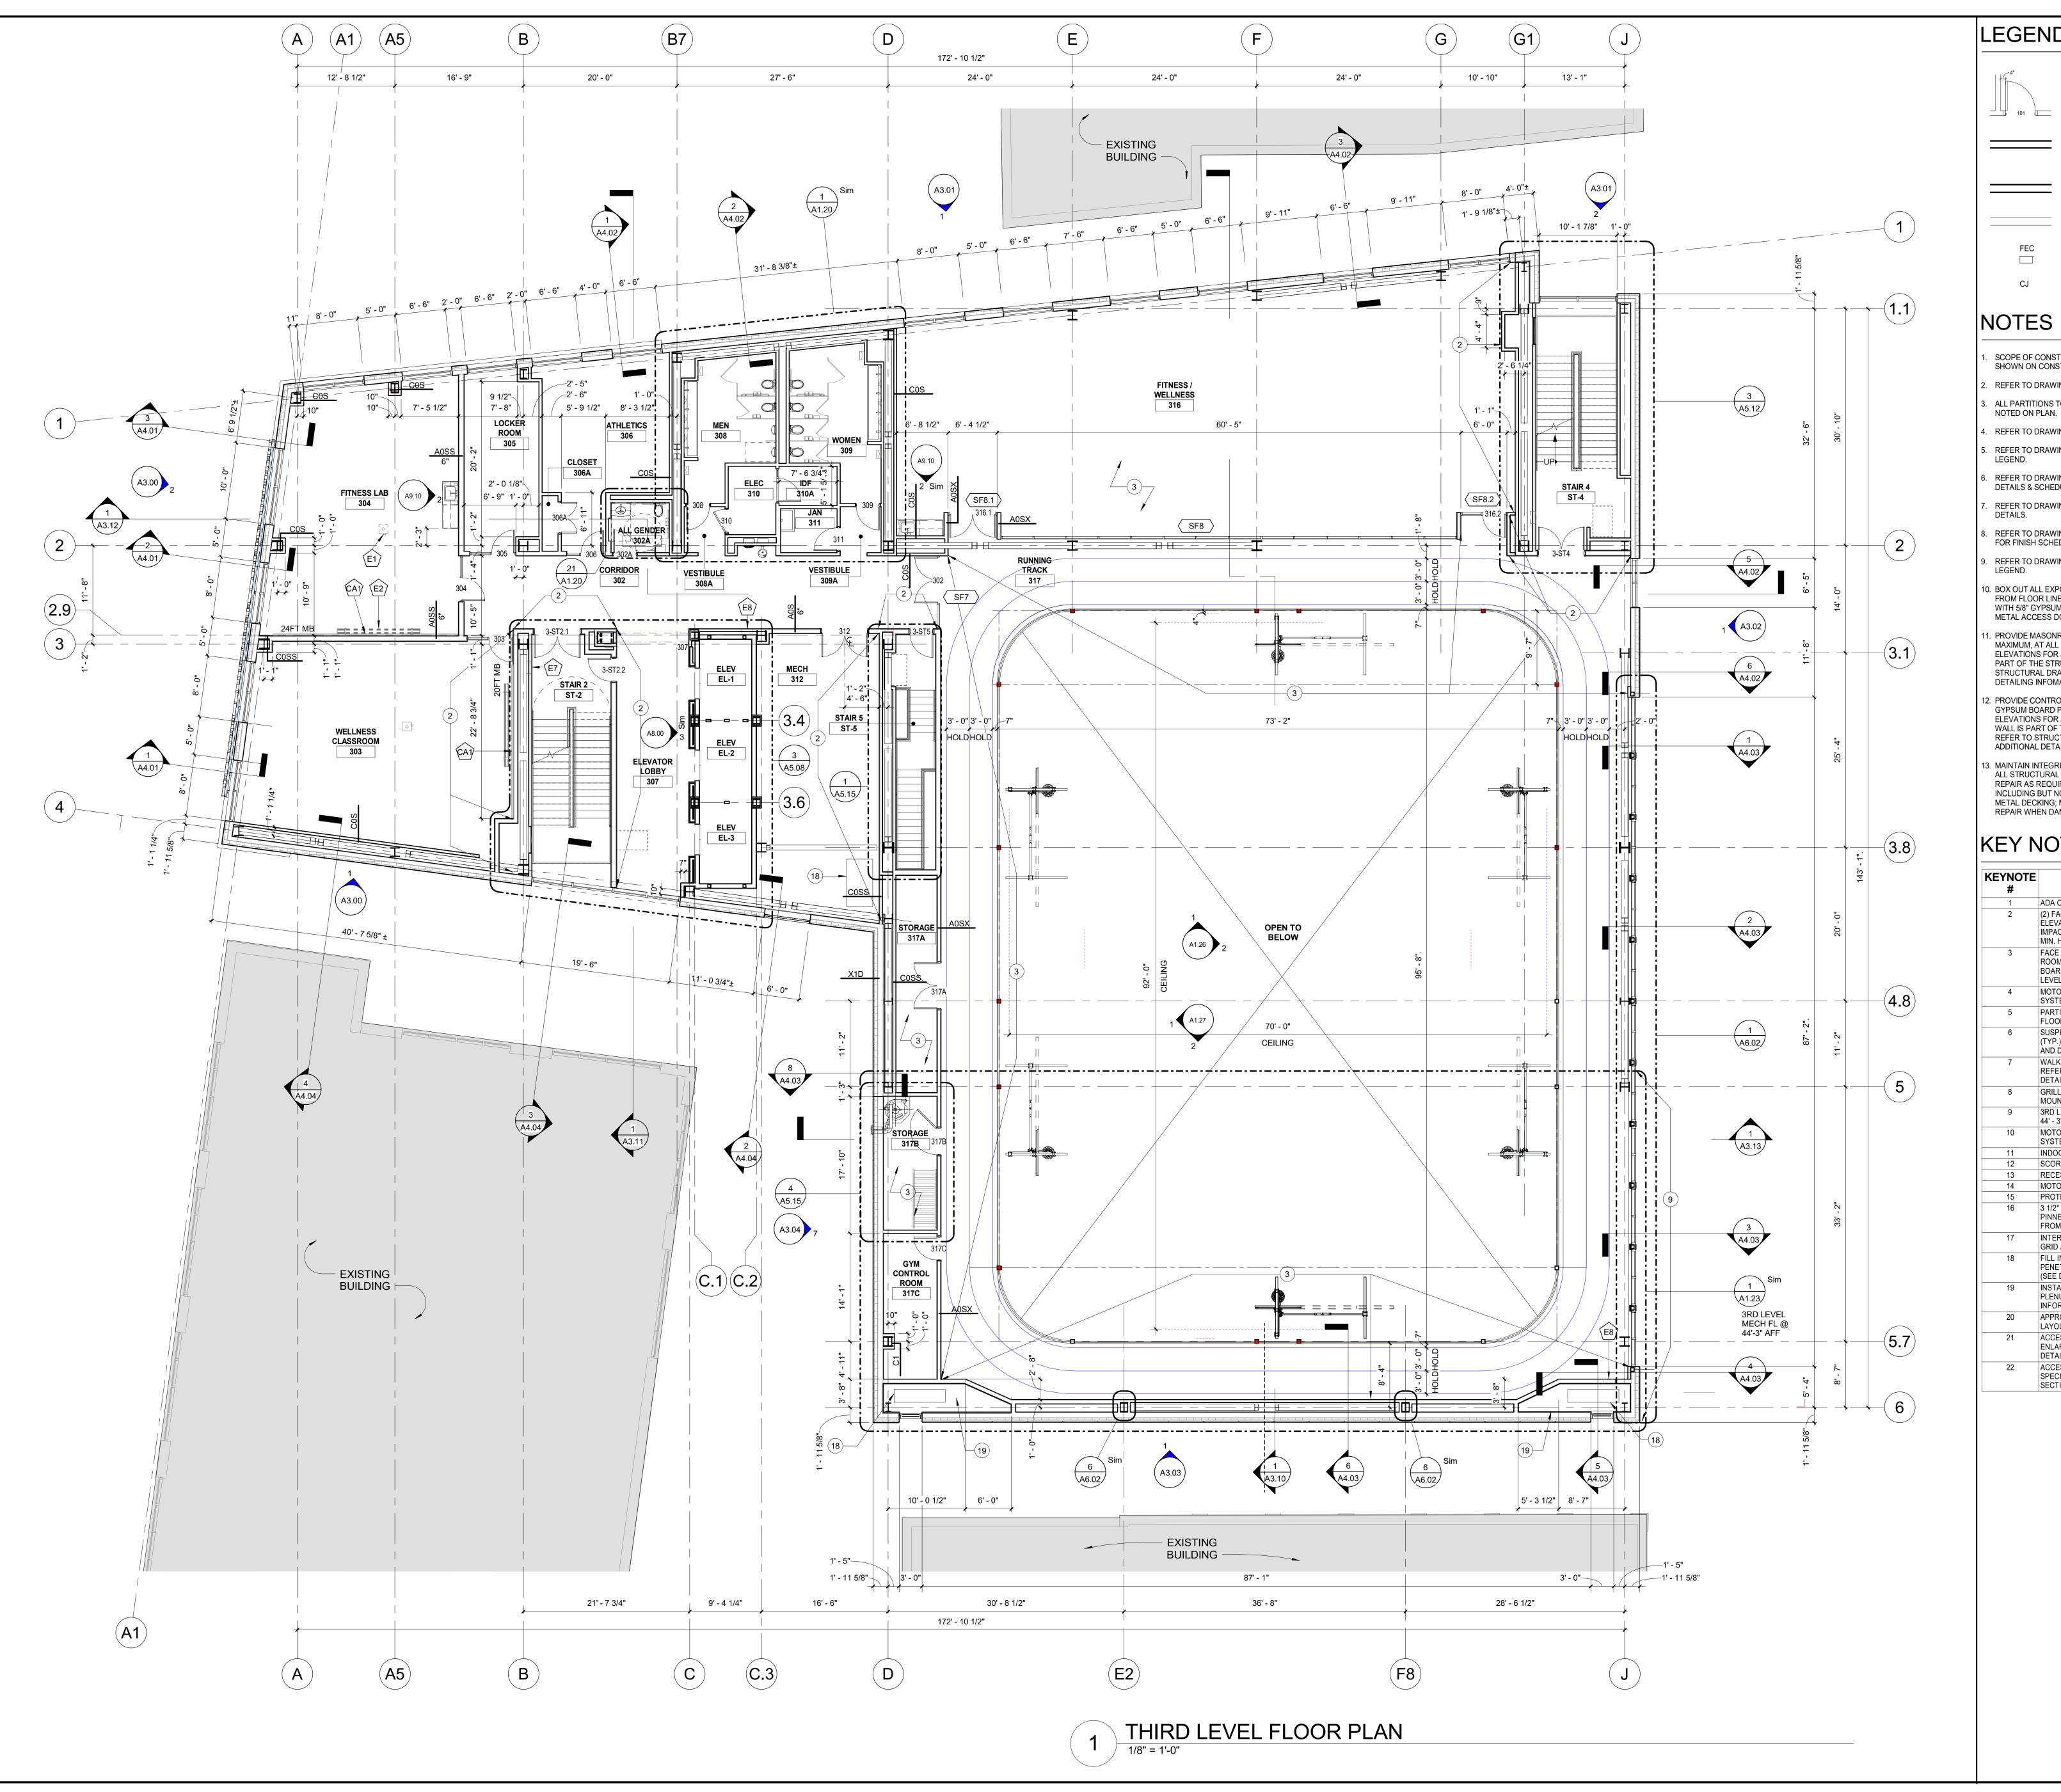


LEGEND

WHERE NEW DOORS & FRAMES ARE TO BE INSTALLED, PLACE DOOR AS INDICATED (U.O.N.) CONSTRUCTION. REFER TO DRAWING A0.30 FOR PARTITION TYPE.

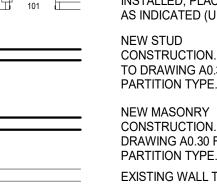

CONSTRUCTION. REFER TO DRAWING A0.30 FOR PARTITION TYPE. EXISTING WALL TO REMAIN FEC RECESSED FIRE EXTINGUISHER

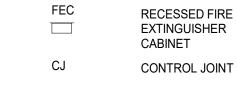

NOTES

- SCOPE OF CONSTRUCTION WORK IS NOT LIMITED TO WORK SHOWN ON CONSTRUCTION DRAWINGS.
- REFER TO DRAWING A0.20 FOR BARRIER FREE DETAILS. ALL PARTITIONS TO BE TYPE 'A0S' UNLESS OTHERWISE
- REFER TO DRAWING SERIES A0.30 FOR PARTITION TYPES. REFER TO DRAWING SERIES A11.00 FOR TOILET ACCESSORY
- REFER TO DRAWING SERIES A7.00 FOR DOOR TYPES, DETAILS & SCHEDULE.
- REFER TO DRAWING SERIES A7.10 FOR WINDOW TYPES AND DETAILS.
- REFER TO DRAWING SERIES A10.00 AND/OR SPECIFICATIONS FOR FINISH SCHEDULE.
- REFER TO DRAWING SERIES A11.00 FOR EQUIPMENT
- D. BOX OUT ALL EXPOSED PIPING, VALVES, AND FITTINGS FROM FLOOR LINE TO A MINIMUM OF 4" ABOVE CEILING LINE WITH 5/8" GYPSUM BOARD ON 1 5/8" METAL STUDS. PROVIDE METAL ACCESS DOOR FOR ALL VALVES, CLEANOUTS, ETC.
- . PROVIDE MASONRY CONTROL JOINTS AT 30'-0" O.C., MAXIMUM, AT ALL MASONRY WALLS. REFER TO PLANS AND ELEVATIONS FOR JOINT LOCATIONS. IF MASONRY WALL IS PART OF THE STRUCTURAL SHEAR DESIGN, THEN REFER TO STRUCTURAL DRAWINGS FOR LOCATIONS & ADDITIONAL DETAILING INFOMATION.
- PROVIDE CONTROL JOINTS AT 30'-0" O.C., MAXIMUM FOR ALL GYPSUM BOARD PARTITIONS. REFER TO PLANS AND ELEVATIONS FOR JOINT LOCATIONS. IF GYPSUM BOARD WALL IS PART OF THE STRUCTURAL SHEAR DESIGN, THEN REFER TO STRUCTURAL DRAWINGS FOR LOCATIONS & ADDITIONAL DETAILING INFOMATION.
- B. MAINTAIN INTEGRITY OF ALL EXISTING FIREPROOFING ON ALL STRUCTURAL BEAMS, COLUMNS AND PENETRATIONS.
 REPAIR AS REQUIRED ON ALL STRUCTURAL STEEL, INCLUDING BUT NOT LIMITED TO BEAMS, COLUMNS AND METAL DECKING; MAINTAIN ALL EXISTING FIRESTOPPING. REPAIR WHEN DAMAGED IN COURSE OF WORK.

KEY NOTES - 1

KEYNOTE #	DESCRIPTION
1	ADA OPERATOR IN PEDESTAL
2	(2) FACE LAYERS AT THE OUTER SIDE OF THE ELEVATOR SHAFT AND STAIRCASE TO BE IMPACT-RESISTANT GYPSUM WALL BOARD W/MIN. HARD BODY CLASSIFICATION LEVEL 2
3	FACE LAYER AT THE INTERIOR SIDE OF THE ROOM TO BE IMPACT-RESISTANT GYPSUM WALL BOARD W/ MIN. HARD BODY CLASSIFICATION LEVEL 2.
4	MOTORIZED TELESCOPING SEATING PLATFORM SYSTEM AS SPECIFIED
5	PARTITIONS UP TO STRUCTURE OF CATWALK/ FLOOR ABOVE
6	SUSPENDED 1-1/2" SCHED. 40 STL. PIPE GRID (TYP.). REFER TO ENLARGED THEATER SECTION AND DETAILS
7	WALK ALONG DRAPERY TRACK AND CURTAINS. REFER TO ENLARGED THEATER SECTION AND DETAILS
8	GRILLED SECURITY SHUTTER DOOR CEILING MOUNTED AS SPECIFIED
9	3RD LEVEL MEZZANINE MECHANICAL FLOOR AT 44' - 3" AFF. REFER TO ENLARGED FLOOR PLANS
10	MOTORIZED TELESCOPIC SEATING RISER SYSTEM AS SPECIFIED
11	INDOOR LED SCOREBOARD AS SPECIFIED
12	SCORES TABLE
13	RECESSED VOLEYBALL COURT SLEEVES
14	MOTORIZED SIDE-FOLD BASKETBALL BACKSTOP
15	PROTECTIVE WALL PADS AS SPECIFIED
16	3 1/2" MINERAL WOOL INSULATION LAYER PINNED BEHIND SHADOW BOX METAL BACK PAN FROM FLOOR TO UNDERSIDE OF DECK.
17	INTERIOR PARTITION TO BE CENTERED IN COL. GRID AS NOTED.
18	FILL IN FLOOR AROUND DUCT & PIPE PENETRATIONS W/ RATED HORIZ. ASSEMBLY (SEE DETAIL 8/A0.31)
19	INSTALL DUCT LINER ALL AROUND RETURN AIR PLENUM. REFER TO MEP DWGS FOR ADDITIONAL INFORMATION
20	APPROX.CENTER OF MULTIPLE SPORT COURT LAYOUTS.
21	ACCESS LADDER AS SPECIFIED. REFER TO ENLARGED FLOOR PLANS, SECTION AND DETAILS
22	ACCESS LADDER WITH LOCKABLE DOOR AS SPECIFIED. REFER TO ENLARGED FLOOR PLANS, SECTION AND DETAILS



NK ARCHITECTS 95 WASHINGTON STREET, MORRISTOWN, NJ 07960 t. 973.539.5353 f. 973.539.0916

THE WOOLWORTH BUILDING 233 BROADWAY SUITE 2150, NEW YORK, NY 10279

www.nkarchitects.com

STEPHEN P. ALUOTTO, AIA PAUL J. DRAGO, AIA WALTER J. KNEIS, AIA ALLEN R. KOPELSON, AIA BEN P. LEE, AIA DANIEL J. TOPPING, AIA

AI 17503

AI 10867

AI 05644

AI 07017

AI 16263

THIS DOCUMENT IS THE EXCLUSIVE PROPERTY OF NK ARCHITECTS. THE DOCUMENT AND THE INFORMATION IT CONTAINS MAY NOT BE REPRODUCED OR USED FOR OTHER THAN THE SPECIFIC PROJECT FOR WHICH IT WAS PREPARED WITHOUT THE EXPLICIT CONSENT OF NK ARCHITECTS.



HUDSON COUNTY COMMUNITY COLLEGE

> **MIXED-USE ACADEMIC BUILDING** Jersey City, NJ


KEY PLAN

3RD LEVEL FLOOR PLAN

09/15/2022 SCALE 1/8" = 1'-0" DRAWN Author CHECKED

Checker DRAWING NUMBER

A1.03

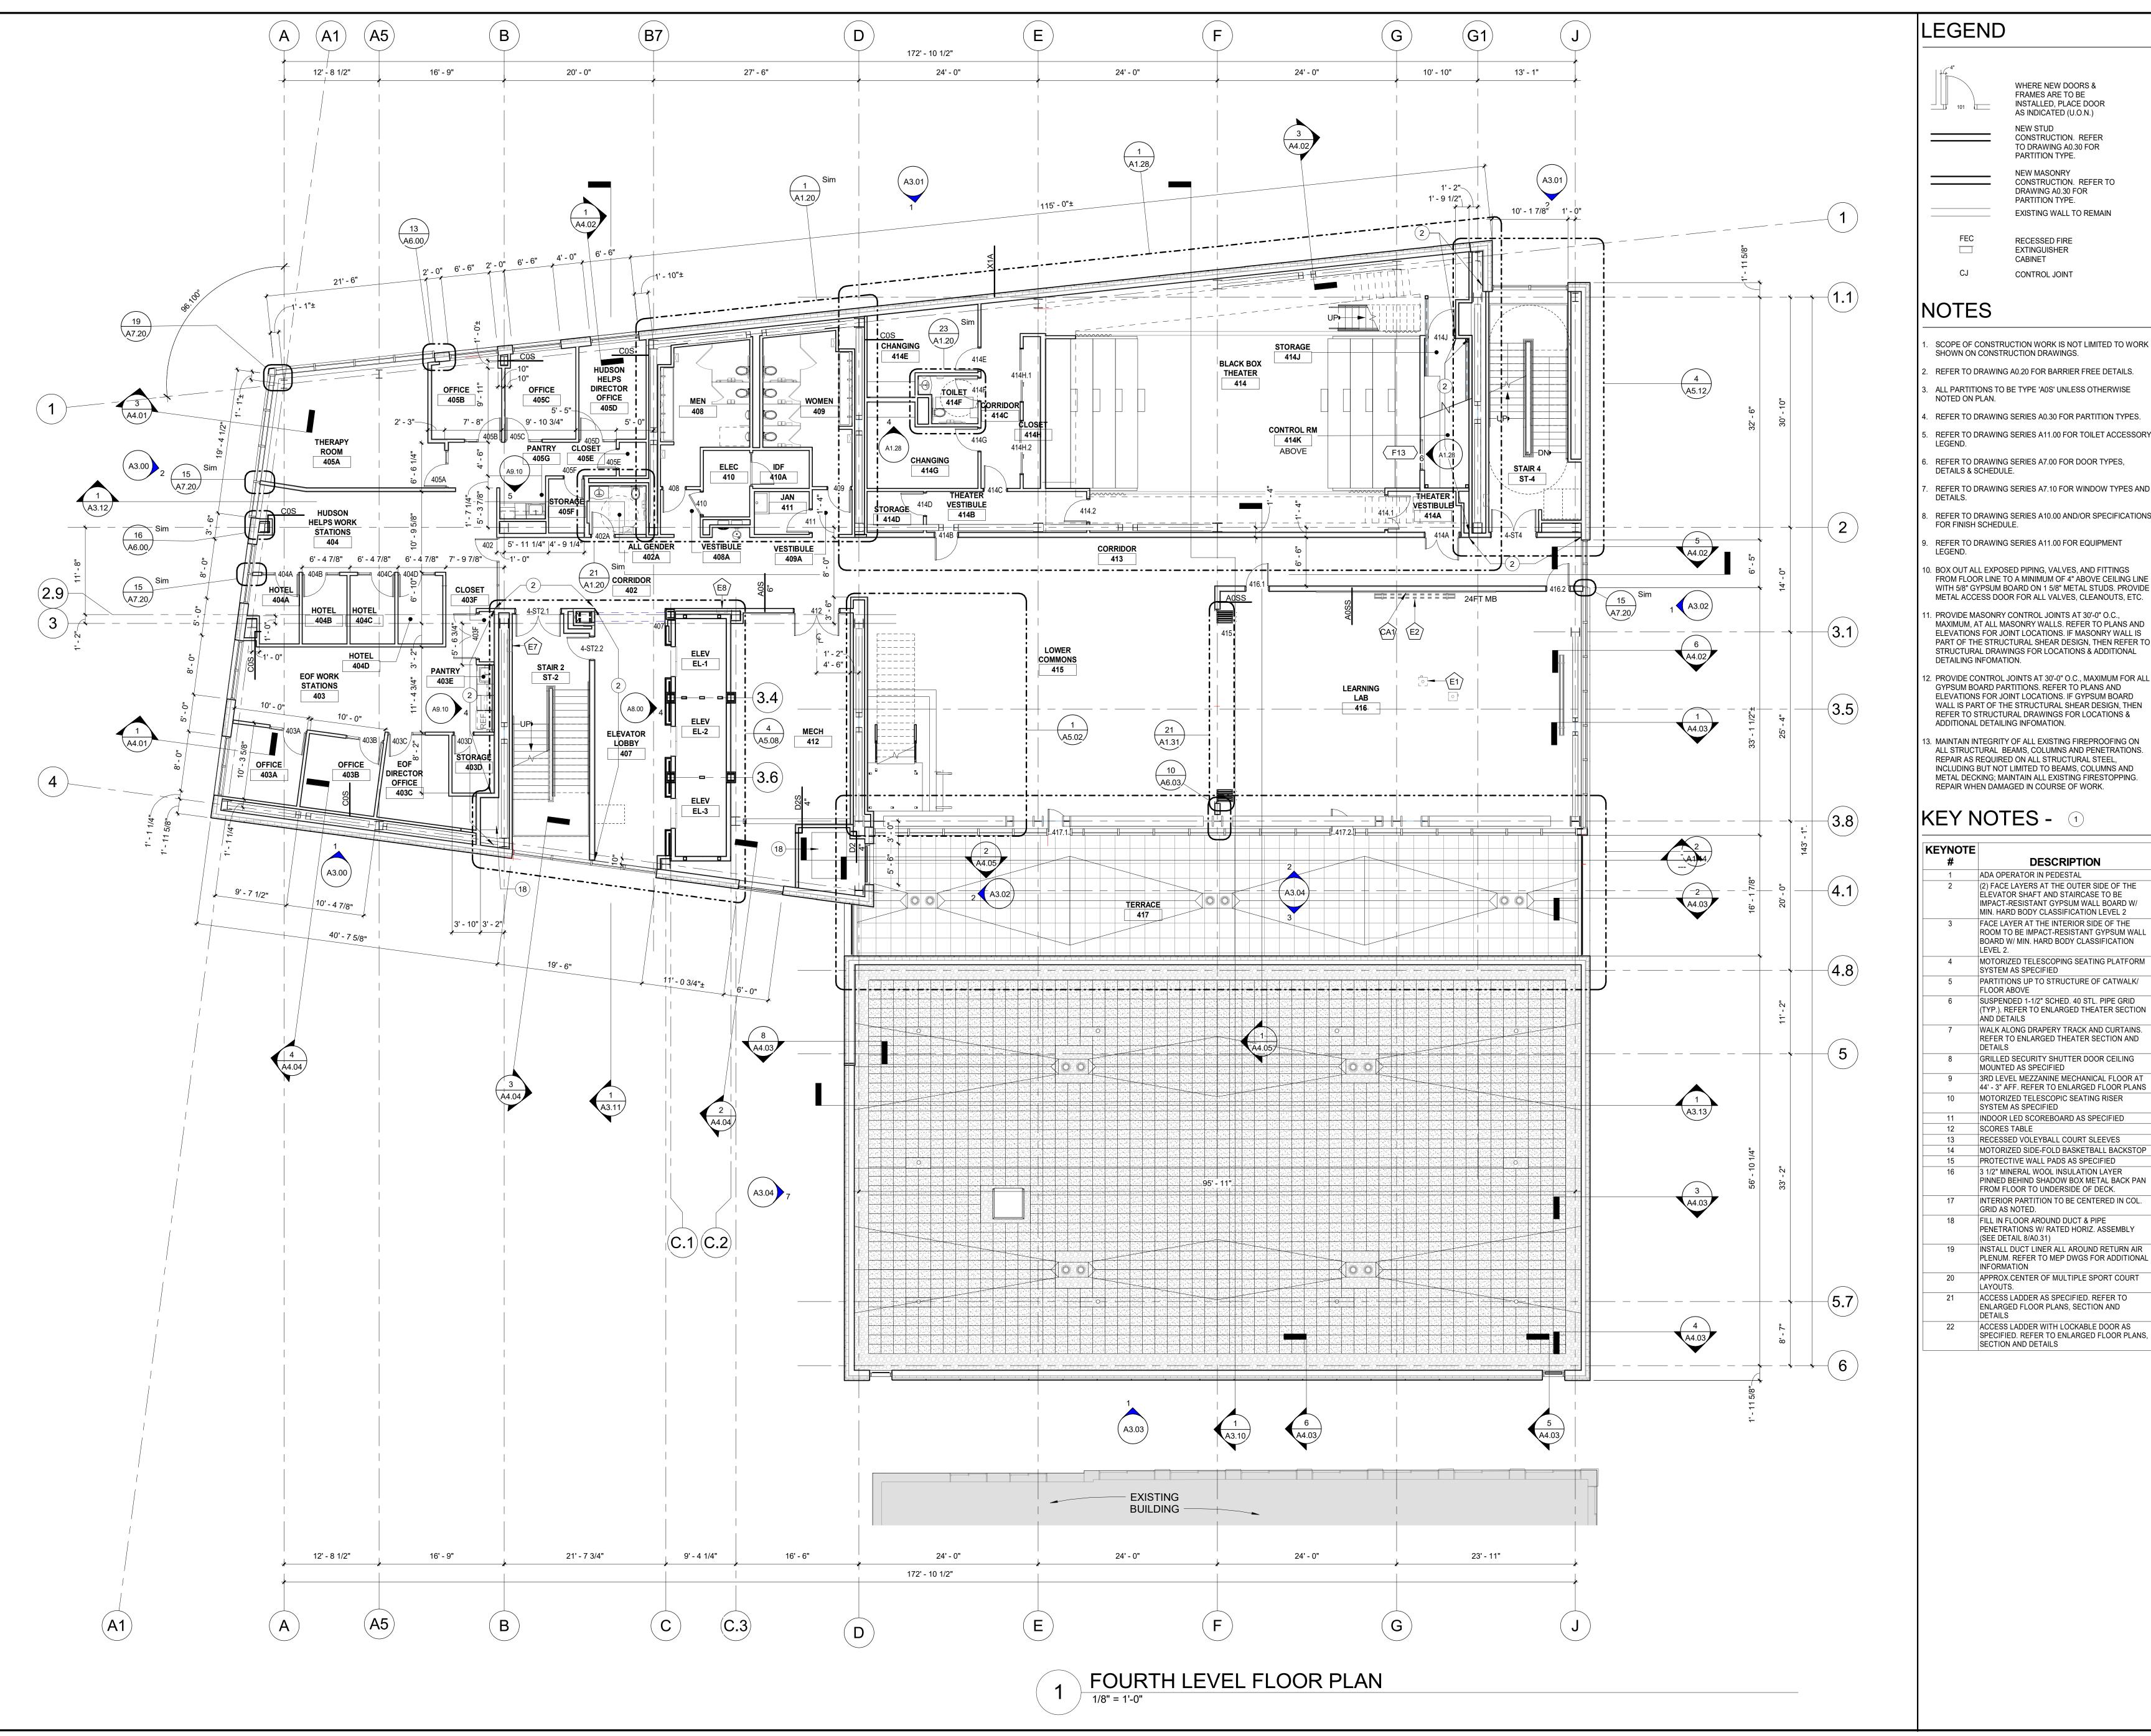

LEGEND

NK ARCHITECTS

www.nkarchitects.com

INSTALLED, PLACE DOOR AS INDICATED (U.O.N.) CONSTRUCTION. REFER TO DRAWING A0.30 FOR PARTITION TYPE.

WHERE NEW DOORS & FRAMES ARE TO BE

NEW MASONRY CONSTRUCTION. REFER TO DRAWING A0.30 FOR PARTITION TYPE. EXISTING WALL TO REMAIN

FEC RECESSED FIRE EXTINGUISHER CABINET CONTROL JOINT

- SCOPE OF CONSTRUCTION WORK IS NOT LIMITED TO WORK SHOWN ON CONSTRUCTION DRAWINGS.
- REFER TO DRAWING A0.20 FOR BARRIER FREE DETAILS. ALL PARTITIONS TO BE TYPE 'A0S' UNLESS OTHERWISE
- NOTED ON PLAN. REFER TO DRAWING SERIES A0.30 FOR PARTITION TYPES.
- REFER TO DRAWING SERIES A7.00 FOR DOOR TYPES, DETAILS & SCHEDULE.
- REFER TO DRAWING SERIES A7.10 FOR WINDOW TYPES AND
- REFER TO DRAWING SERIES A10.00 AND/OR SPECIFICATIONS FOR FINISH SCHEDULE.
- REFER TO DRAWING SERIES A11.00 FOR EQUIPMENT
- BOX OUT ALL EXPOSED PIPING, VALVES, AND FITTINGS FROM FLOOR LINE TO A MINIMUM OF 4" ABOVE CEILING LINE WITH 5/8" GYPSUM BOARD ON 1 5/8" METAL STUDS. PROVIDE METAL ACCESS DOOR FOR ALL VALVES, CLEANOUTS, ETC.
- . PROVIDE MASONRY CONTROL JOINTS AT 30'-0" O.C., MAXIMUM, AT ALL MASONRY WALLS. REFER TO PLANS AND ELEVATIONS FOR JOINT LOCATIONS. IF MASONRY WALL IS PART OF THE STRUCTURAL SHEAR DESIGN, THEN REFER TO STRUCTURAL DRAWINGS FOR LOCATIONS & ADDITIONAL DETAILING INFOMATION.
- PROVIDE CONTROL JOINTS AT 30'-0" O.C., MAXIMUM FOR ALL GYPSUM BOARD PARTITIONS. REFER TO PLANS AND ELEVATIONS FOR JOINT LOCATIONS. IF GYPSUM BOARD WALL IS PART OF THE STRUCTURAL SHEAR DESIGN, THEN REFER TO STRUCTURAL DRAWINGS FOR LOCATIONS &
- ALL STRUCTURAL BEAMS, COLUMNS AND PENETRATIONS. REPAIR AS REQUIRED ON ALL STRUCTURAL STEEL, METAL DECKING; MAINTAIN ALL EXISTING FIRESTOPPING. REPAIR WHEN DAMAGED IN COURSE OF WORK.

KEYNOTE #	DESCRIPTION
1	ADA OPERATOR IN PEDESTAL
2	(2) FACE LAYERS AT THE OUTER SIDE OF THE ELEVATOR SHAFT AND STAIRCASE TO BE IMPACT-RESISTANT GYPSUM WALL BOARD W/MIN. HARD BODY CLASSIFICATION LEVEL 2
3	FACE LAYER AT THE INTERIOR SIDE OF THE ROOM TO BE IMPACT-RESISTANT GYPSUM WALL BOARD W/ MIN. HARD BODY CLASSIFICATION LEVEL 2.
4	MOTORIZED TELESCOPING SEATING PLATFORM SYSTEM AS SPECIFIED
5	PARTITIONS UP TO STRUCTURE OF CATWALK/ FLOOR ABOVE
6	SUSPENDED 1-1/2" SCHED. 40 STL. PIPE GRID (TYP.). REFER TO ENLARGED THEATER SECTION AND DETAILS
7	WALK ALONG DRAPERY TRACK AND CURTAINS. REFER TO ENLARGED THEATER SECTION AND DETAILS
8	GRILLED SECURITY SHUTTER DOOR CEILING MOUNTED AS SPECIFIED
9	3RD LEVEL MEZZANINE MECHANICAL FLOOR AT 44' - 3" AFF. REFER TO ENLARGED FLOOR PLAN
10	MOTORIZED TELESCOPIC SEATING RISER SYSTEM AS SPECIFIED
11	INDOOR LED SCOREBOARD AS SPECIFIED
12	SCORES TABLE
13	RECESSED VOLEYBALL COURT SLEEVES
14	MOTORIZED SIDE-FOLD BASKETBALL BACKSTO
15	PROTECTIVE WALL PADS AS SPECIFIED
16	3 1/2" MINERAL WOOL INSULATION LAYER PINNED BEHIND SHADOW BOX METAL BACK PAPEROM FLOOR TO UNDERSIDE OF DECK.
17	INTERIOR PARTITION TO BE CENTERED IN COL. GRID AS NOTED.
18	FILL IN FLOOR AROUND DUCT & PIPE PENETRATIONS W/ RATED HORIZ. ASSEMBLY (SEE DETAIL 8/A0.31)
19	INSTALL DUCT LINER ALL AROUND RETURN AIR PLENUM. REFER TO MEP DWGS FOR ADDITIONAL INFORMATION
20	APPROX.CENTER OF MULTIPLE SPORT COURT LAYOUTS.
21	ACCESS LADDER AS SPECIFIED. REFER TO ENLARGED FLOOR PLANS, SECTION AND DETAILS
22	ACCESS LADDER WITH LOCKABLE DOOR AS SPECIFIED. REFER TO ENLARGED FLOOR PLANS SECTION AND DETAILS

95 WASHINGTON STREET, MORRISTOWN, NJ 07960 t. 973.539.5353 f. 973.539.0916

THE WOOLWORTH BUILDING 233 BROADWAY SUITE 2150, NEW YORK, NY 10279

STEPHEN P. ALUOTTO, AIA PAUL J. DRAGO, AIA WALTER J. KNEIS, AIA ALLEN R. KOPELSON, AIA BEN P. LEE, AIA DANIEL J. TOPPING, AIA

CONSENT OF NK ARCHITECTS.

THIS DOCUMENT IS THE EXCLUSIVE PROPERTY OF NK ARCHITECTS. THE DOCUMENT AND THE INFORMATION IT CONTAINS MAY NOT BE REPRODUCED OR USED FOR OTHER THAN THE SPECIFIC PROJECT FOR WHICH IT WAS PREPARED WITHOUT THE EXPLICIT

AI 17503

AI 10867

AI 05644

AI 07017

AI 16263



HUDSON COUNTY COMMUNITY COLLEGE

MIXED-USE ACADEMIC BUILDING Jersey City, NJ

B. MAINTAIN INTEGRITY OF ALL EXISTING FIREPROOFING ON

KEY NOTES - 1

EYNOTE	
#	DESCRIPTION
1	ADA OPERATOR IN PEDESTAL
2	(2) FACE LAYERS AT THE OUTER SIDE OF THE ELEVATOR SHAFT AND STAIRCASE TO BE IMPACT-RESISTANT GYPSUM WALL BOARD W/MIN. HARD BODY CLASSIFICATION LEVEL 2
3	FACE LAYER AT THE INTERIOR SIDE OF THE ROOM TO BE IMPACT-RESISTANT GYPSUM WALL BOARD W/ MIN. HARD BODY CLASSIFICATION LEVEL 2.
4	MOTORIZED TELESCOPING SEATING PLATFORM SYSTEM AS SPECIFIED
5	PARTITIONS UP TO STRUCTURE OF CATWALK/ FLOOR ABOVE
6	SUSPENDED 1-1/2" SCHED. 40 STL. PIPE GRID (TYP.). REFER TO ENLARGED THEATER SECTION AND DETAILS
7	WALK ALONG DRAPERY TRACK AND CURTAINS. REFER TO ENLARGED THEATER SECTION AND DETAILS
8	GRILLED SECURITY SHUTTER DOOR CEILING MOUNTED AS SPECIFIED
9	3RD LEVEL MEZZANINE MECHANICAL FLOOR AT 44' - 3" AFF. REFER TO ENLARGED FLOOR PLANS
10	MOTORIZED TELESCOPIC SEATING RISER SYSTEM AS SPECIFIED
11	INDOOR LED SCOREBOARD AS SPECIFIED
12	SCORES TABLE
13	RECESSED VOLEYBALL COURT SLEEVES
14	MOTORIZED SIDE-FOLD BASKETBALL BACKSTOP
15	PROTECTIVE WALL PADS AS SPECIFIED
16	3 1/2" MINERAL WOOL INSULATION LAYER PINNED BEHIND SHADOW BOX METAL BACK PAN FROM FLOOR TO UNDERSIDE OF DECK.
17	INTERIOR PARTITION TO BE CENTERED IN COL. GRID AS NOTED.
18	FILL IN FLOOR AROUND DUCT & PIPE PENETRATIONS W/ RATED HORIZ. ASSEMBLY (SEE DETAIL 8/A0.31)
19	INSTALL DUCT LINER ALL AROUND RETURN AIR PLENUM. REFER TO MEP DWGS FOR ADDITIONAL INFORMATION
20	APPROX.CENTER OF MULTIPLE SPORT COURT LAYOUTS.
21	ACCESS LADDER AS SPECIFIED. REFER TO ENLARGED FLOOR PLANS, SECTION AND DETAILS
22	ACCESS LADDER WITH LOCKABLE DOOR AS


KEY PLAN

4TH LEVEL FLOOR PLAN

09/15/2022 SCALE 1/8" = 1'-0" DRAWN Author CHECKED Checker

A1.04

DRAWING NUMBER

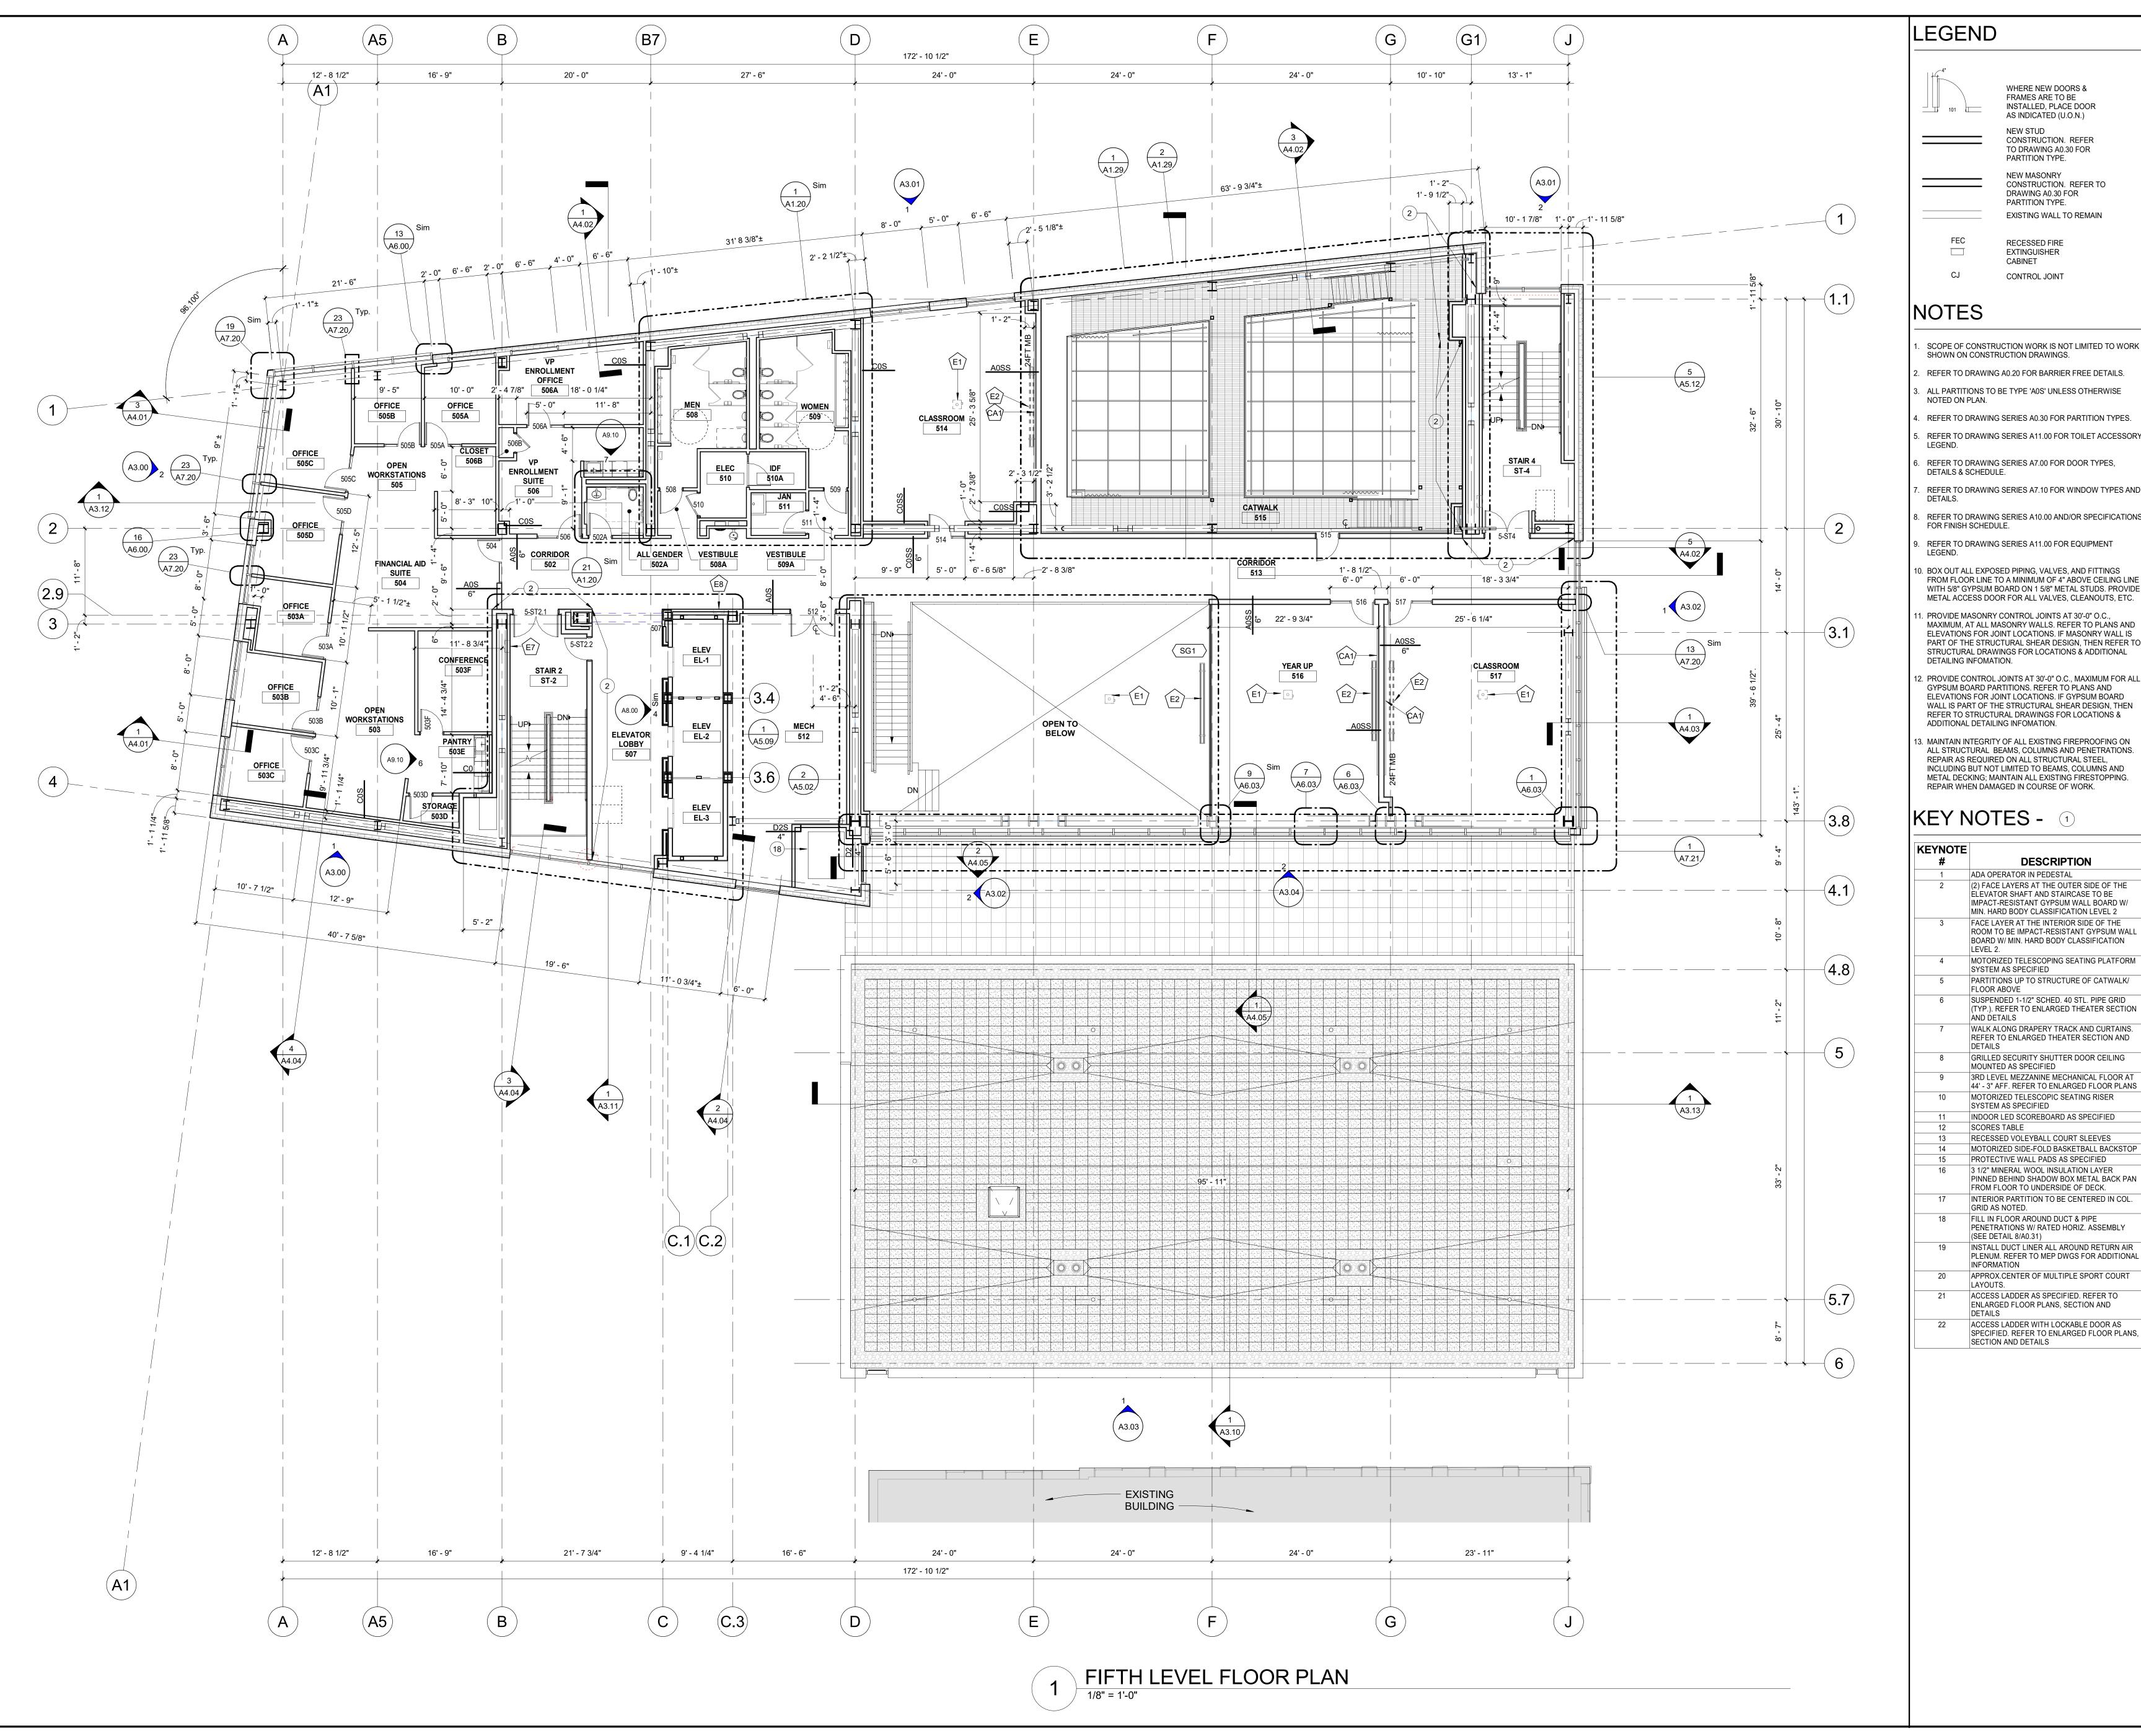



WHERE NEW DOORS & FRAMES ARE TO BE

INSTALLED, PLACE DOOR AS INDICATED (U.O.N.) CONSTRUCTION. REFER TO DRAWING A0.30 FOR PARTITION TYPE.

NEW MASONRY CONSTRUCTION. REFER TO DRAWING A0.30 FOR PARTITION TYPE. EXISTING WALL TO REMAIN

FEC

RECESSED FIRE **EXTINGUISHER** CABINET CONTROL JOINT

NOTES

- SCOPE OF CONSTRUCTION WORK IS NOT LIMITED TO WORK SHOWN ON CONSTRUCTION DRAWINGS.
- REFER TO DRAWING A0.20 FOR BARRIER FREE DETAILS. ALL PARTITIONS TO BE TYPE 'A0S' UNLESS OTHERWISE
- REFER TO DRAWING SERIES A0.30 FOR PARTITION TYPES.
- REFER TO DRAWING SERIES A7.00 FOR DOOR TYPES, DETAILS & SCHEDULE.
- REFER TO DRAWING SERIES A7.10 FOR WINDOW TYPES AND
- REFER TO DRAWING SERIES A10.00 AND/OR SPECIFICATIONS FOR FINISH SCHEDULE. REFER TO DRAWING SERIES A11.00 FOR EQUIPMENT
- BOX OUT ALL EXPOSED PIPING, VALVES, AND FITTINGS
- FROM FLOOR LINE TO A MINIMUM OF 4" ABOVE CEILING LINE WITH 5/8" GYPSUM BOARD ON 1 5/8" METAL STUDS. PROVIDE METAL ACCESS DOOR FOR ALL VALVES, CLEANOUTS, ETC. . PROVIDE MASONRY CONTROL JOINTS AT 30'-0" O.C.,
- PART OF THE STRUCTURAL SHEAR DESIGN, THEN REFER TO STRUCTURAL DRAWINGS FOR LOCATIONS & ADDITIONAL DETAILING INFOMATION. PROVIDE CONTROL JOINTS AT 30'-0" O.C., MAXIMUM FOR ALL GYPSUM BOARD PARTITIONS. REFER TO PLANS AND
- ELEVATIONS FOR JOINT LOCATIONS. IF GYPSUM BOARD WALL IS PART OF THE STRUCTURAL SHEAR DESIGN. THEN REFER TO STRUCTURAL DRAWINGS FOR LOCATIONS & ADDITIONAL DETAILING INFOMATION. B. MAINTAIN INTEGRITY OF ALL EXISTING FIREPROOFING ON
- ALL STRUCTURAL BEAMS, COLUMNS AND PENETRATIONS. REPAIR AS REQUIRED ON ALL STRUCTURAL STEEL, METAL DECKING; MAINTAIN ALL EXISTING FIRESTOPPING. REPAIR WHEN DAMAGED IN COURSE OF WORK.

KEY NOTES - 1

KEYNOTE #	DESCRIPTION
1	ADA OPERATOR IN PEDESTAL
2	(2) FACE LAYERS AT THE OUTER SIDE OF THE ELEVATOR SHAFT AND STAIRCASE TO BE IMPACT-RESISTANT GYPSUM WALL BOARD W/MIN. HARD BODY CLASSIFICATION LEVEL 2
3	FACE LAYER AT THE INTERIOR SIDE OF THE ROOM TO BE IMPACT-RESISTANT GYPSUM WALL BOARD W/ MIN. HARD BODY CLASSIFICATION LEVEL 2.
4	MOTORIZED TELESCOPING SEATING PLATFORM SYSTEM AS SPECIFIED
5	PARTITIONS UP TO STRUCTURE OF CATWALK/ FLOOR ABOVE
6	SUSPENDED 1-1/2" SCHED. 40 STL. PIPE GRID (TYP.). REFER TO ENLARGED THEATER SECTION AND DETAILS
7	WALK ALONG DRAPERY TRACK AND CURTAINS. REFER TO ENLARGED THEATER SECTION AND DETAILS
8	GRILLED SECURITY SHUTTER DOOR CEILING MOUNTED AS SPECIFIED
9	3RD LEVEL MEZZANINE MECHANICAL FLOOR AT 44' - 3" AFF. REFER TO ENLARGED FLOOR PLANS
10	MOTORIZED TELESCOPIC SEATING RISER SYSTEM AS SPECIFIED
11	INDOOR LED SCOREBOARD AS SPECIFIED
12	SCORES TABLE
13	RECESSED VOLEYBALL COURT SLEEVES
14	MOTORIZED SIDE-FOLD BASKETBALL BACKSTOR
15	PROTECTIVE WALL PADS AS SPECIFIED
16	3 1/2" MINERAL WOOL INSULATION LAYER PINNED BEHIND SHADOW BOX METAL BACK PANFROM FLOOR TO UNDERSIDE OF DECK.
17	INTERIOR PARTITION TO BE CENTERED IN COL. GRID AS NOTED.
18	FILL IN FLOOR AROUND DUCT & PIPE PENETRATIONS W/ RATED HORIZ. ASSEMBLY (SEE DETAIL 8/A0.31)
19	INSTALL DUCT LINER ALL AROUND RETURN AIR PLENUM. REFER TO MEP DWGS FOR ADDITIONA INFORMATION
20	APPROX.CENTER OF MULTIPLE SPORT COURT LAYOUTS.
21	ACCESS LADDER AS SPECIFIED. REFER TO ENLARGED FLOOR PLANS, SECTION AND DETAILS
22	ACCESS LADDER WITH LOCKABLE DOOR AS SPECIFIED. REFER TO ENLARGED FLOOR PLANS SECTION AND DETAILS

NK ARCHITECTS 95 WASHINGTON STREET, MORRISTOWN, NJ 07960 t. 973.539.5353 f. 973.539.0916

www.nkarchitects.com

BEN P. LEE, AIA

DANIEL J. TOPPING, AIA

THE WOOLWORTH BUILDING 233 BROADWAY SUITE 2150, NEW YORK, NY 10279

STEPHEN P. ALUOTTO, AIA PAUL J. DRAGO, AIA WALTER J. KNEIS, AIA ALLEN R. KOPELSON, AIA

THIS DOCUMENT IS THE EXCLUSIVE PROPERTY OF NK ARCHITECTS. THE DOCUMENT AND THE INFORMATION IT CONTAINS MAY NOT BE REPRODUCED OR USED FOR OTHER THAN THE SPECIFIC PROJECT FOR WHICH IT WAS PREPARED WITHOUT THE EXPLICIT

AI 17503

AI 10867

AI 05644

AI 07017

AI 16263



COMMUNITY COLLEGE **HUDSON COUNTY** COMMUNITY

COLLEGE

MIXED-USE ACADEMIC BUILDING Jersey City, NJ

KEY PLAN

5TH LEVEL FLOOR PLAN


09/15/2022 SCALE 1/8" = 1'-0" DRAWN Author CHECKED


A1.05

DRAWING NUMBER

Checker




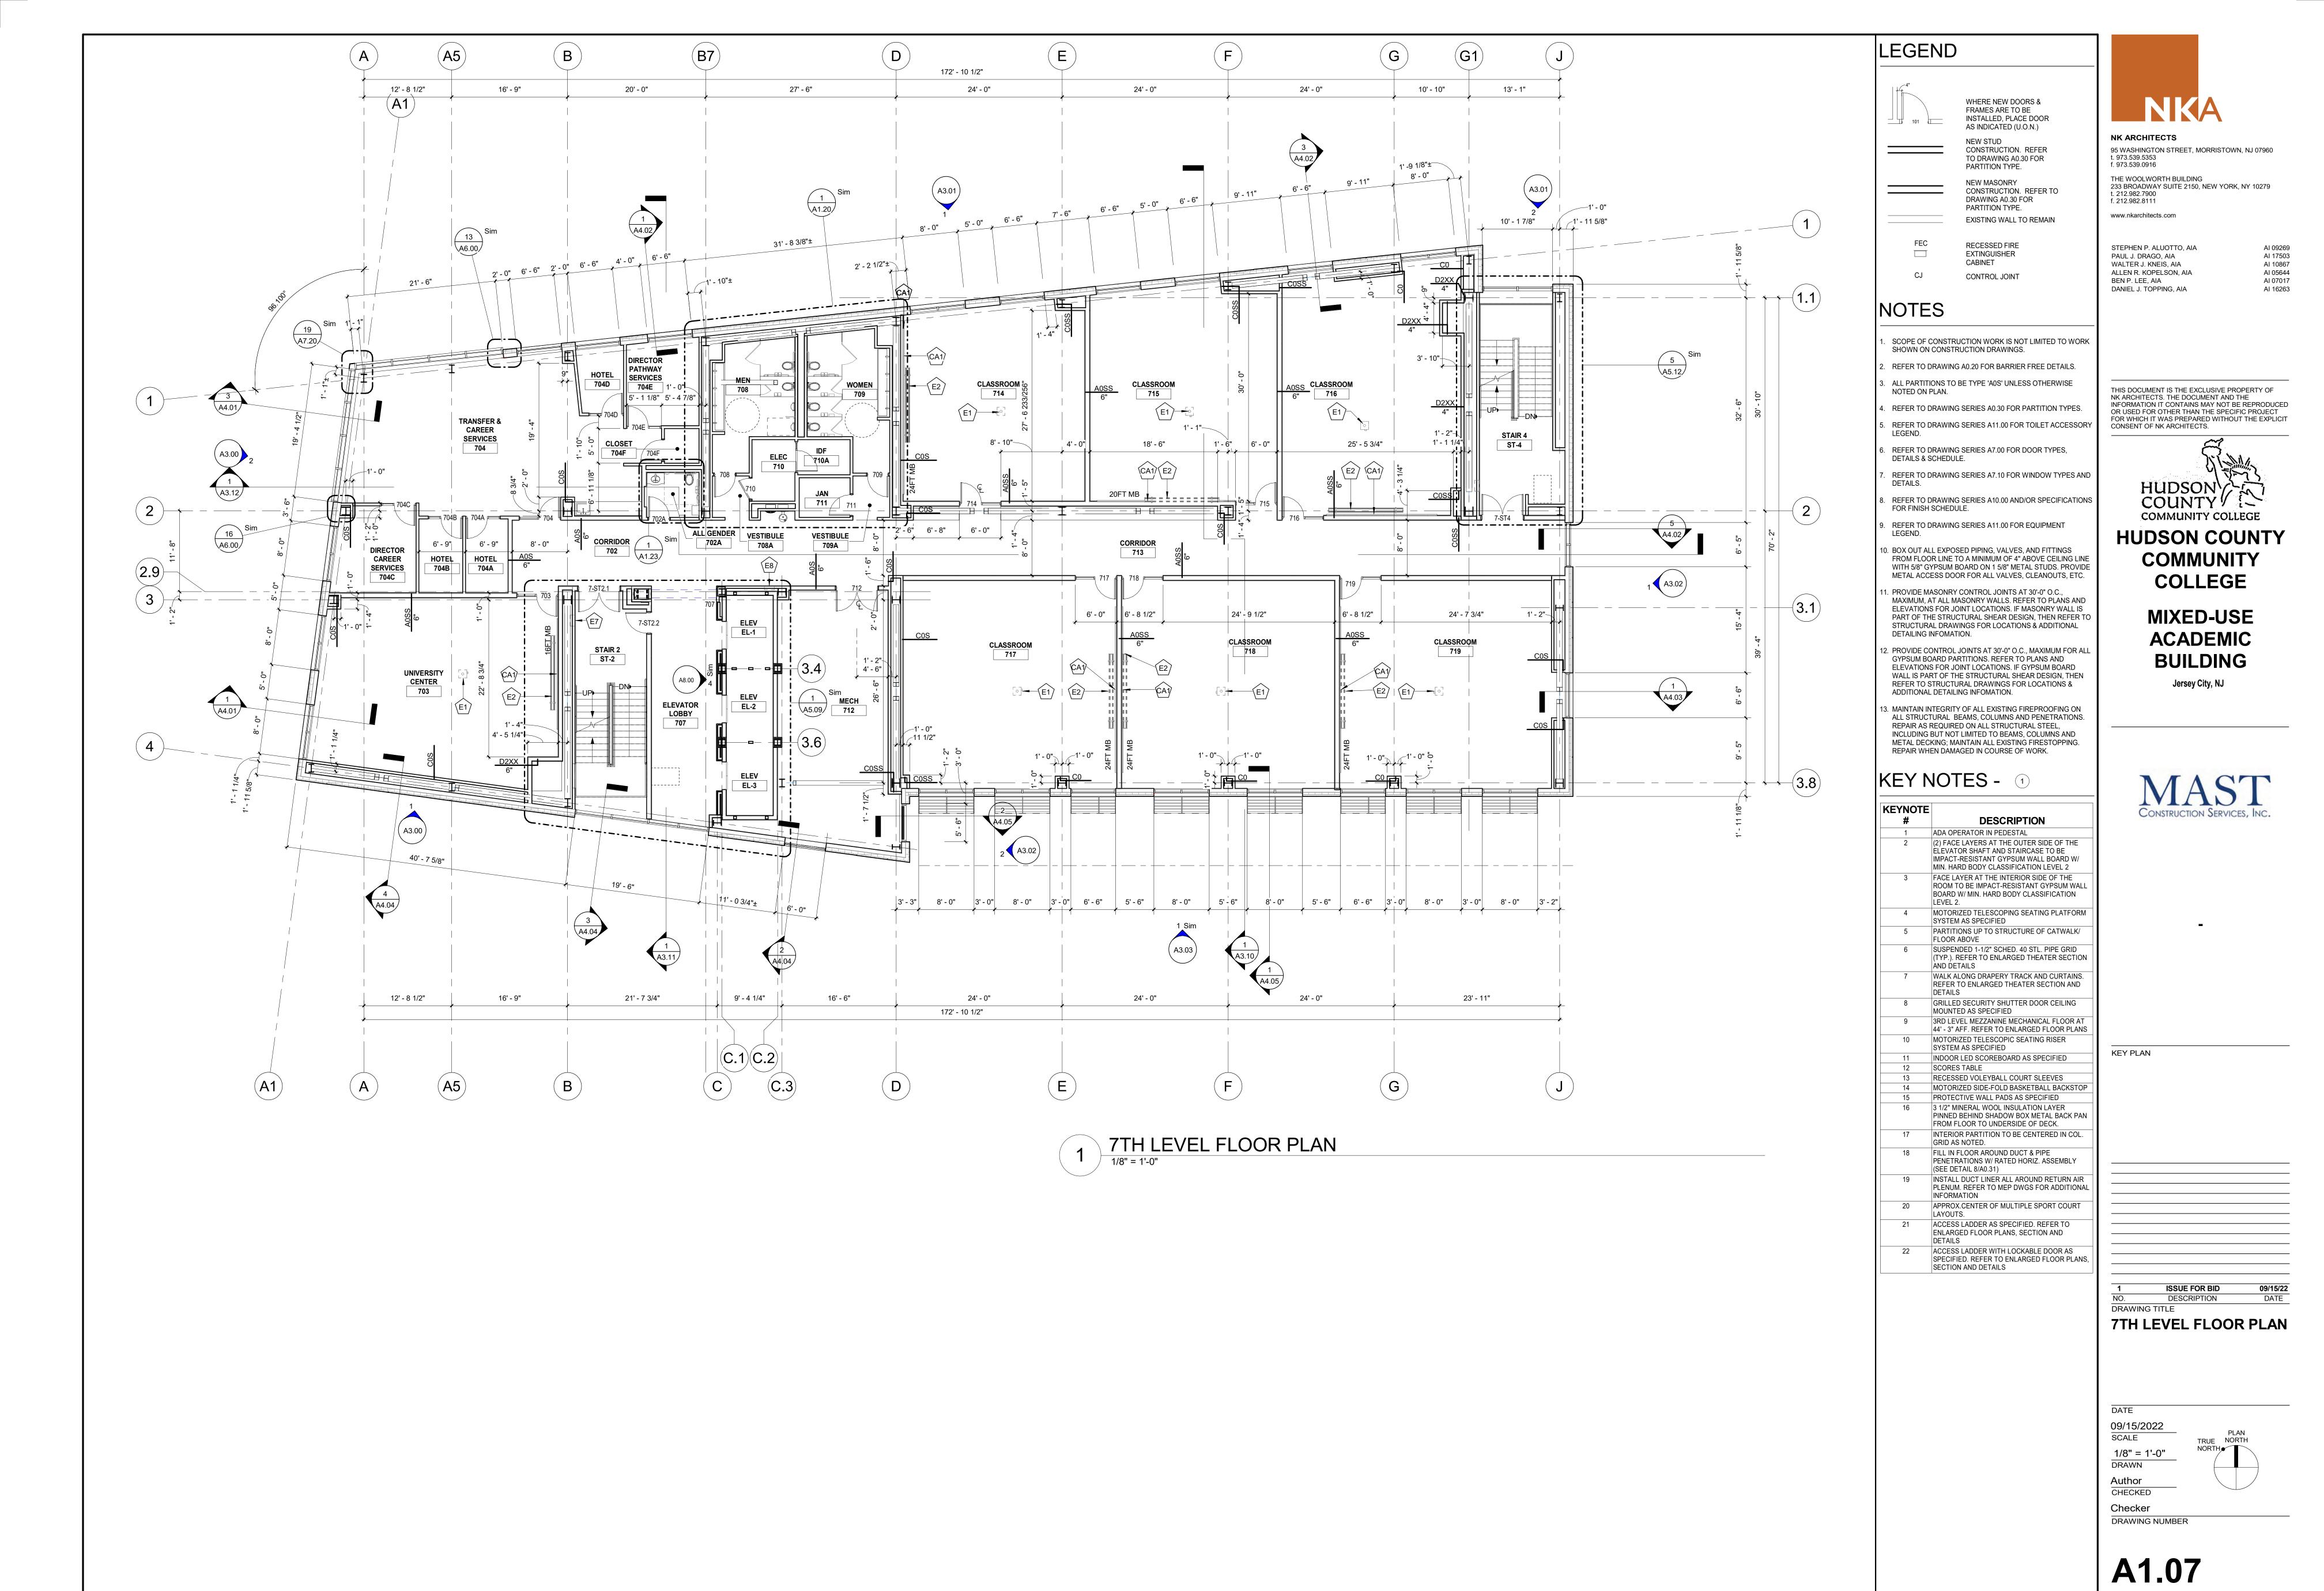

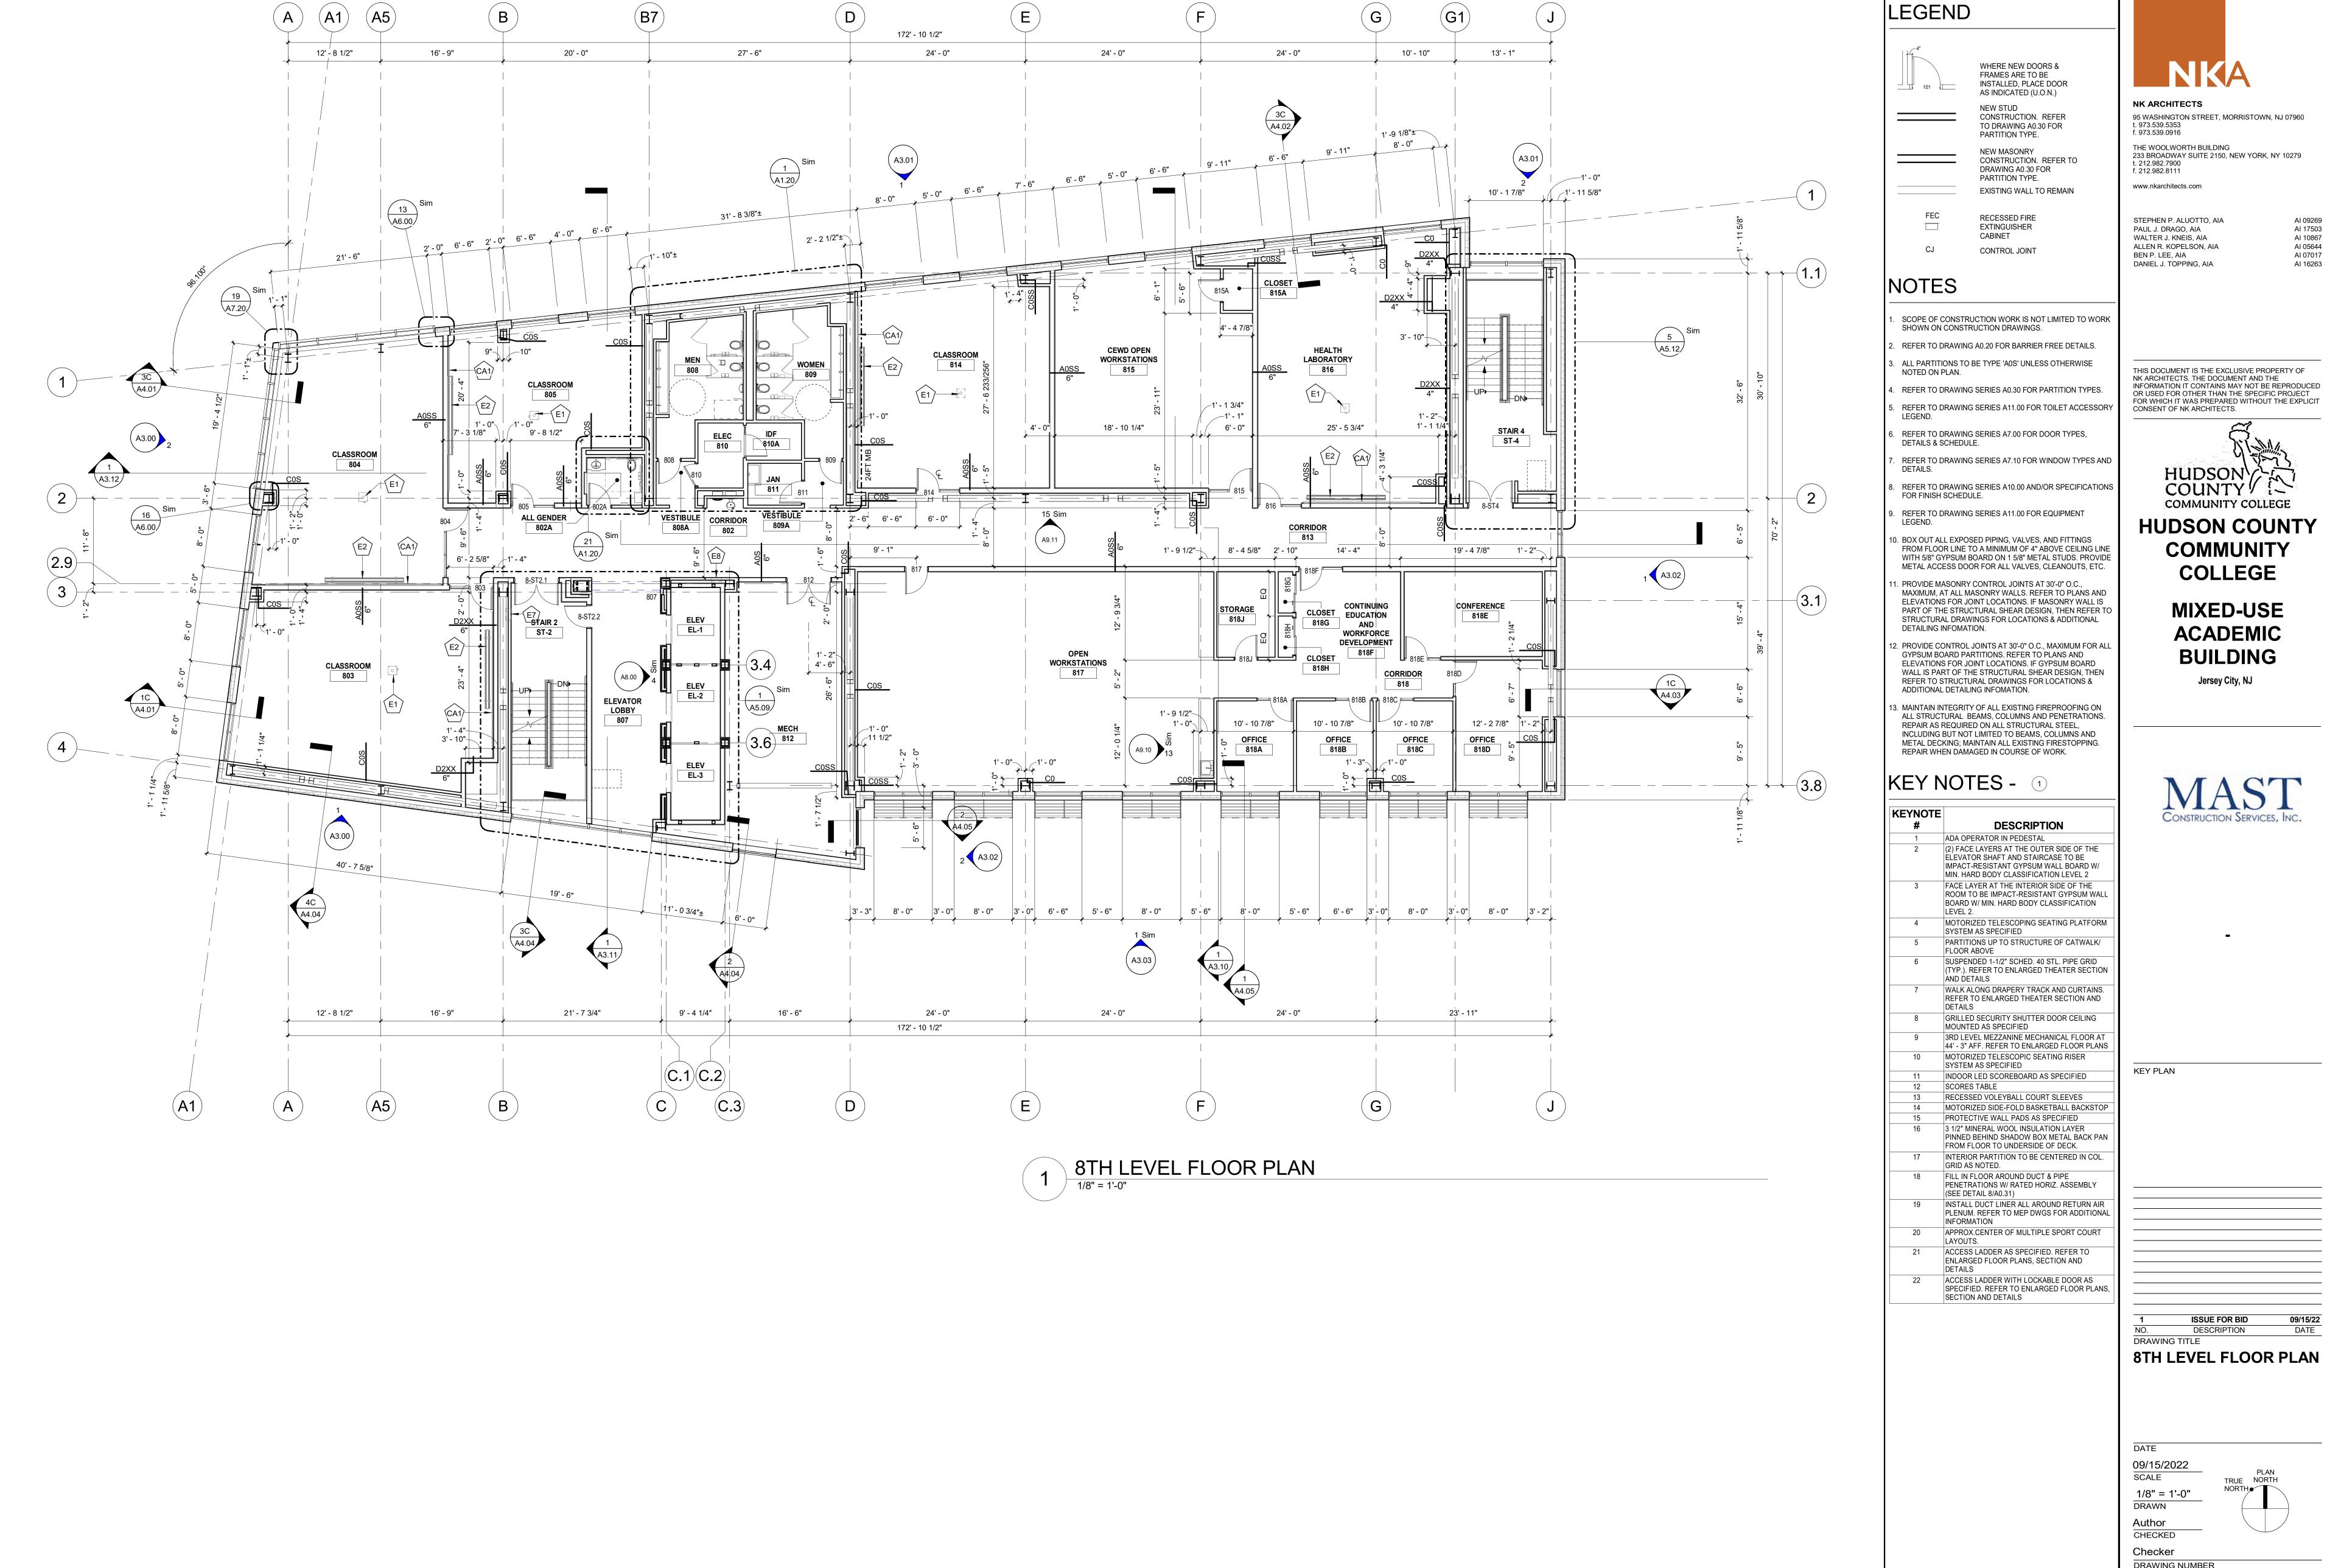

DRAWING NUMBER


A1.08

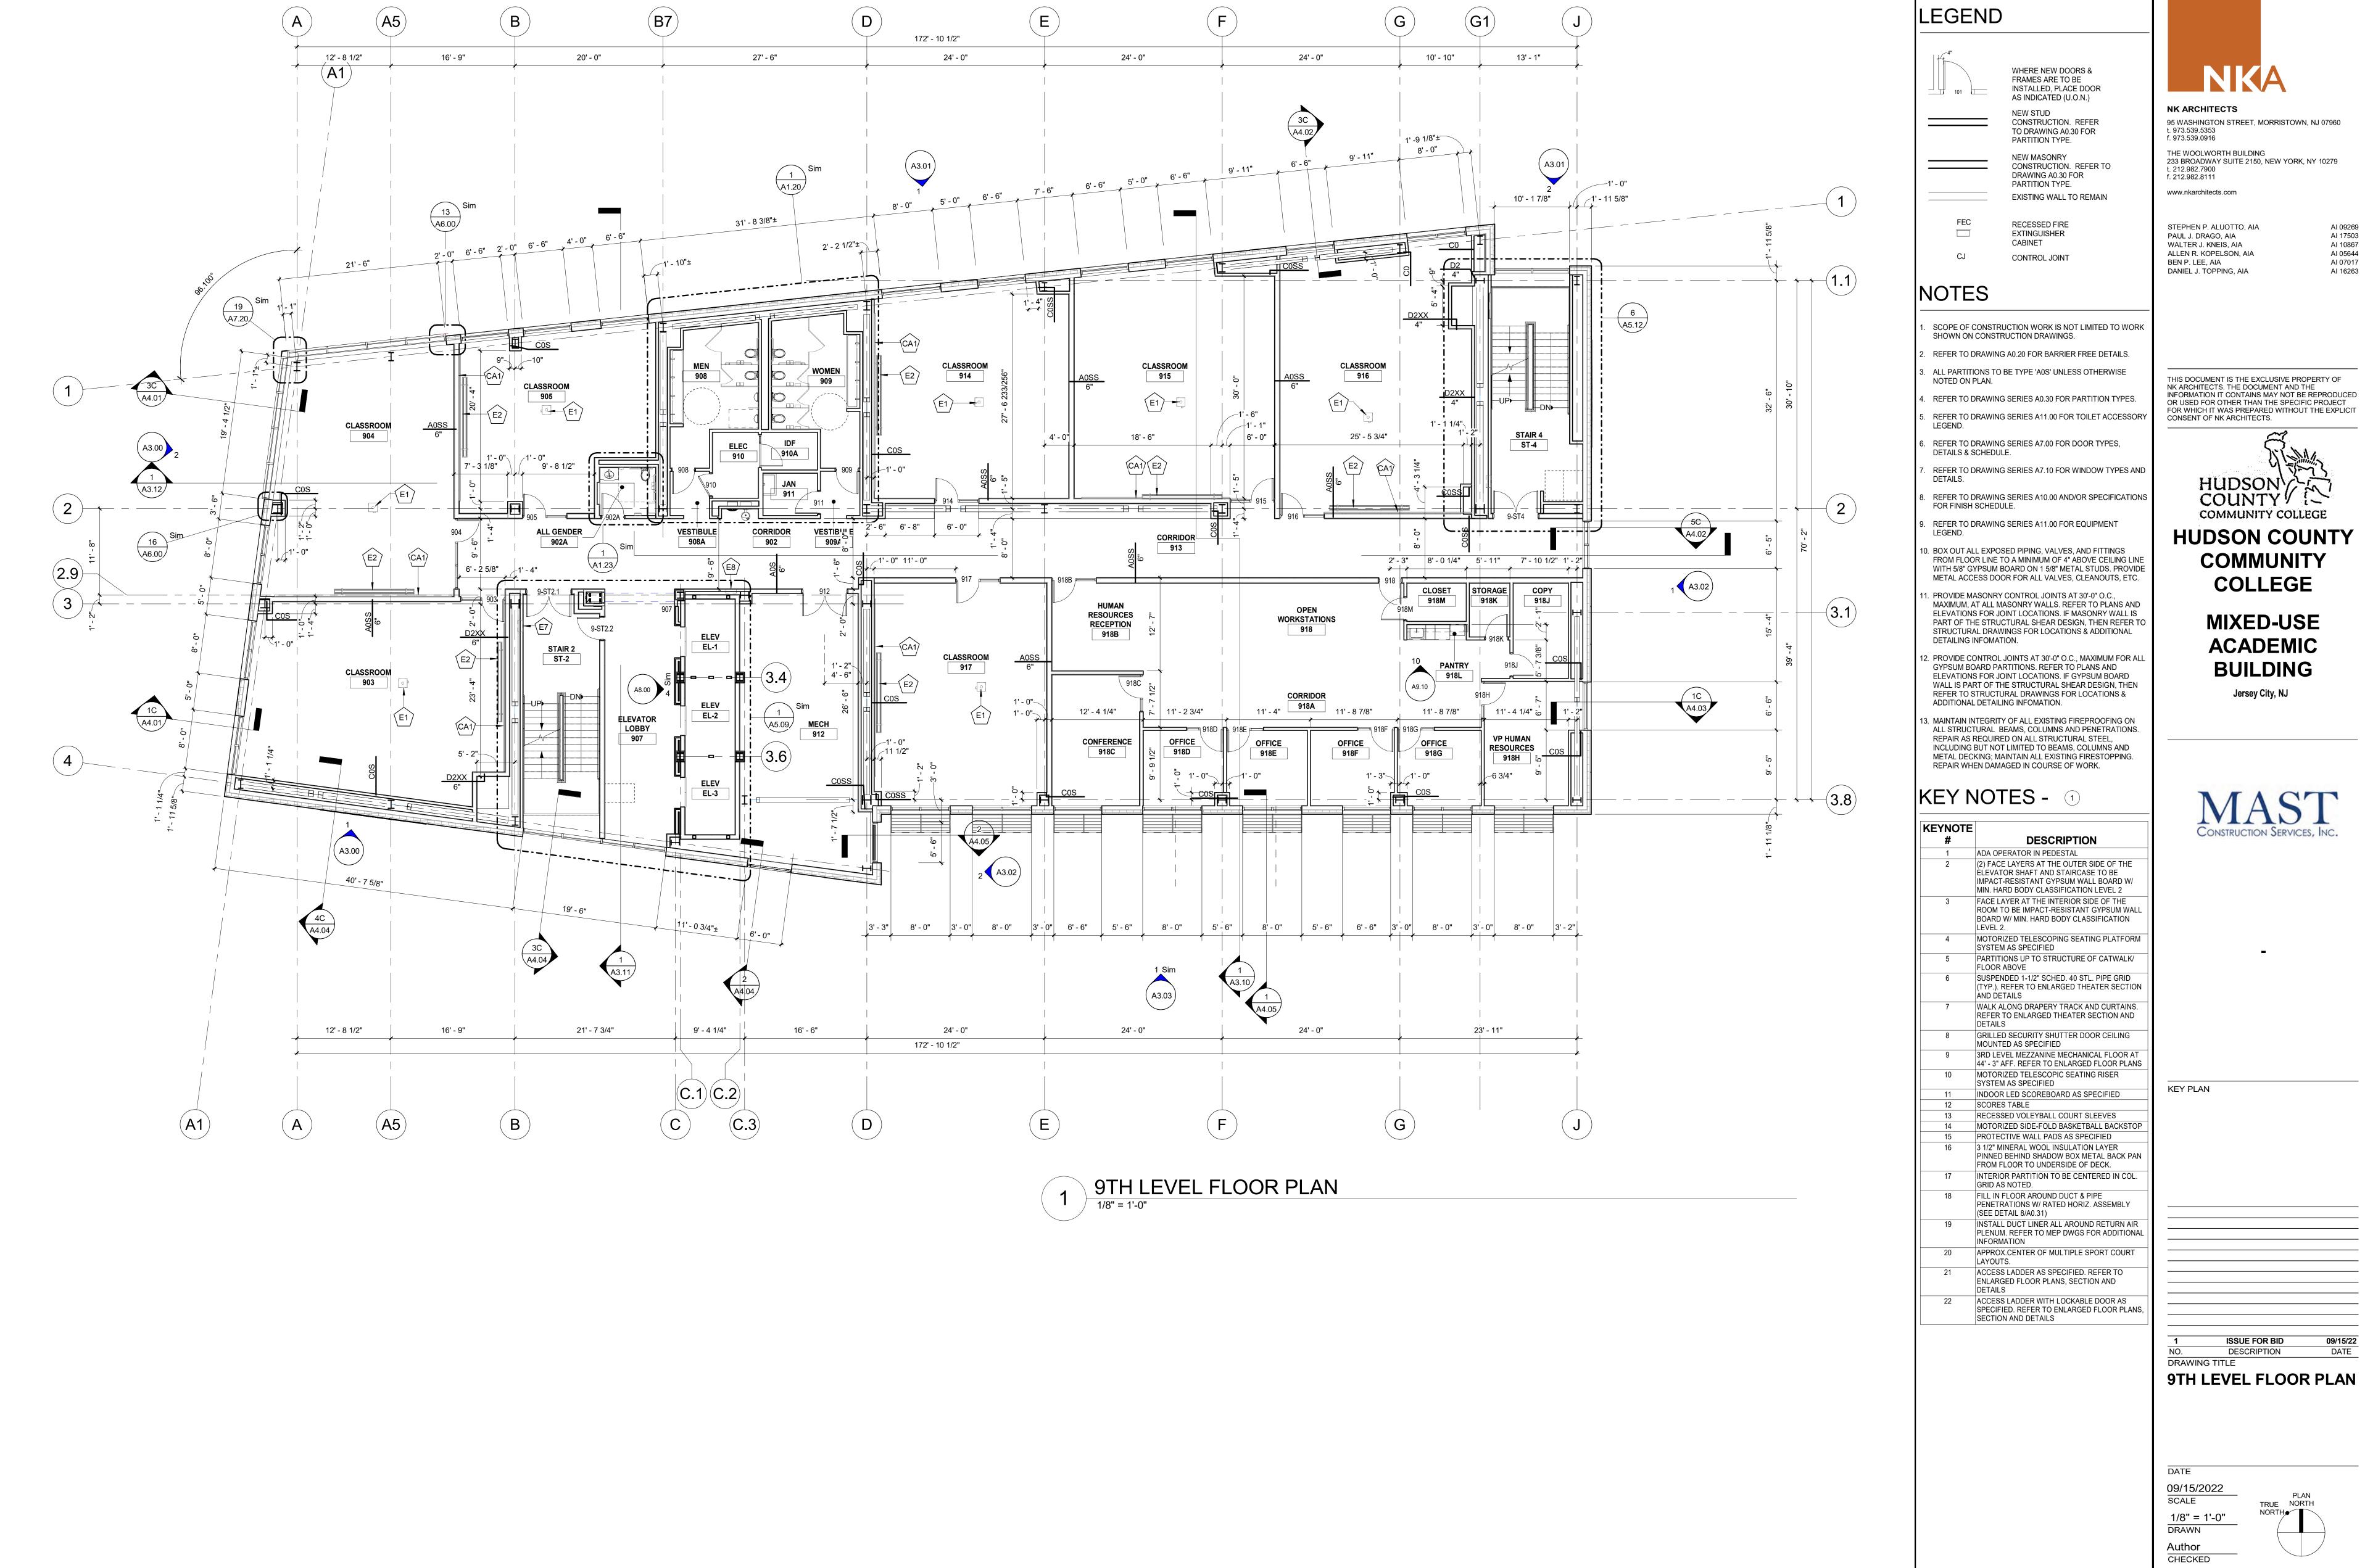



Checker


A1.09

DRAWING NUMBER

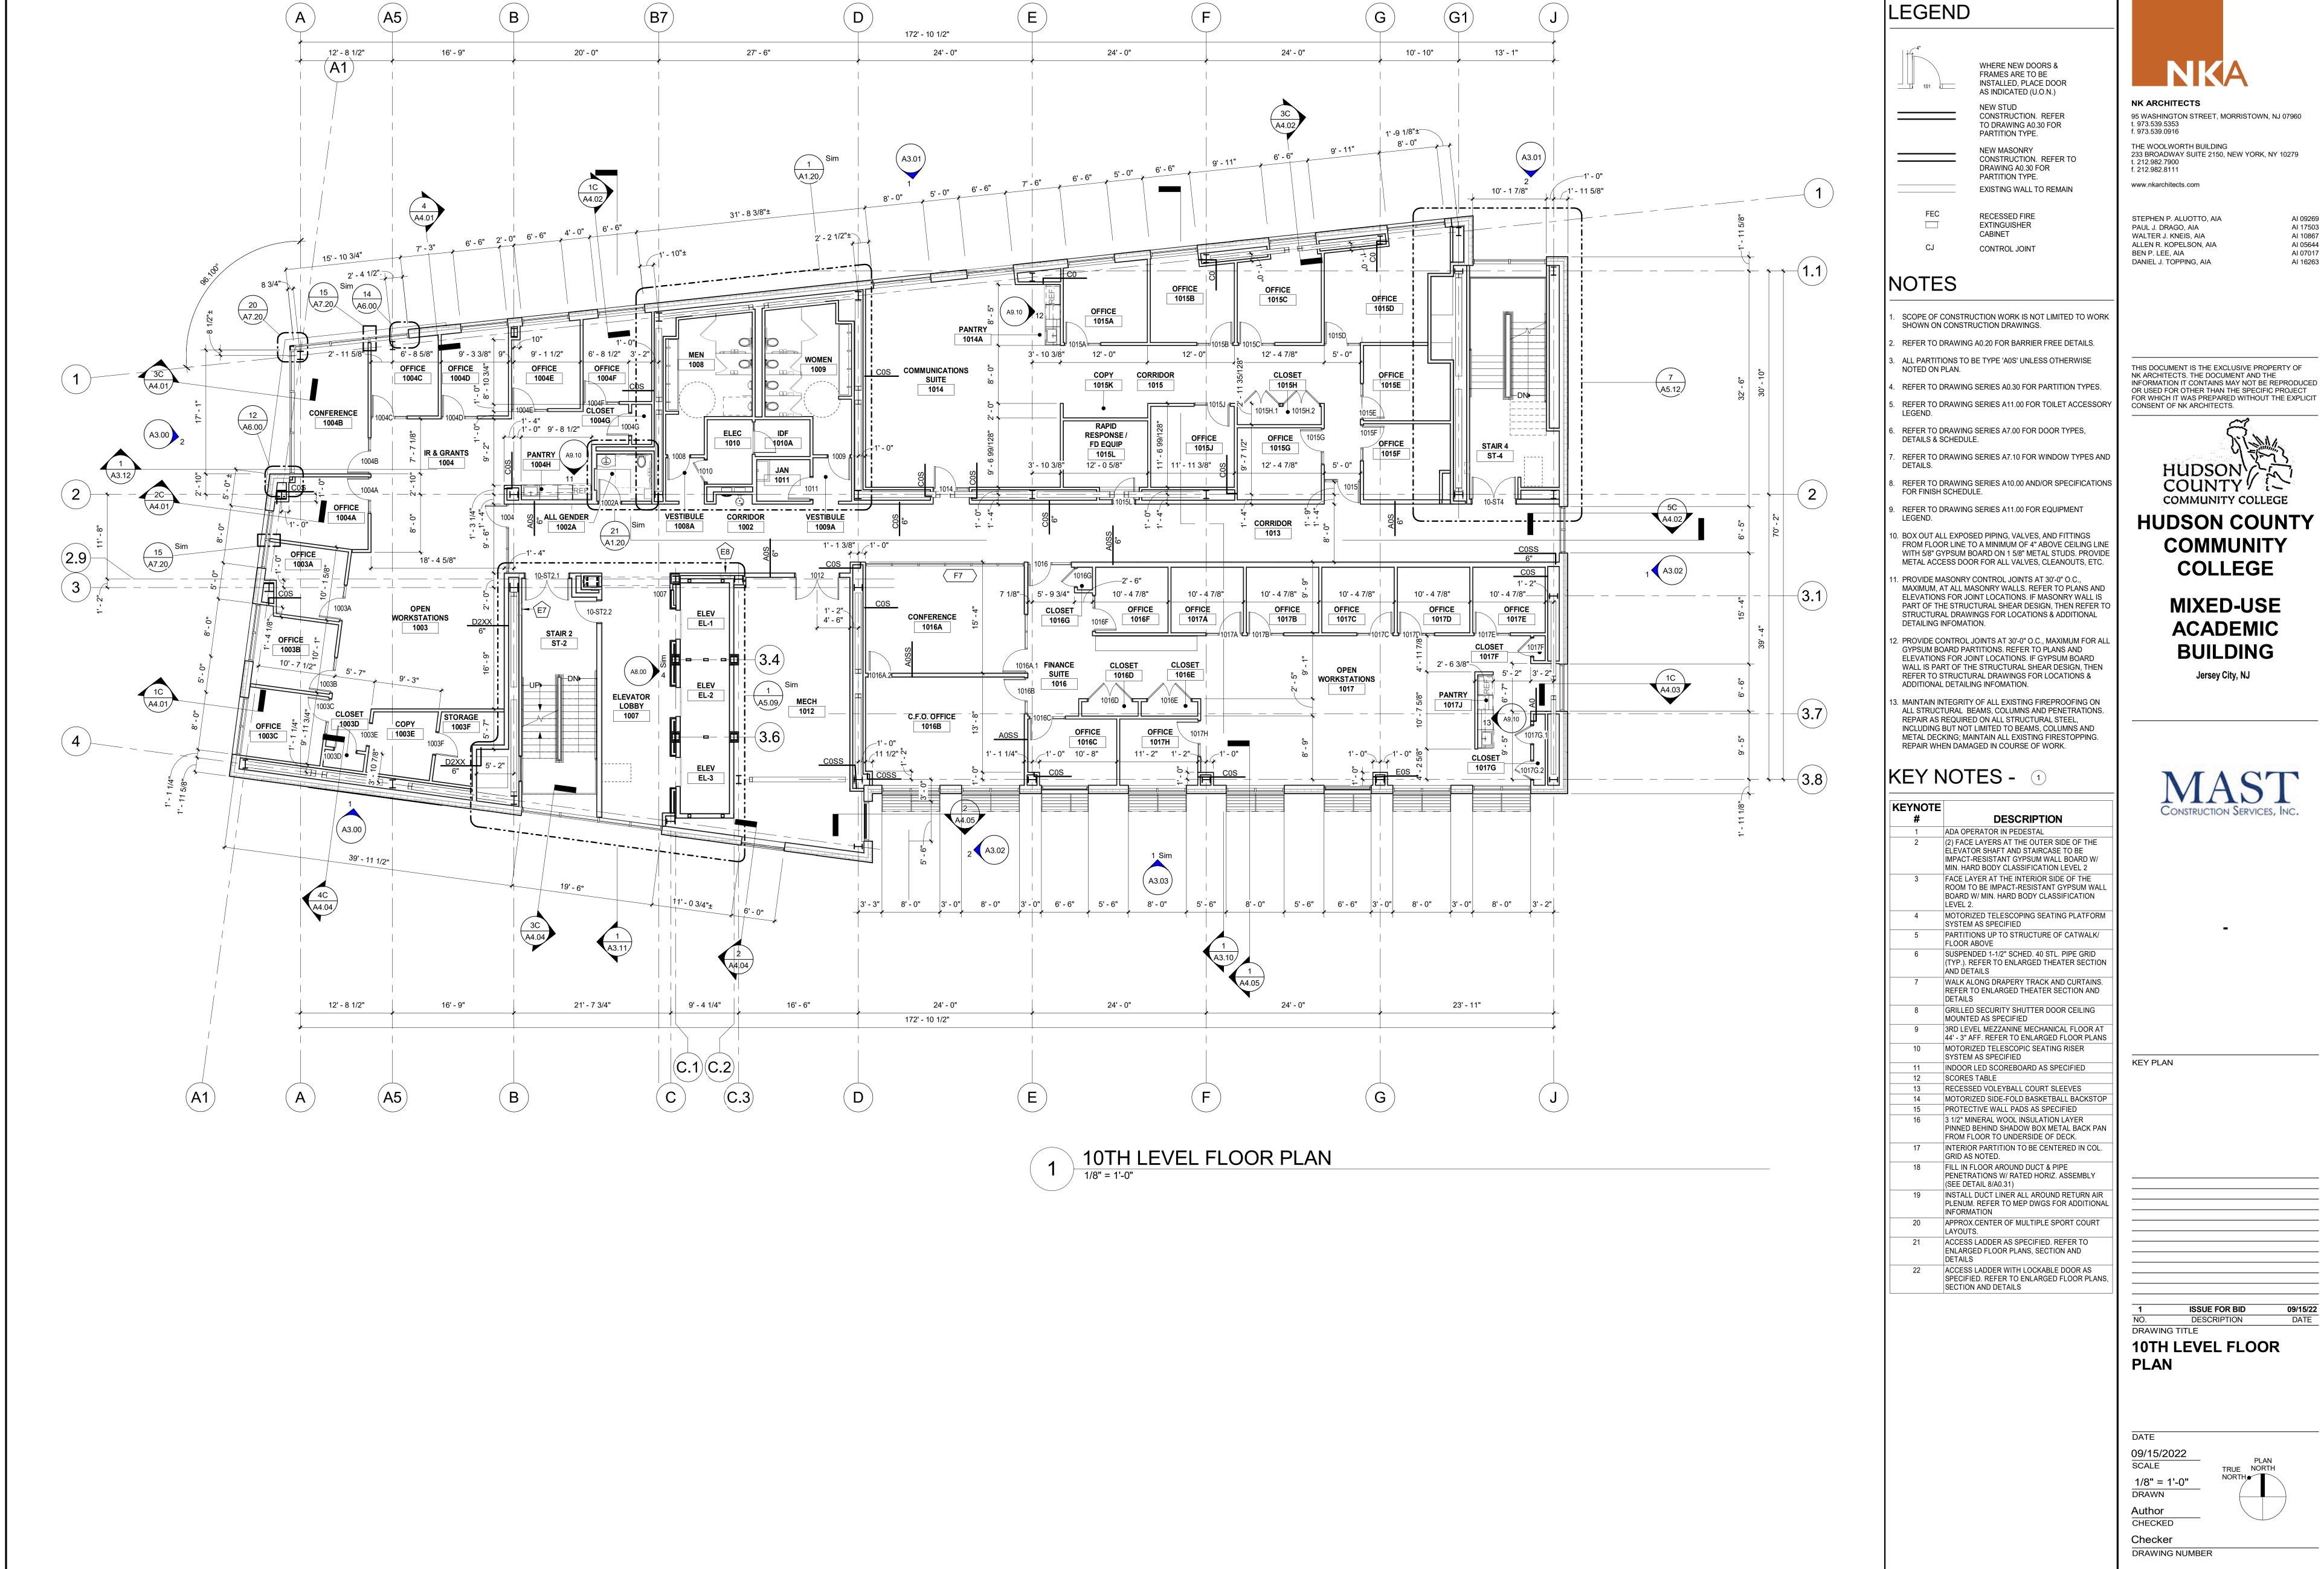

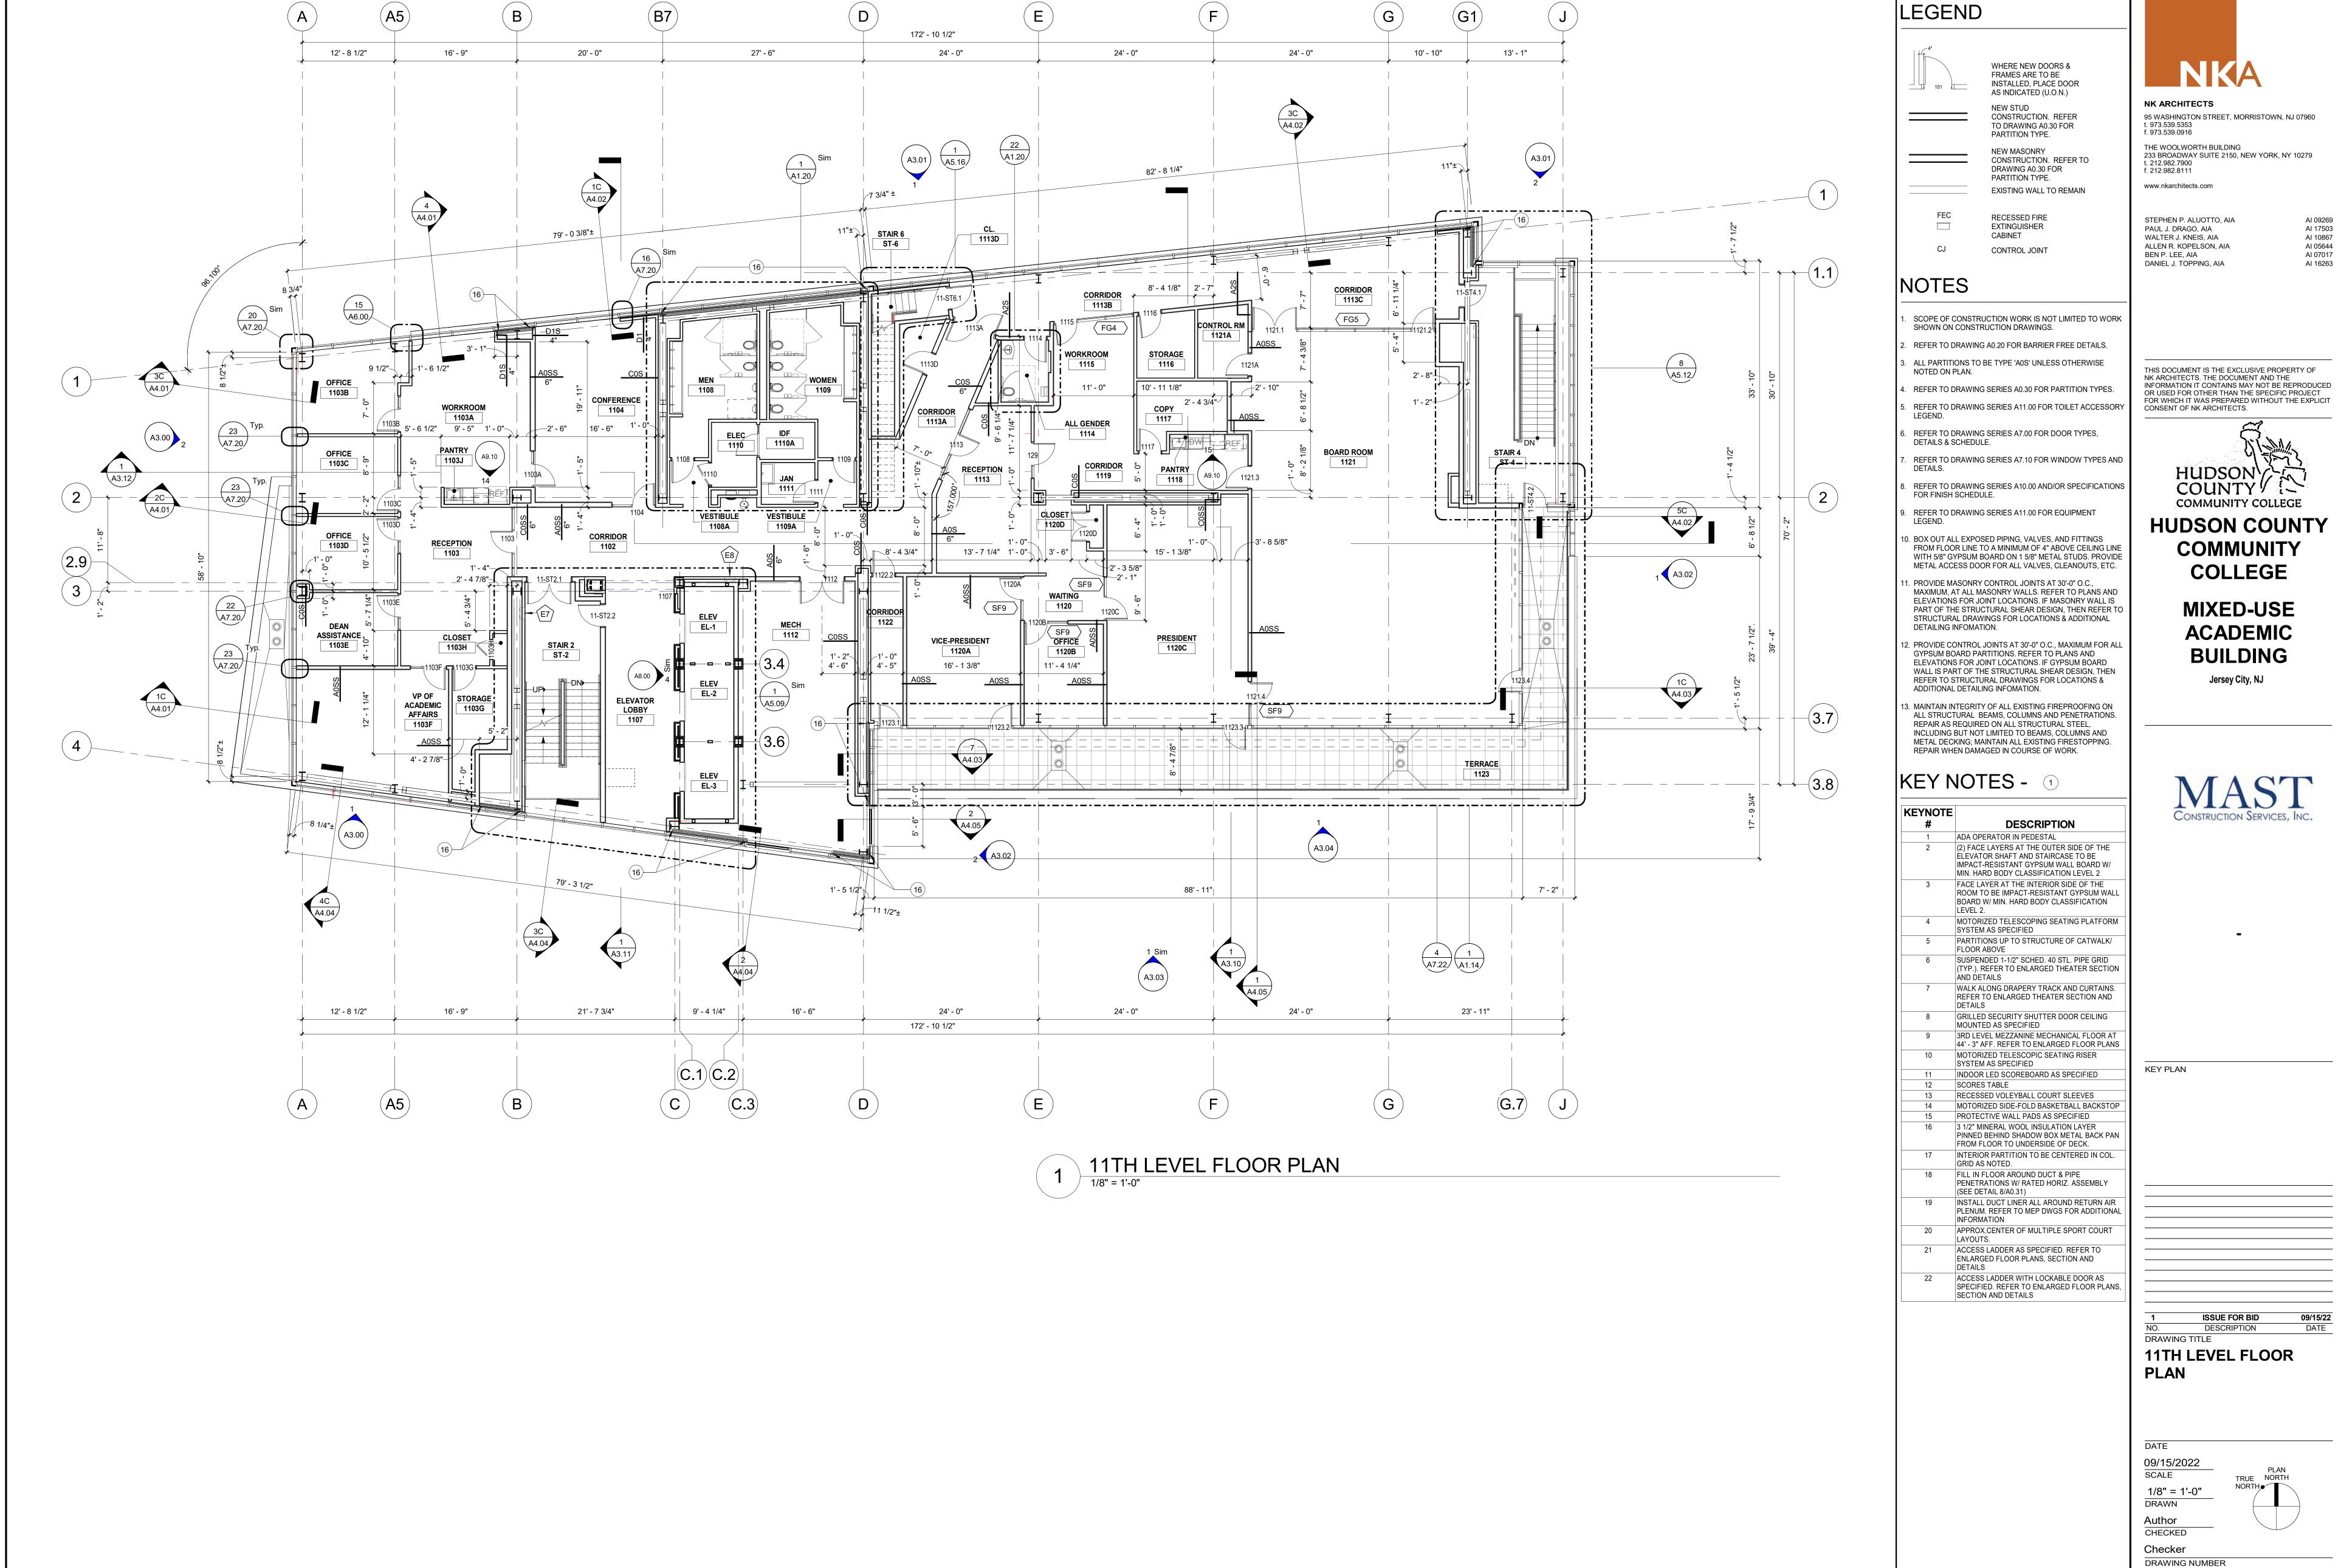

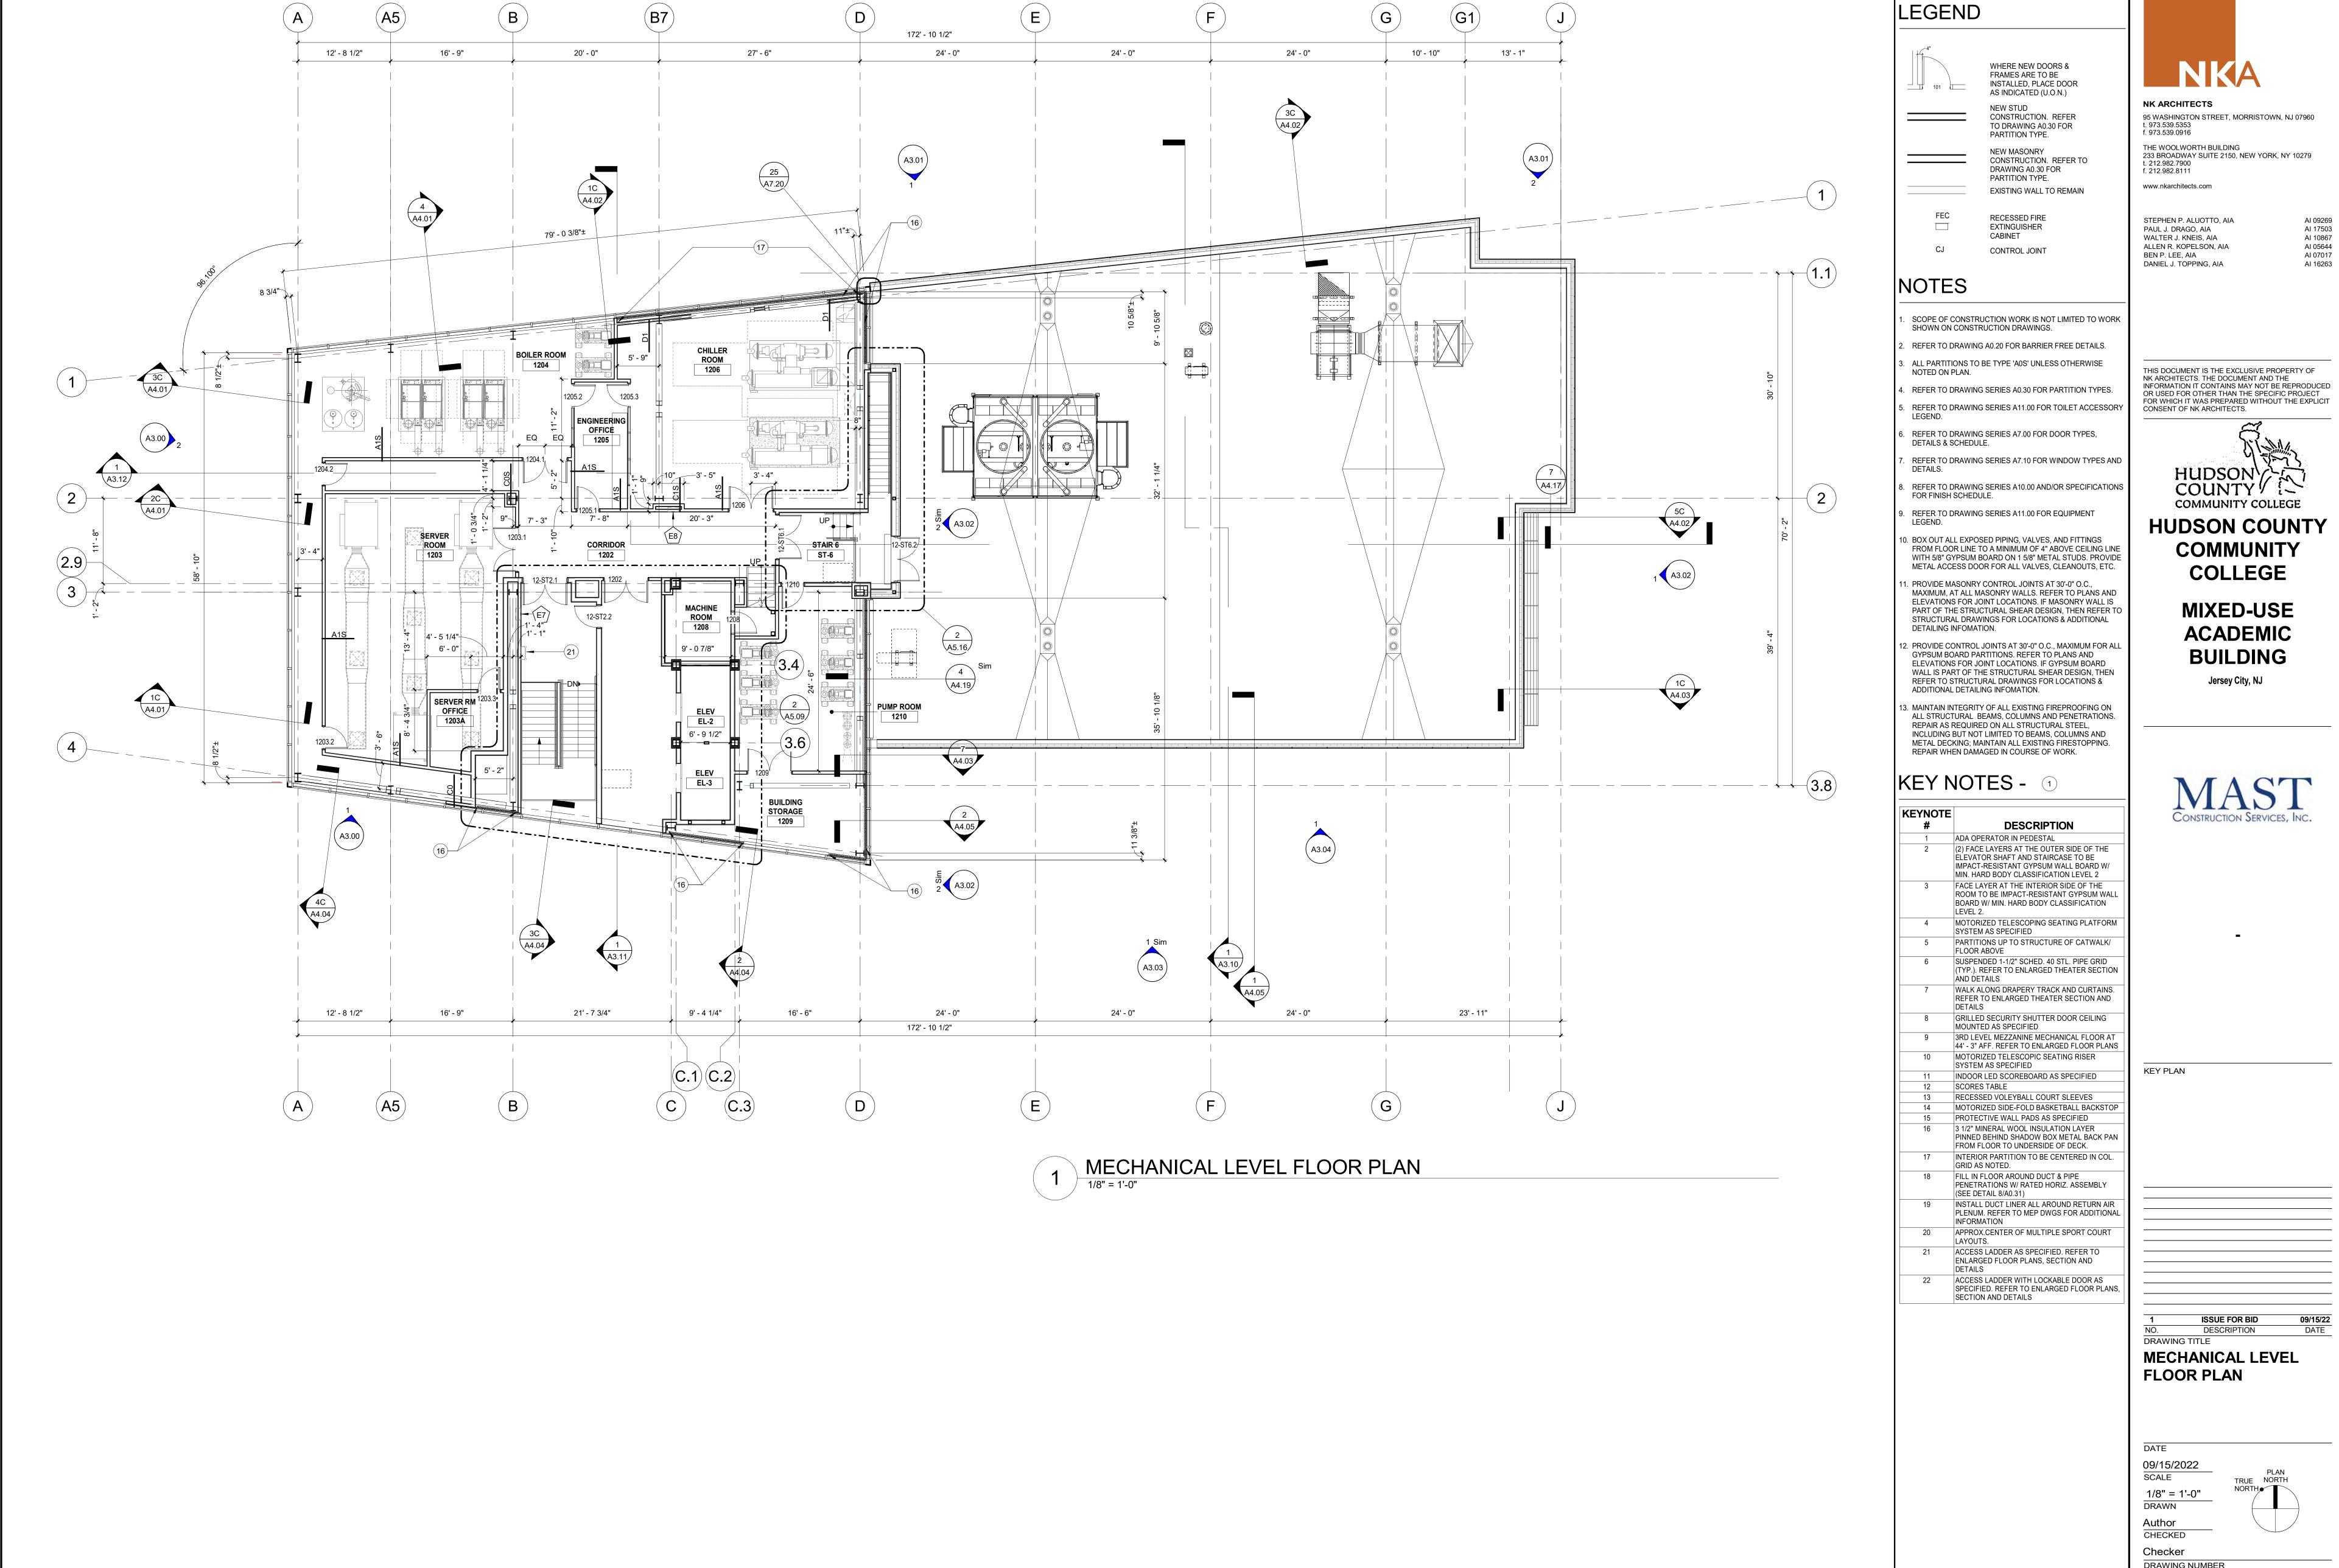

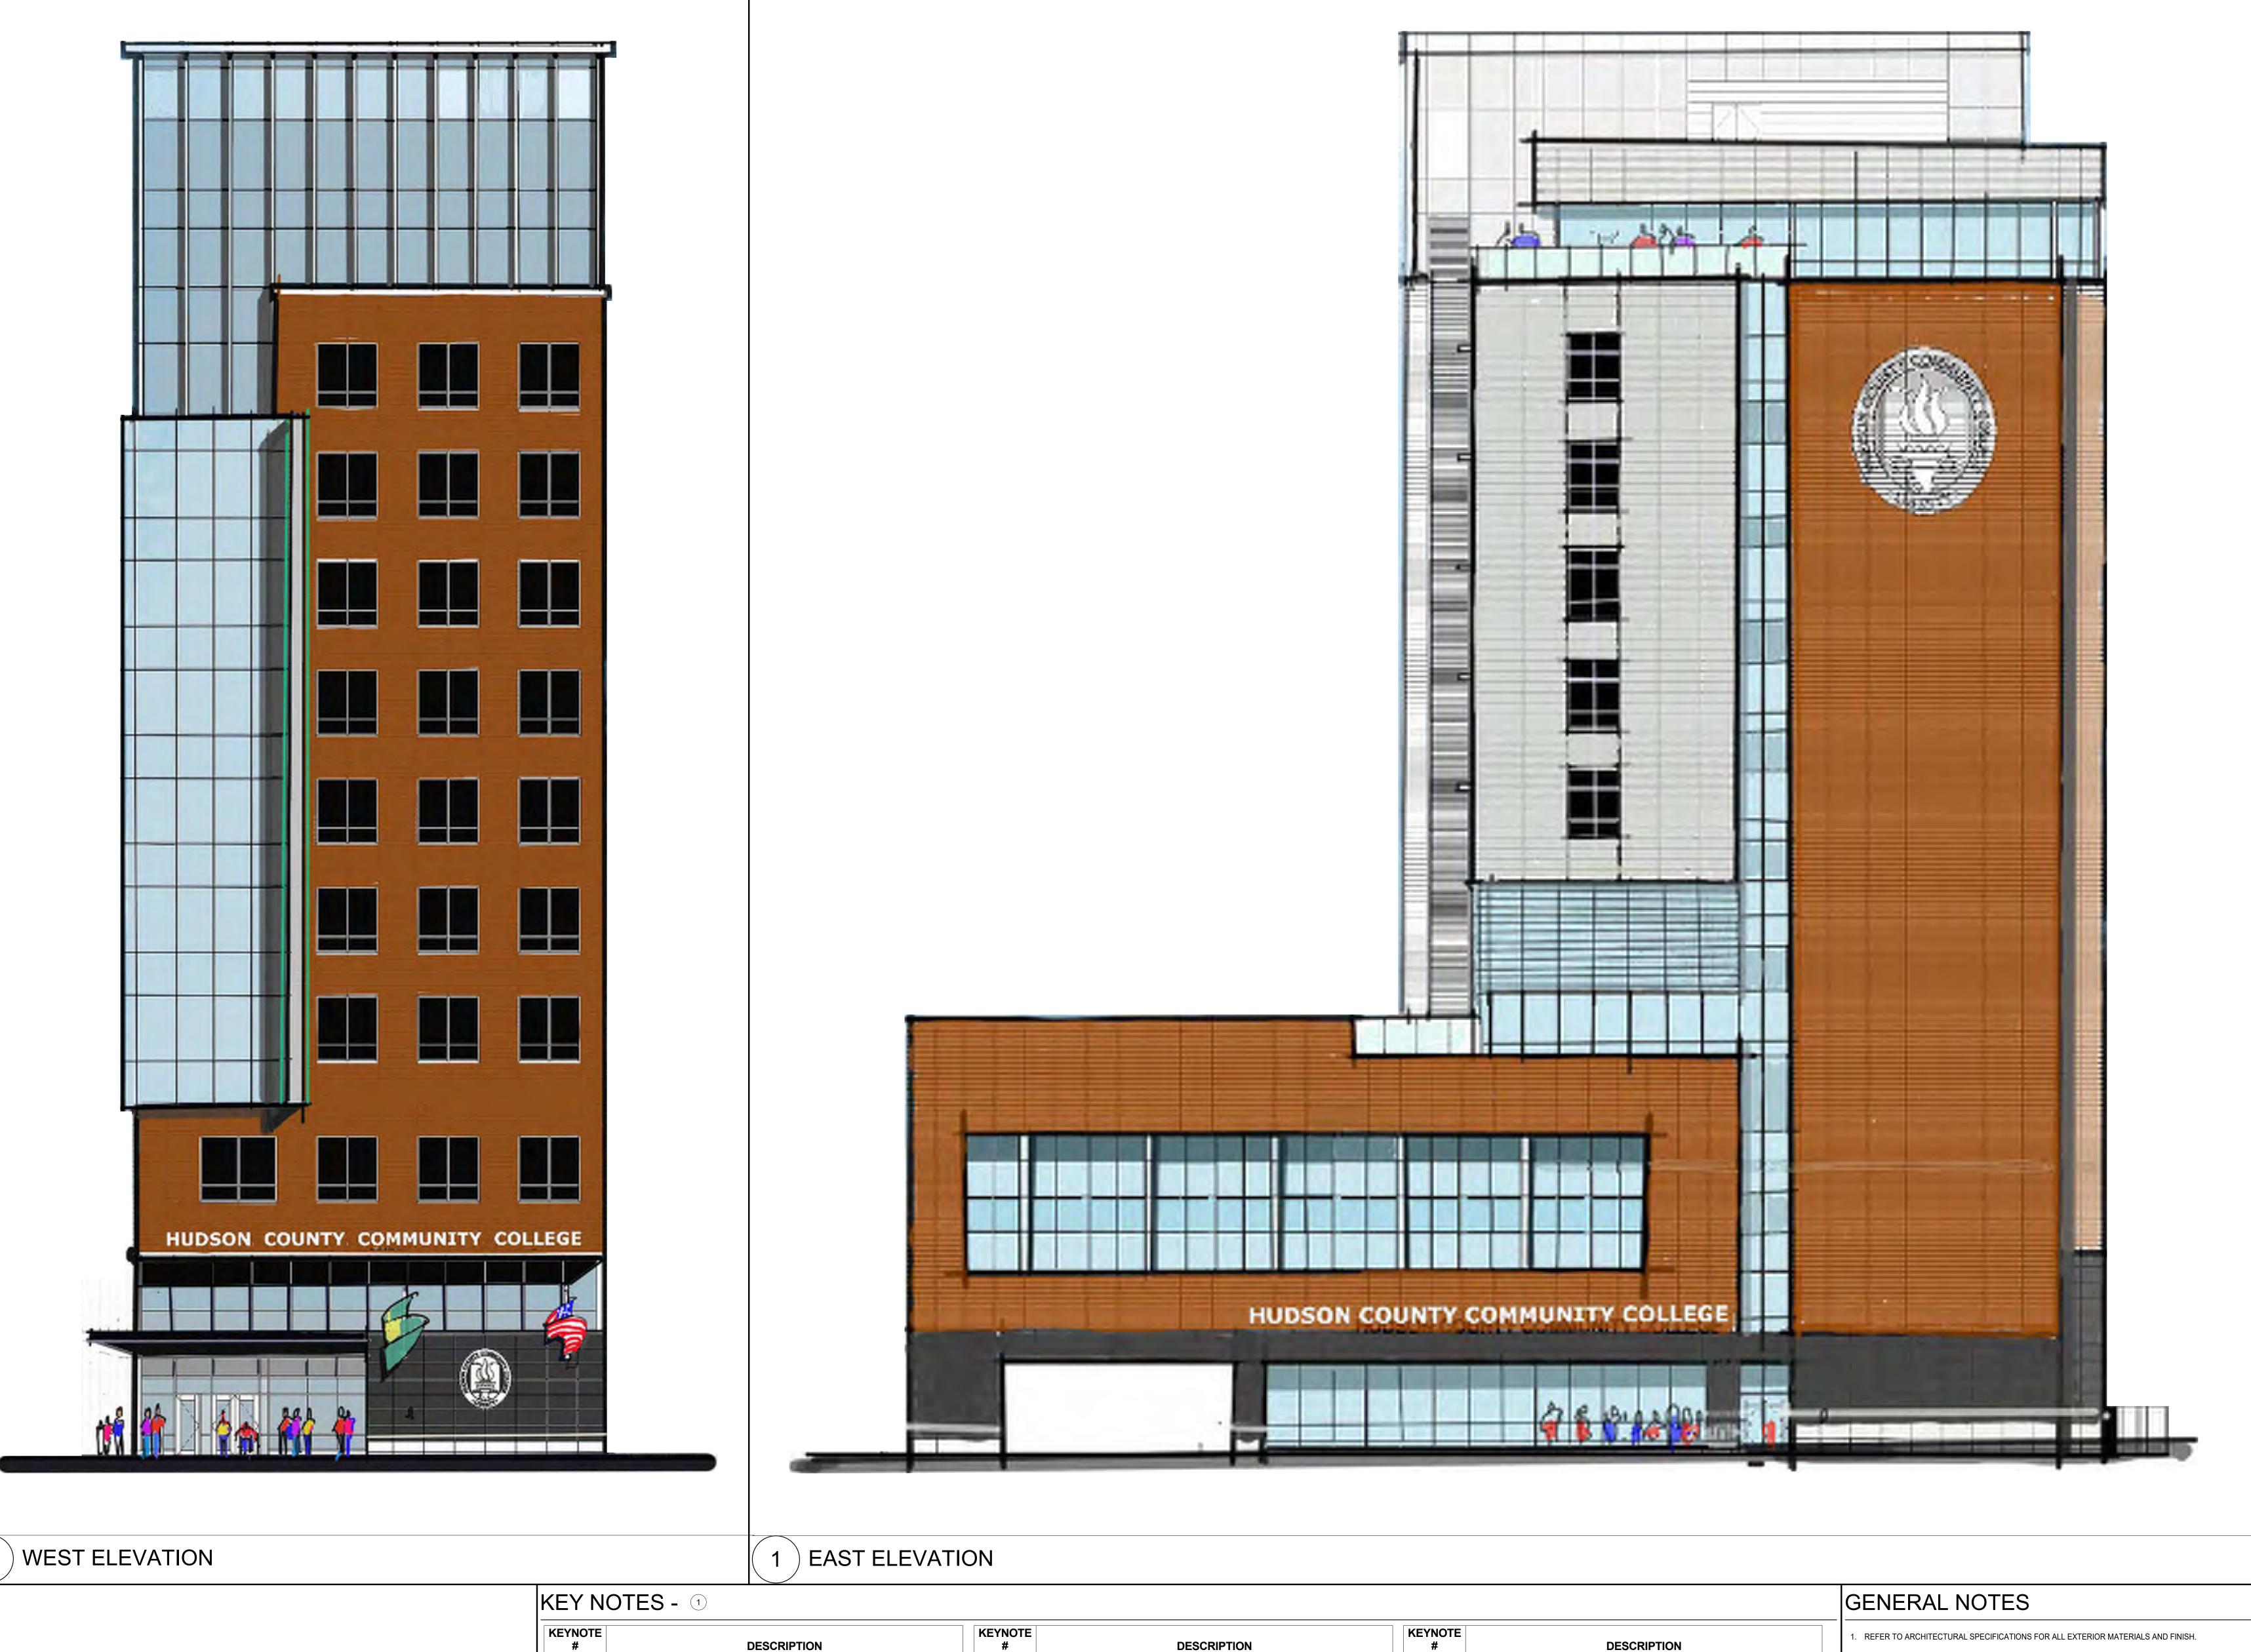

EXTERIOR RAILING ASSEMBLY AS SPECIFIED

LOGO "A" CENTERED AT WALL AS SPECIFIED

30" SUNSHADES OUTRIGGER SYSTEM AS SPECIFIED ALTERNATE SCREEN AS SPECIFIED. REFER TO DETAILS

ARCHITECTURAL GRADE FINISH CONCRETE AS SPECIFIED

HORIZONTAL SUNSHADE SYSTEM ATTACHED TO CURTAIN WALL AS SPECIFIED

ARCHITECTURAL LOUVERS AS SPECIFIED

CONCRETE SLAB AND STEPS AS SPECIFIED

LOGO "B" AS SPECIFIED LETTERING "B" AS SPECIFIED

EXPANSION JOINT AS SPECIFIED

DESCRIPTION

PERFORATED FENCE SYSTEM SWING GATE AND PANELS AS SPECIFIED. REFER TO CIVIL DWGS FOR MORE INFORMATION

TERRACOTTA RAINSCREEN SYSTEM AS SPECIFIED

EXTERIOR ALUM. GLAZING SYSTEM AS SPECIFIED

ALUM. COMPOSITE METAL PANEL AS SPECIFIED

CANOPY AS SPECIFIED. REFER TO DETAILS

ALUM. SHADING SYSTEM AS SPECIFIED

GRANITE VENEER AS SPECIFIED

ALUM. COPING AS SPECIFIED

LETTERING "A" AS SPECIFIED

FLAG POLE AS SPECIFIED

NK ARCHITECTS

95 WASHINGTON STREET, MORRISTOWN, NJ 07960

THE WOOLWORTH BUILDING 233 BROADWAY SUITE 2150, NEW YORK, NY 10279 t. 212.982.7900

STEPHEN P. ALUOTTO, AIA PAUL J. DRAGO, AIA WALTER J. KNEIS, AIA ALLEN R. KOPELSON, AIA BEN P. LEE, AIA

www.nkarchitects.com



AI 17503

AI 10867

AI 05644

THIS DOCUMENT IS THE EXCLUSIVE PROPERTY OF NK ARCHITECTS. THE DOCUMENT AND THE INFORMATION IT CONTAINS MAY NOT BE REPRODUCED OR USED FOR OTHER THAN THE SPECIFIC PROJECT FOR WHICH IT WAS PREPARED WITHOUT THE EXPLICIT CONSENT OF NK ARCHITECTS.



HUDSON COUNTY COMMUNITY **COLLEGE**

> **MIXED-USE ACADEMIC BUILDING** Jersey City, NJ

ELEVATIONS FOR REFERENCE

KEY PLAN

EXTERIOR ELEVATIONS

09/15/2022 SCALE

1/8" = 1'-0" DRAWN

VA

CHECKED RH

DRAWING NUMBER

REFER TO A400 SERIES DRAWINGS FOR TYPICAL WALL SECTIONS AND ADDITIONAL INFORMATION.

3. REFER TO CIVIL DRAWINGS FOR FINISHED GRADE AND FLOOR HEIGHTS.


DESCRIPTION


STRUCTURAL FRAMELESS GLAZING AS SPECIFIED. REFER TO FLOOR PLAN AND DETAILS


ACCESS LADDER WITH LOCKABLE DOOR AS SPECIFIED. REFER TO ENLARGED FLOOR PLANS, SECTION AND DETAILS


ALIGN VERTICAL JOINTS

SK.01

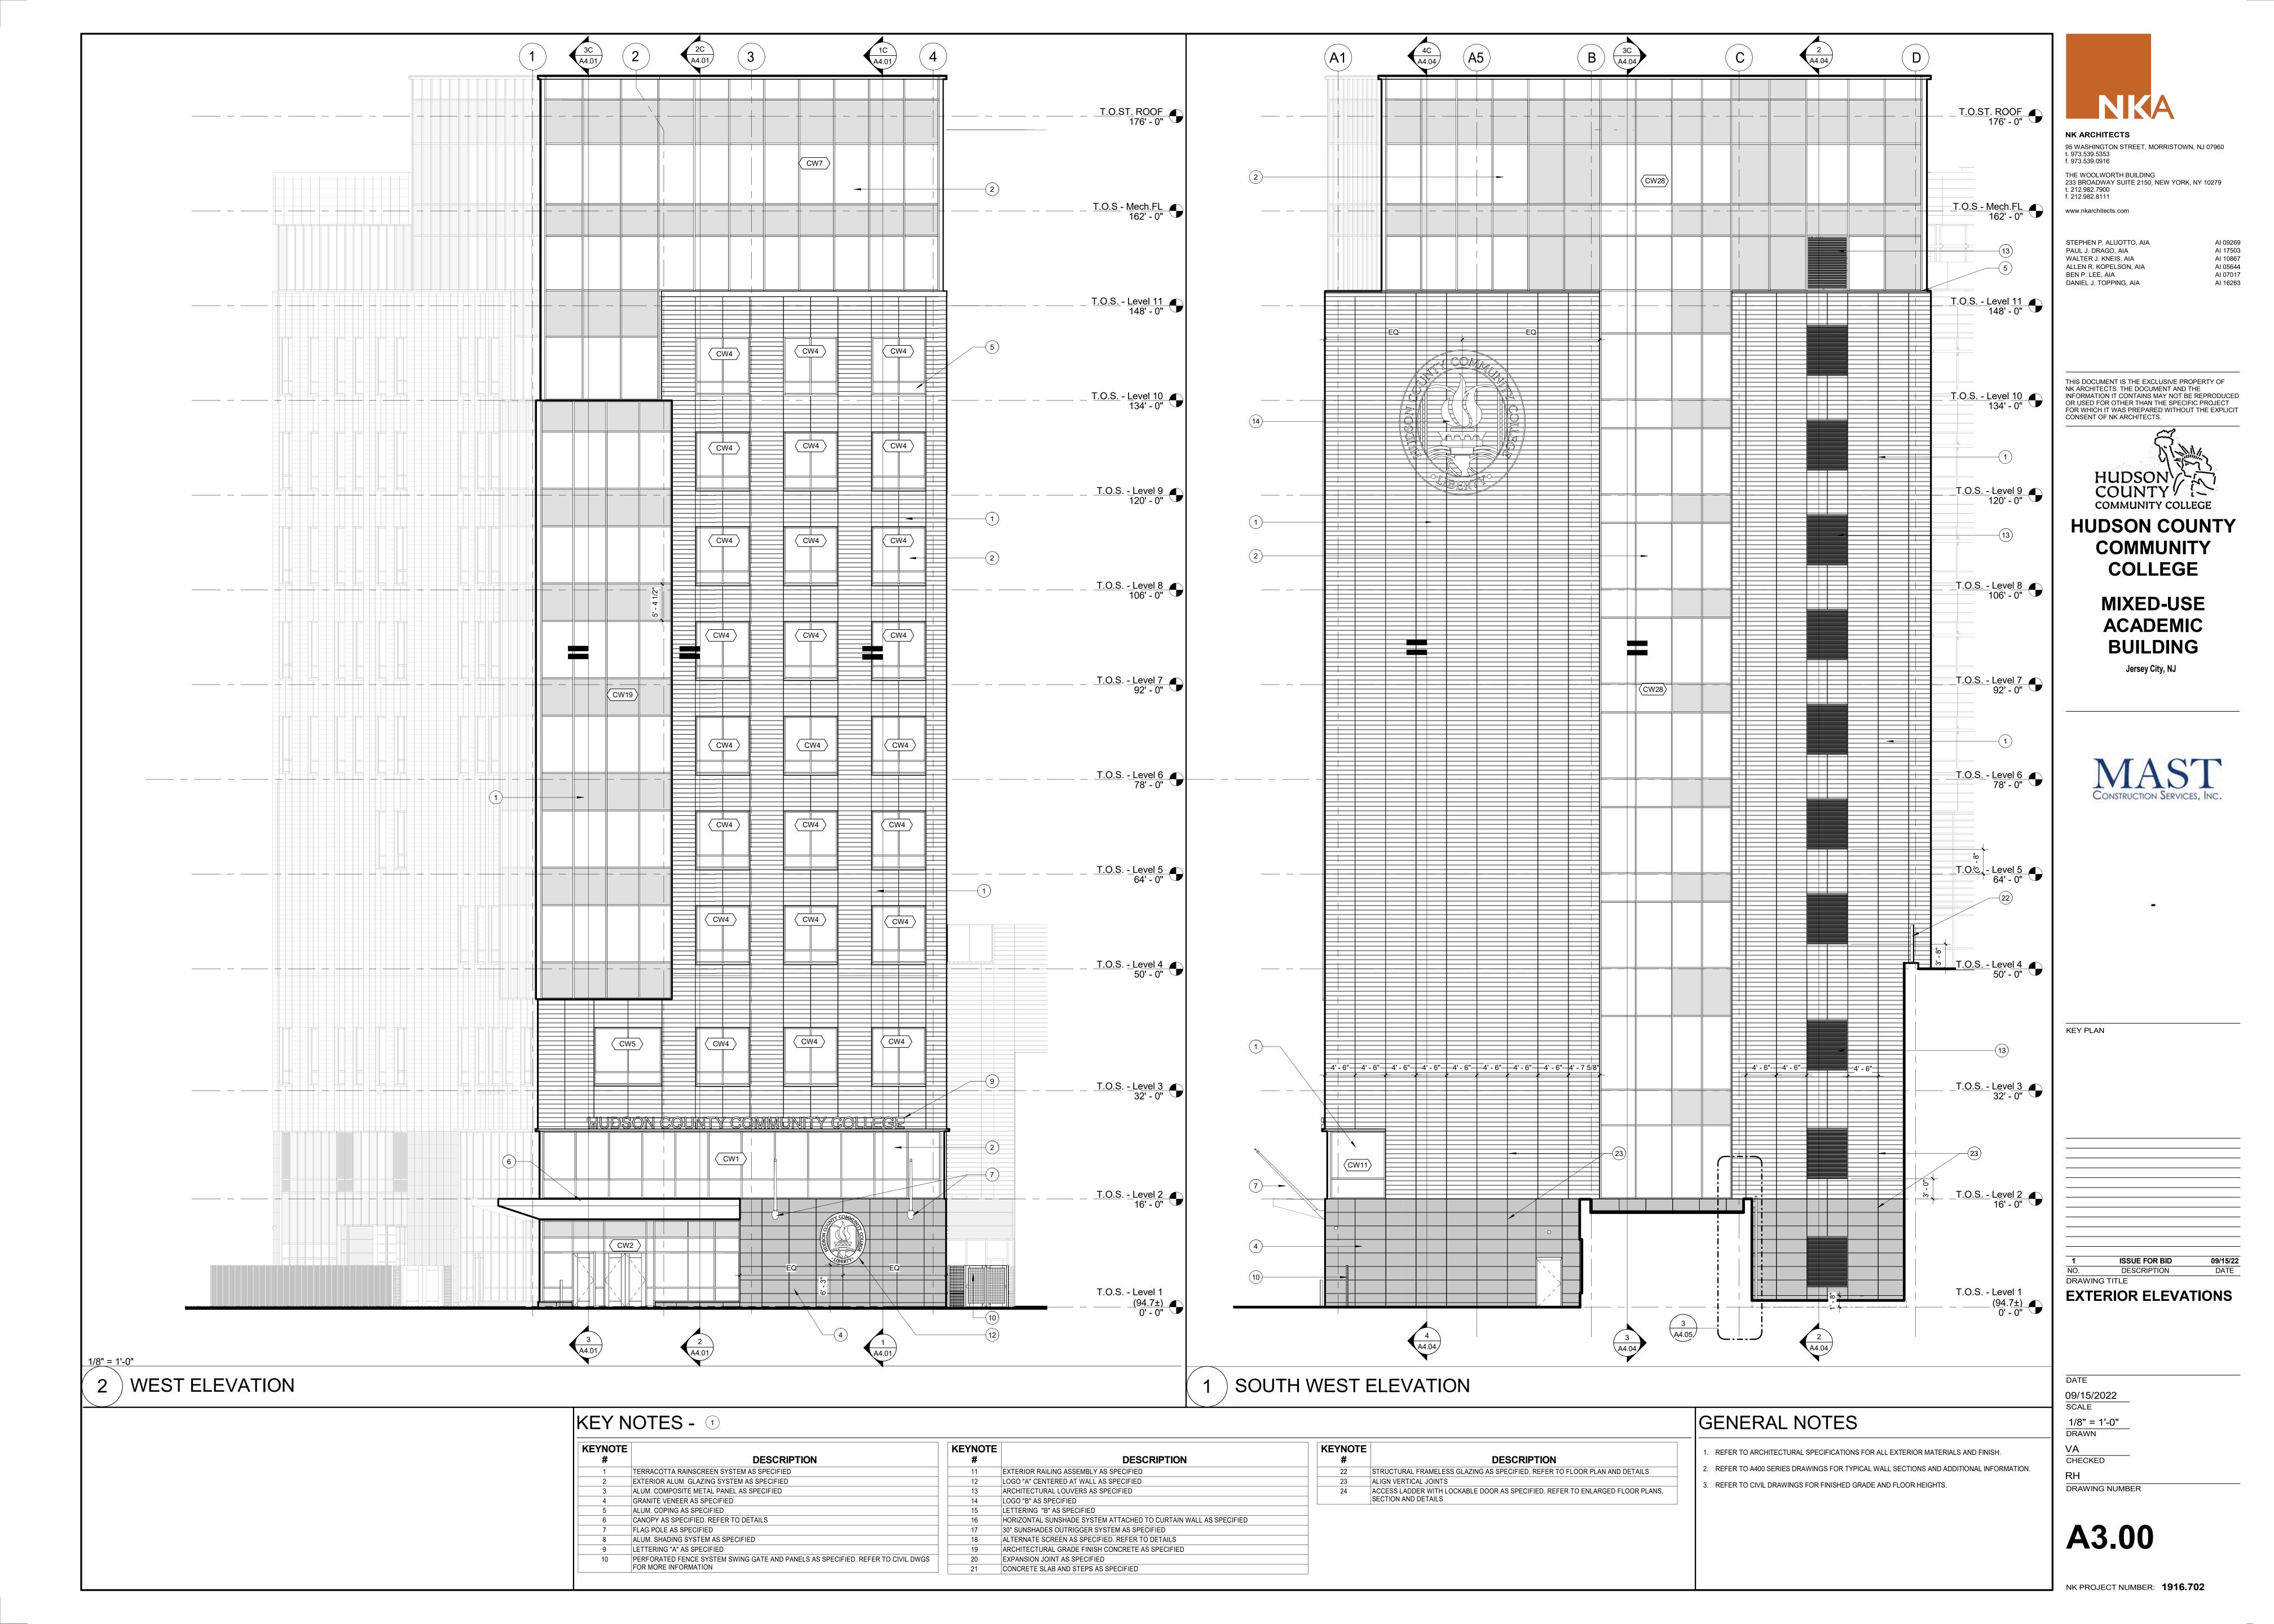

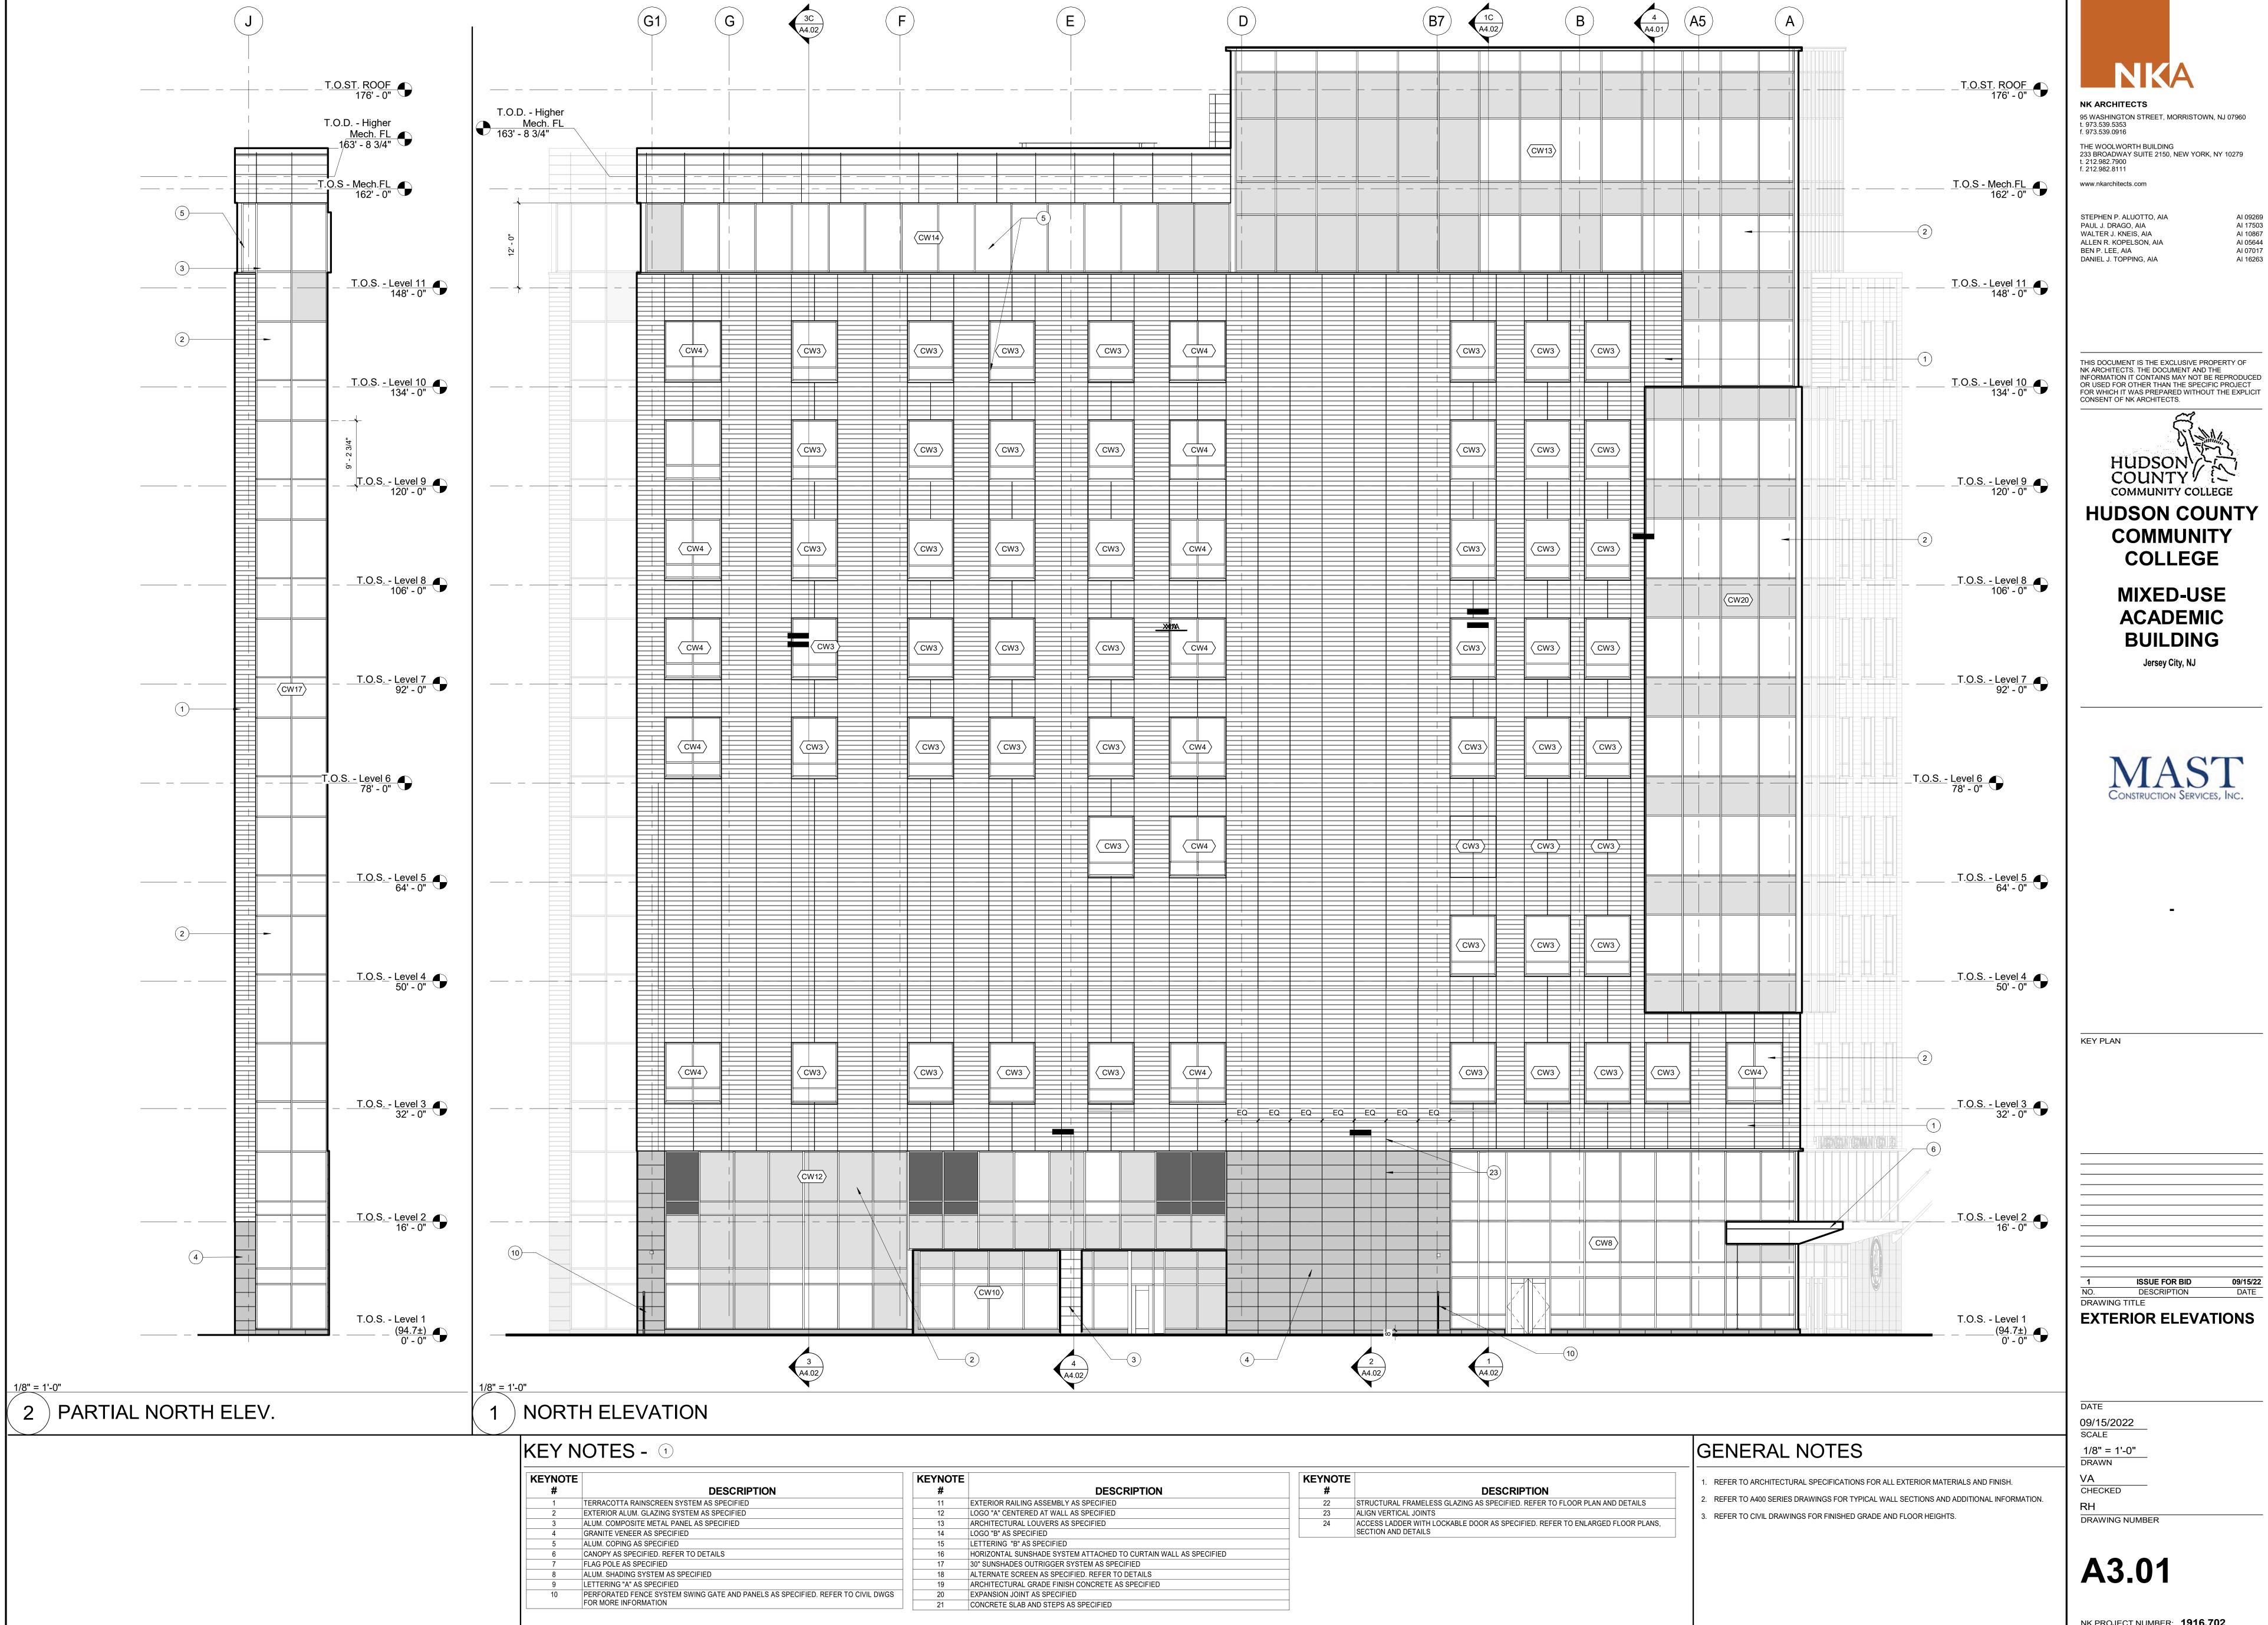

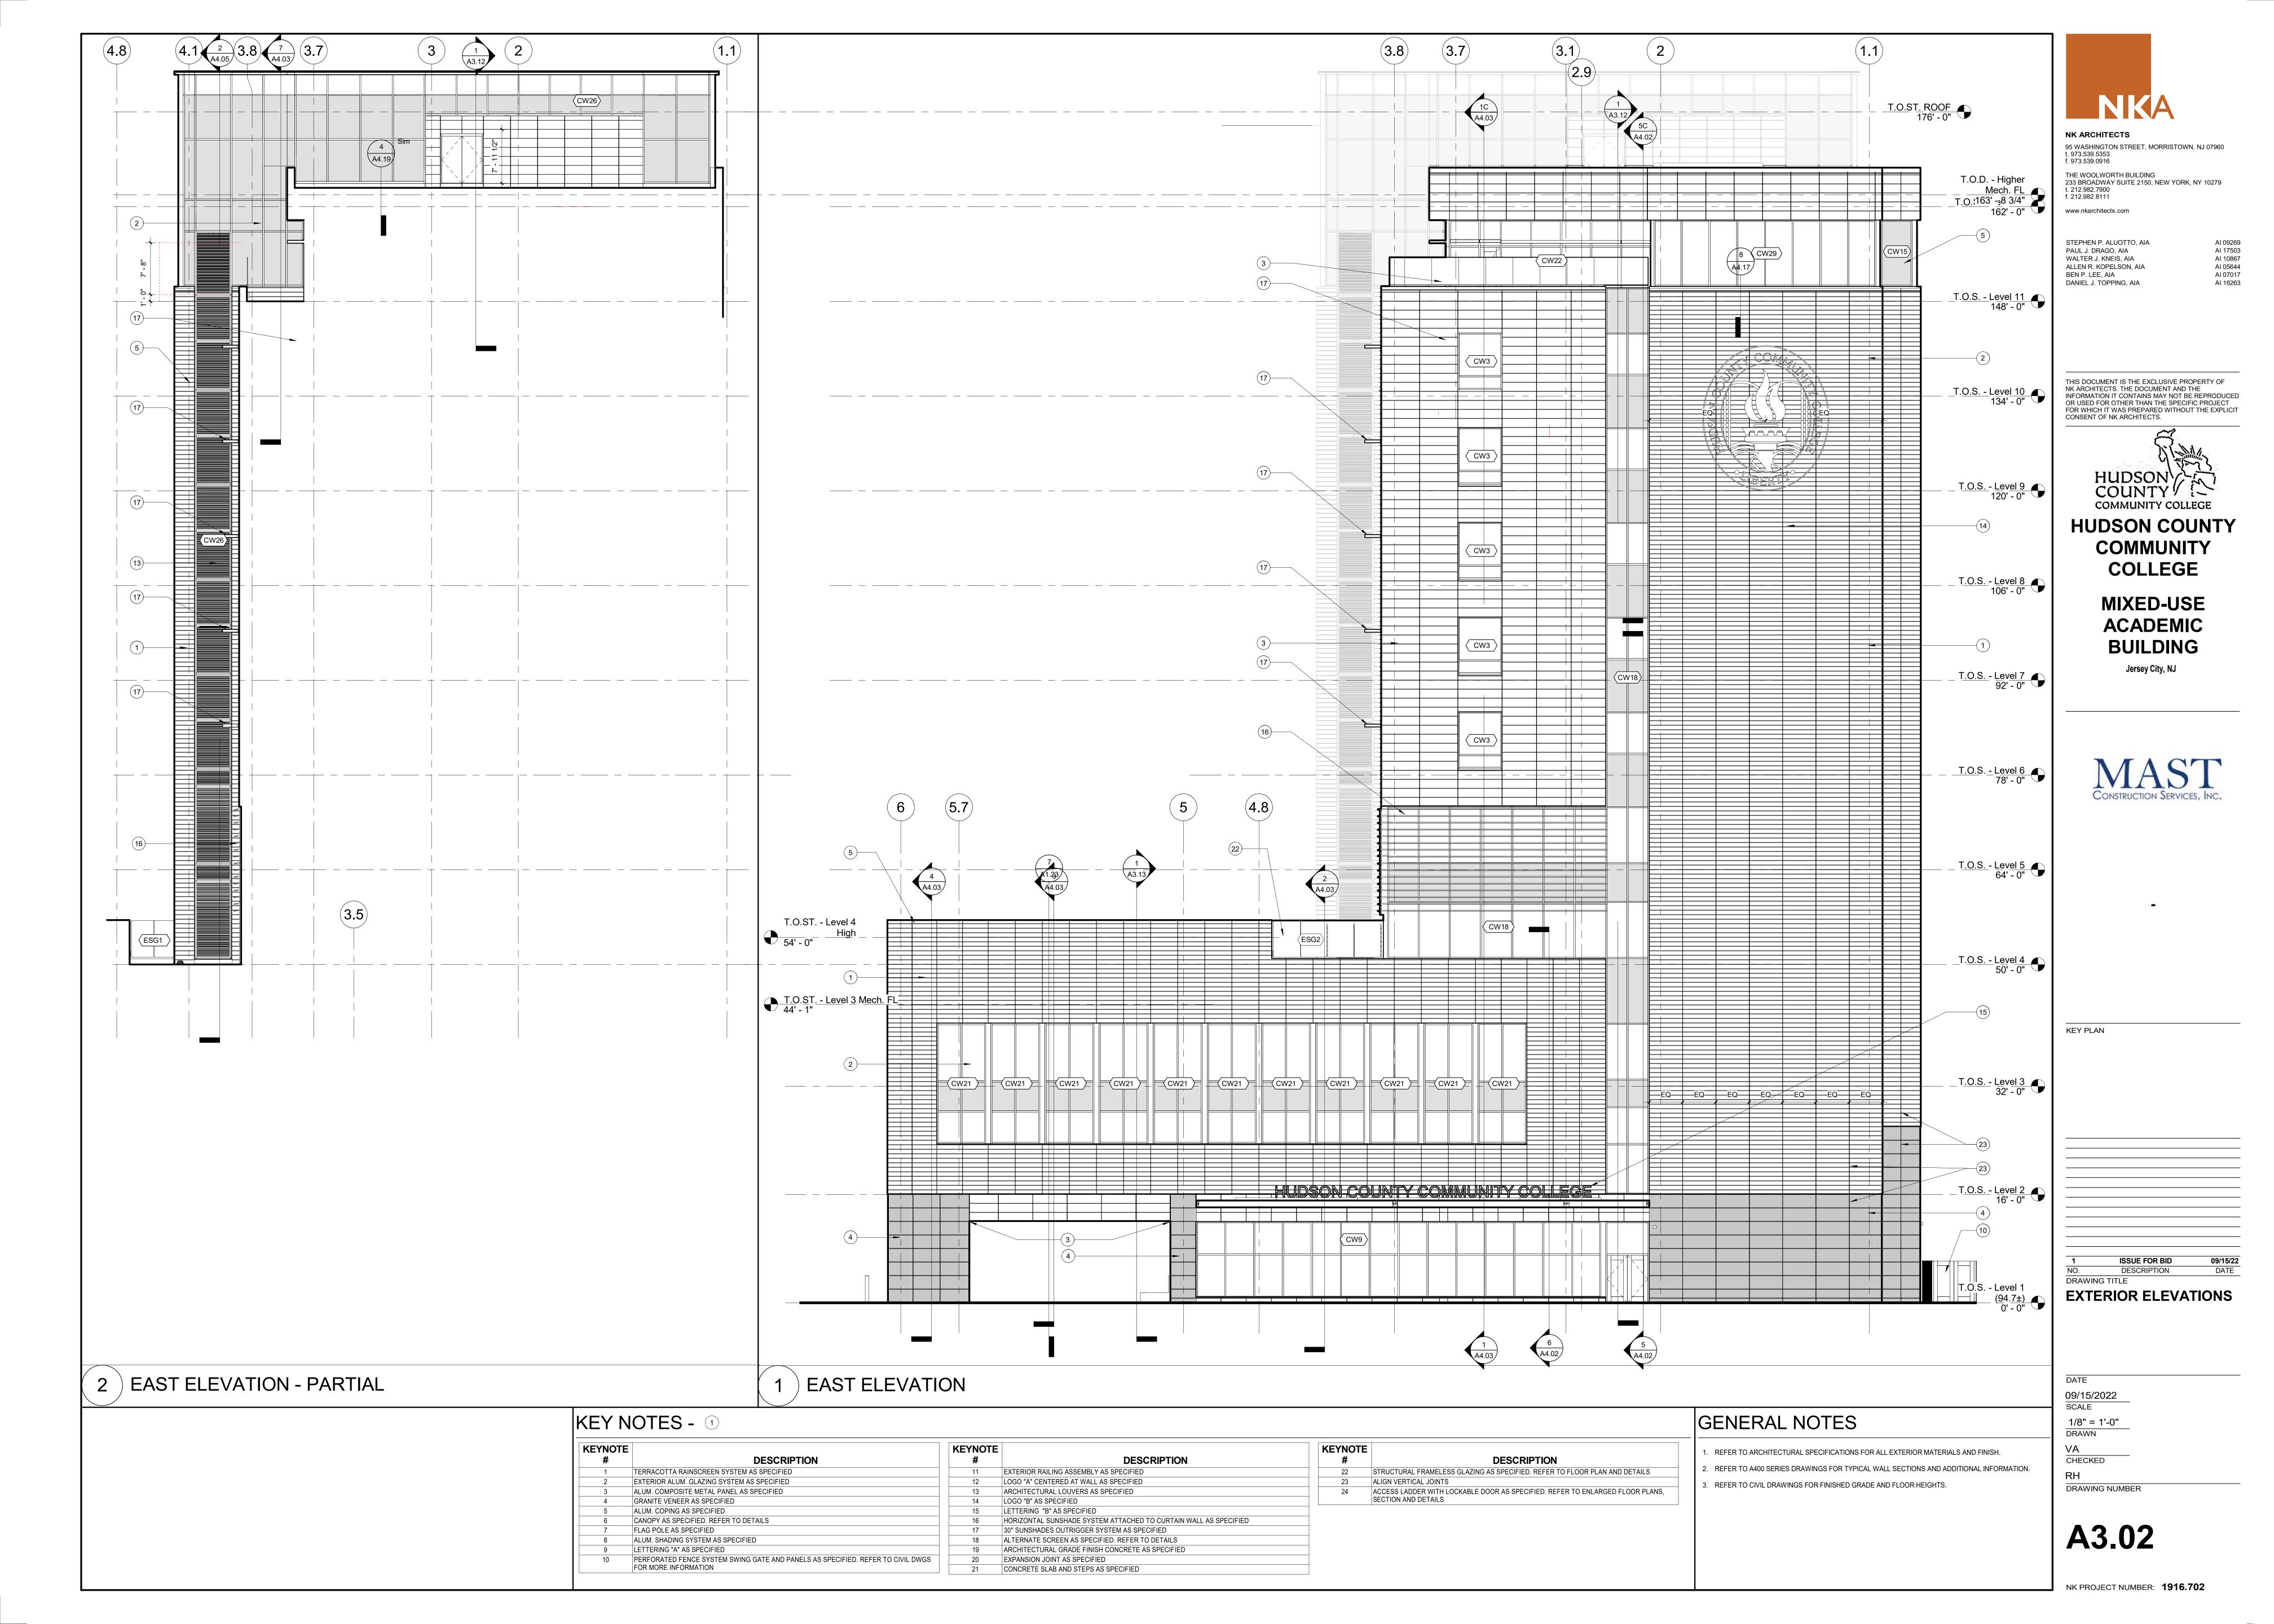

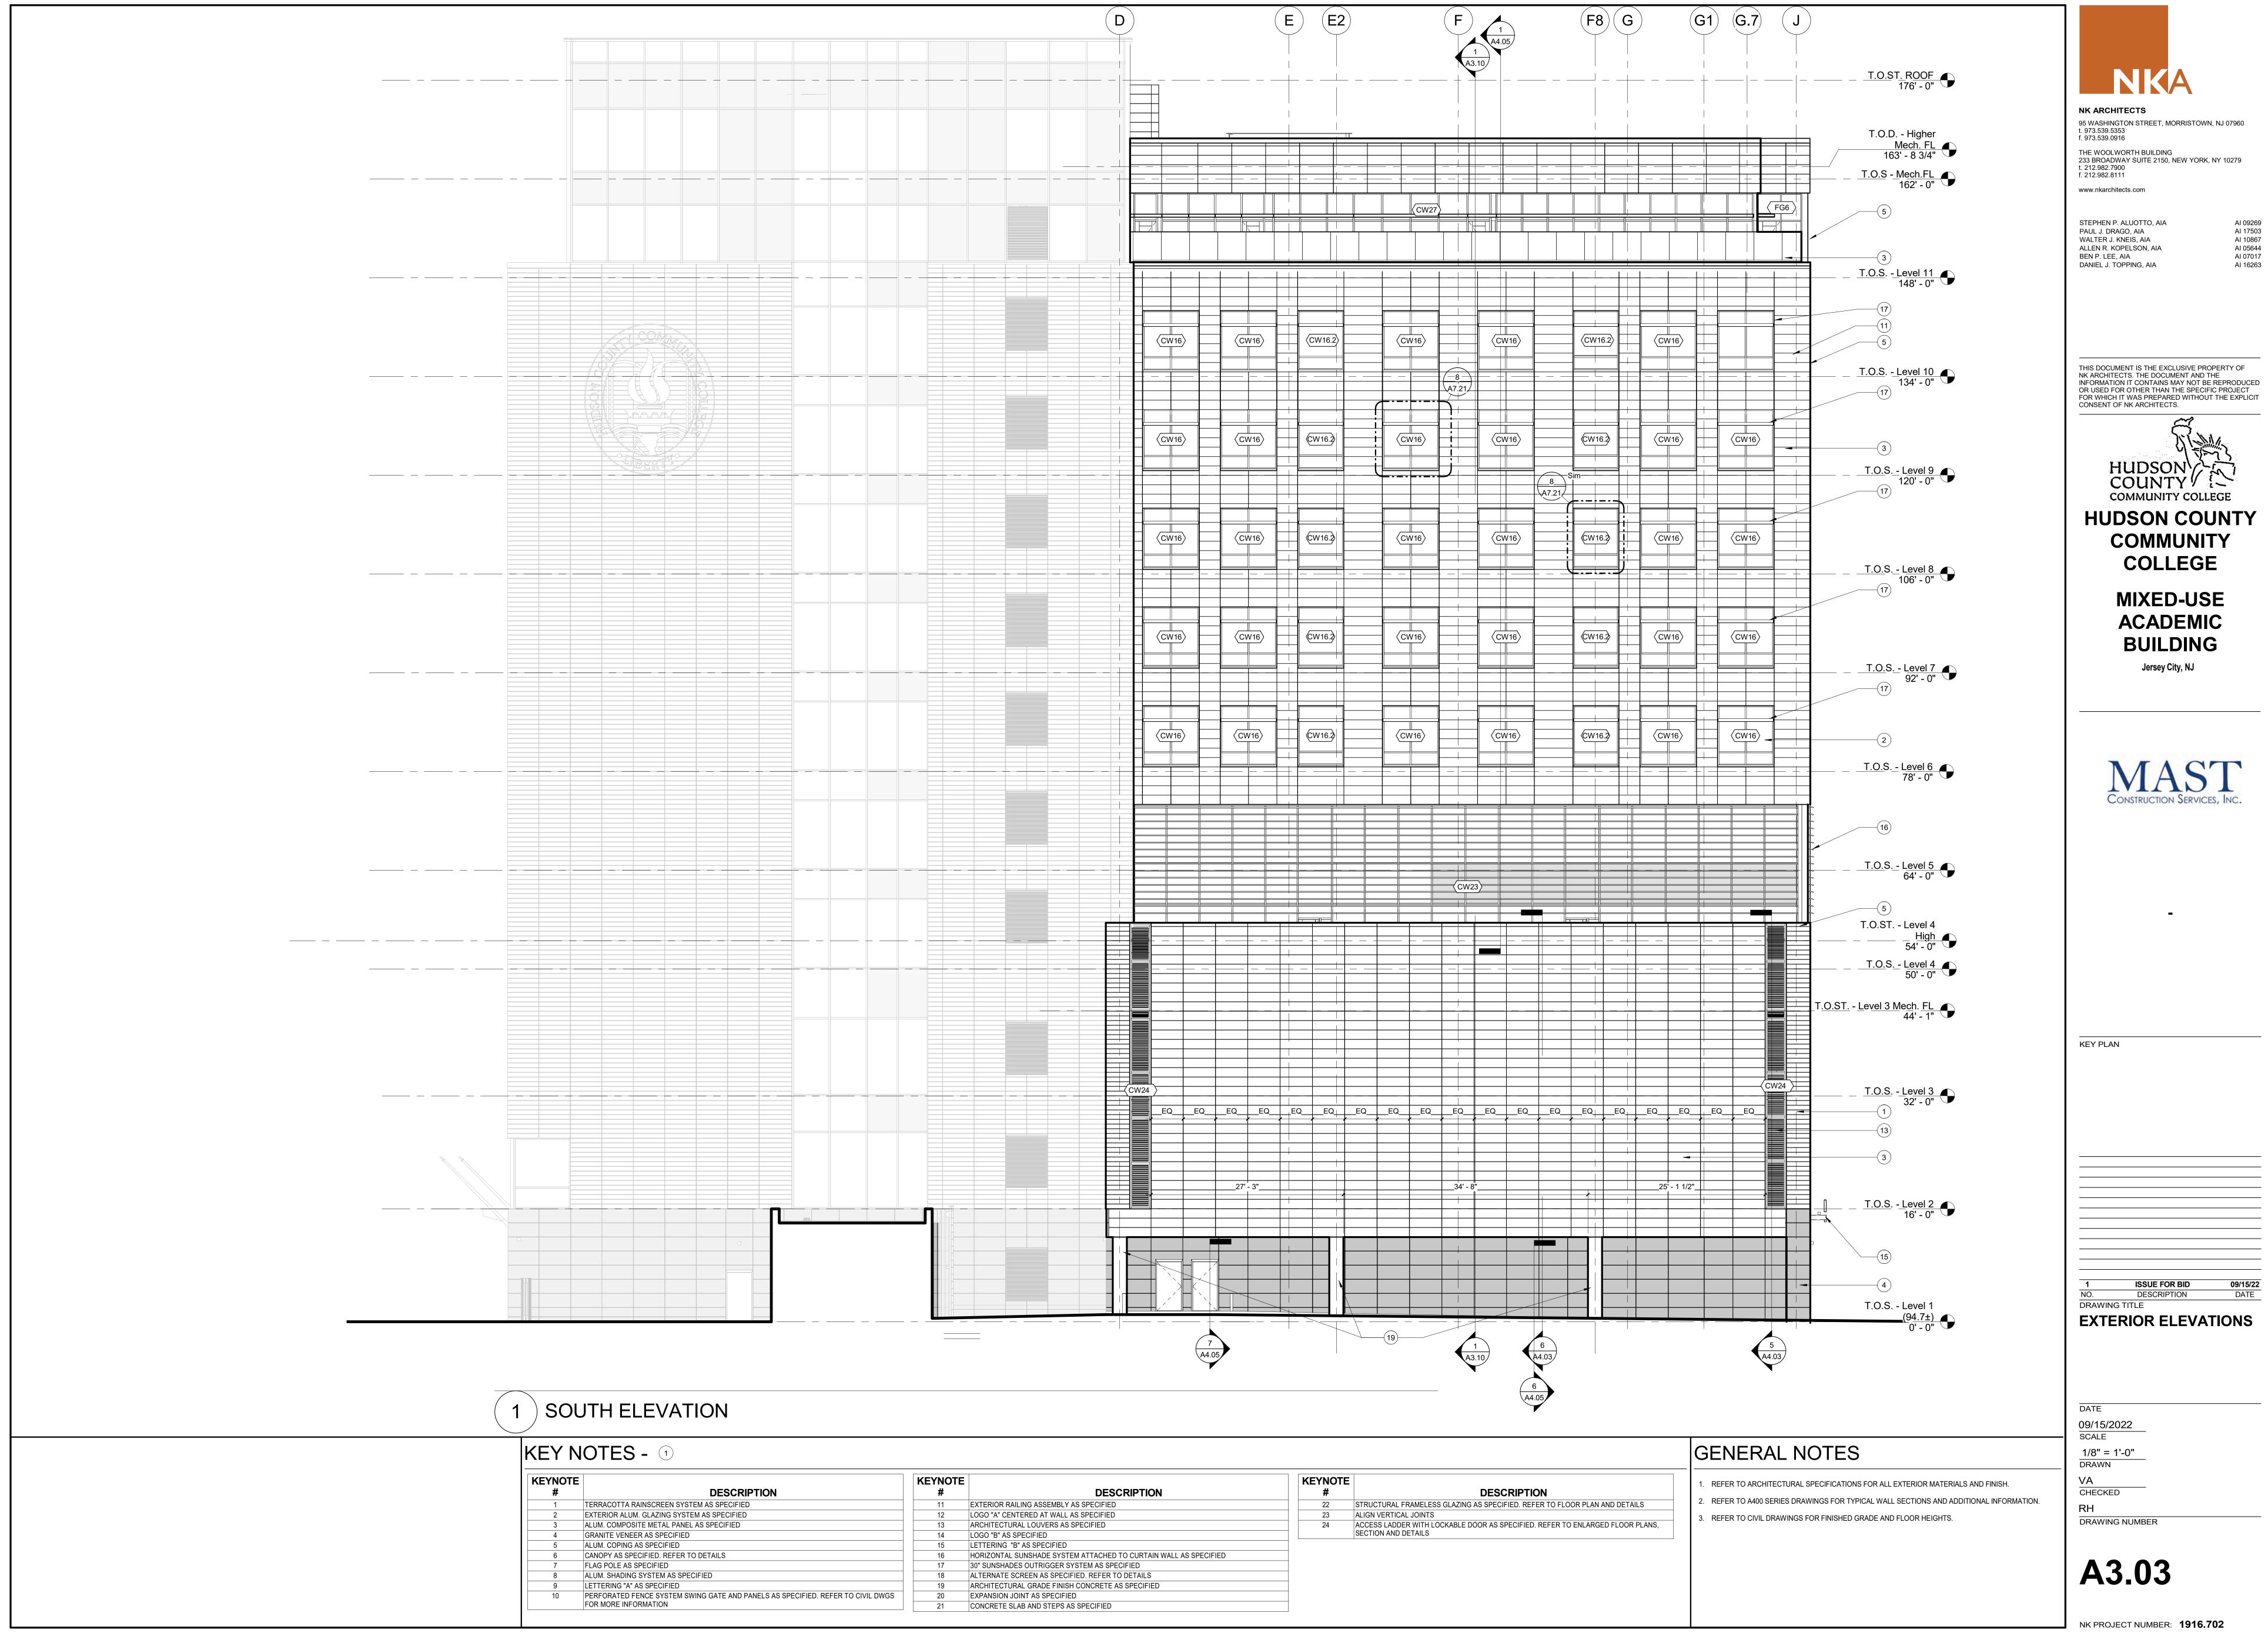

THIS DOCUMENT IS THE EXCLUSIVE PROPERTY OF NK ARCHITECTS. THE DOCUMENT AND THE

