

VIEW FROM ENOS PLACE





ELEVATIONS FOR REFERENCE



PROPOSE NEW

MIXED-USE ACADEMIC BUILDING

Jersey City, NJ

PROJECT DIRECTORY

OWNER

HUDSON COMMUNITY COLLEGE

70 SIP AVENUE
JERSEY CITY, NEW JERSEY 07306
(201) 360-4052

OWNER REPRESENTATIVE
MAST CONSTRUCTION SERVICE, INC
96 EAST MAIN STREET, SUITE 2

LITTLE FALLS, NJ 07424

CONTACT: TROY MARZZIOTTI, VICE-PRESIDENT

CIVIL ENGINEER

NEGLIA ENGINEERING ASSOCIATES

34 PARK AVENUE, PO BOX 246
LYNDHURST, NJ 07071
(201) 939-8805

CONTACT: ANTHONY KURUS, P.E.

ARCHITECTS/INTERIOR DESIGNERS
NK ARCHITECTS
95 WASHINGTON STREET

MORRISTOWN, NJ 07960 (973) 539-5353 CONTACT: STEPHEN P. ALUOTTO

STRUCTURAL ENGINEER

STRUCTURE STUDIO

93 WASHINGTON STREET

MORRISTOWN, NJ 07960
(973) 656-0500

CONTACT: MARK VON BRADSKY, PE

LUONGO ASSOCIATES, P.A.

501 AMERICAN LEGION WAY
POINT PLEASANT BEACH, NEW JERSEY, 08742
(732) 295-8500
CONTACT: GERARD C. LUONGO, P.E., P.P.

TECHNOLOGY CONSULTANT
THE CLARIENT GROUP
485C ROUTE 1 SOUTH, SUITE 200


CONTACT: CHARLES J. BUSCARINO


ISELIN, NJ 08830

(212) 586-5840

MEP ENGINEER LUONGO ASSOCIATES, P.A.

KEY PLAN

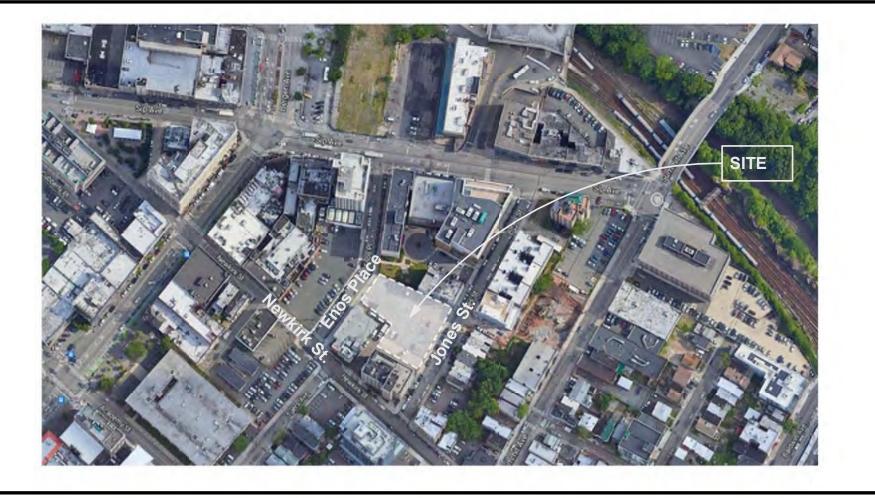

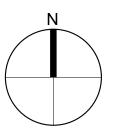

5 WASHINGTON STREET, MORRISTOWN, NJ 0 973.539.5353 973.539.0916 HE WOOLWORTH BUILDING

> AI 17503 AI 10867

THE WOOLWORTH BUILDING
233 BROADWAY SUITE 2150, NEW YORK, NY 10279
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COMMUNITY COLLEGE MIXED-USE

ACADEMIC BUILDING Jersey City, NJ

CONSTRUCTION SERVICES, INC.

KEY PLAN

ISSUE FOR BID 09/15/2

DESCRIPTION DATE
WING TITLE


GENERAL INFORMATION


DATE 09/15/2022 SCALE

DRAWN

DRAWING NUMBER

G0.01

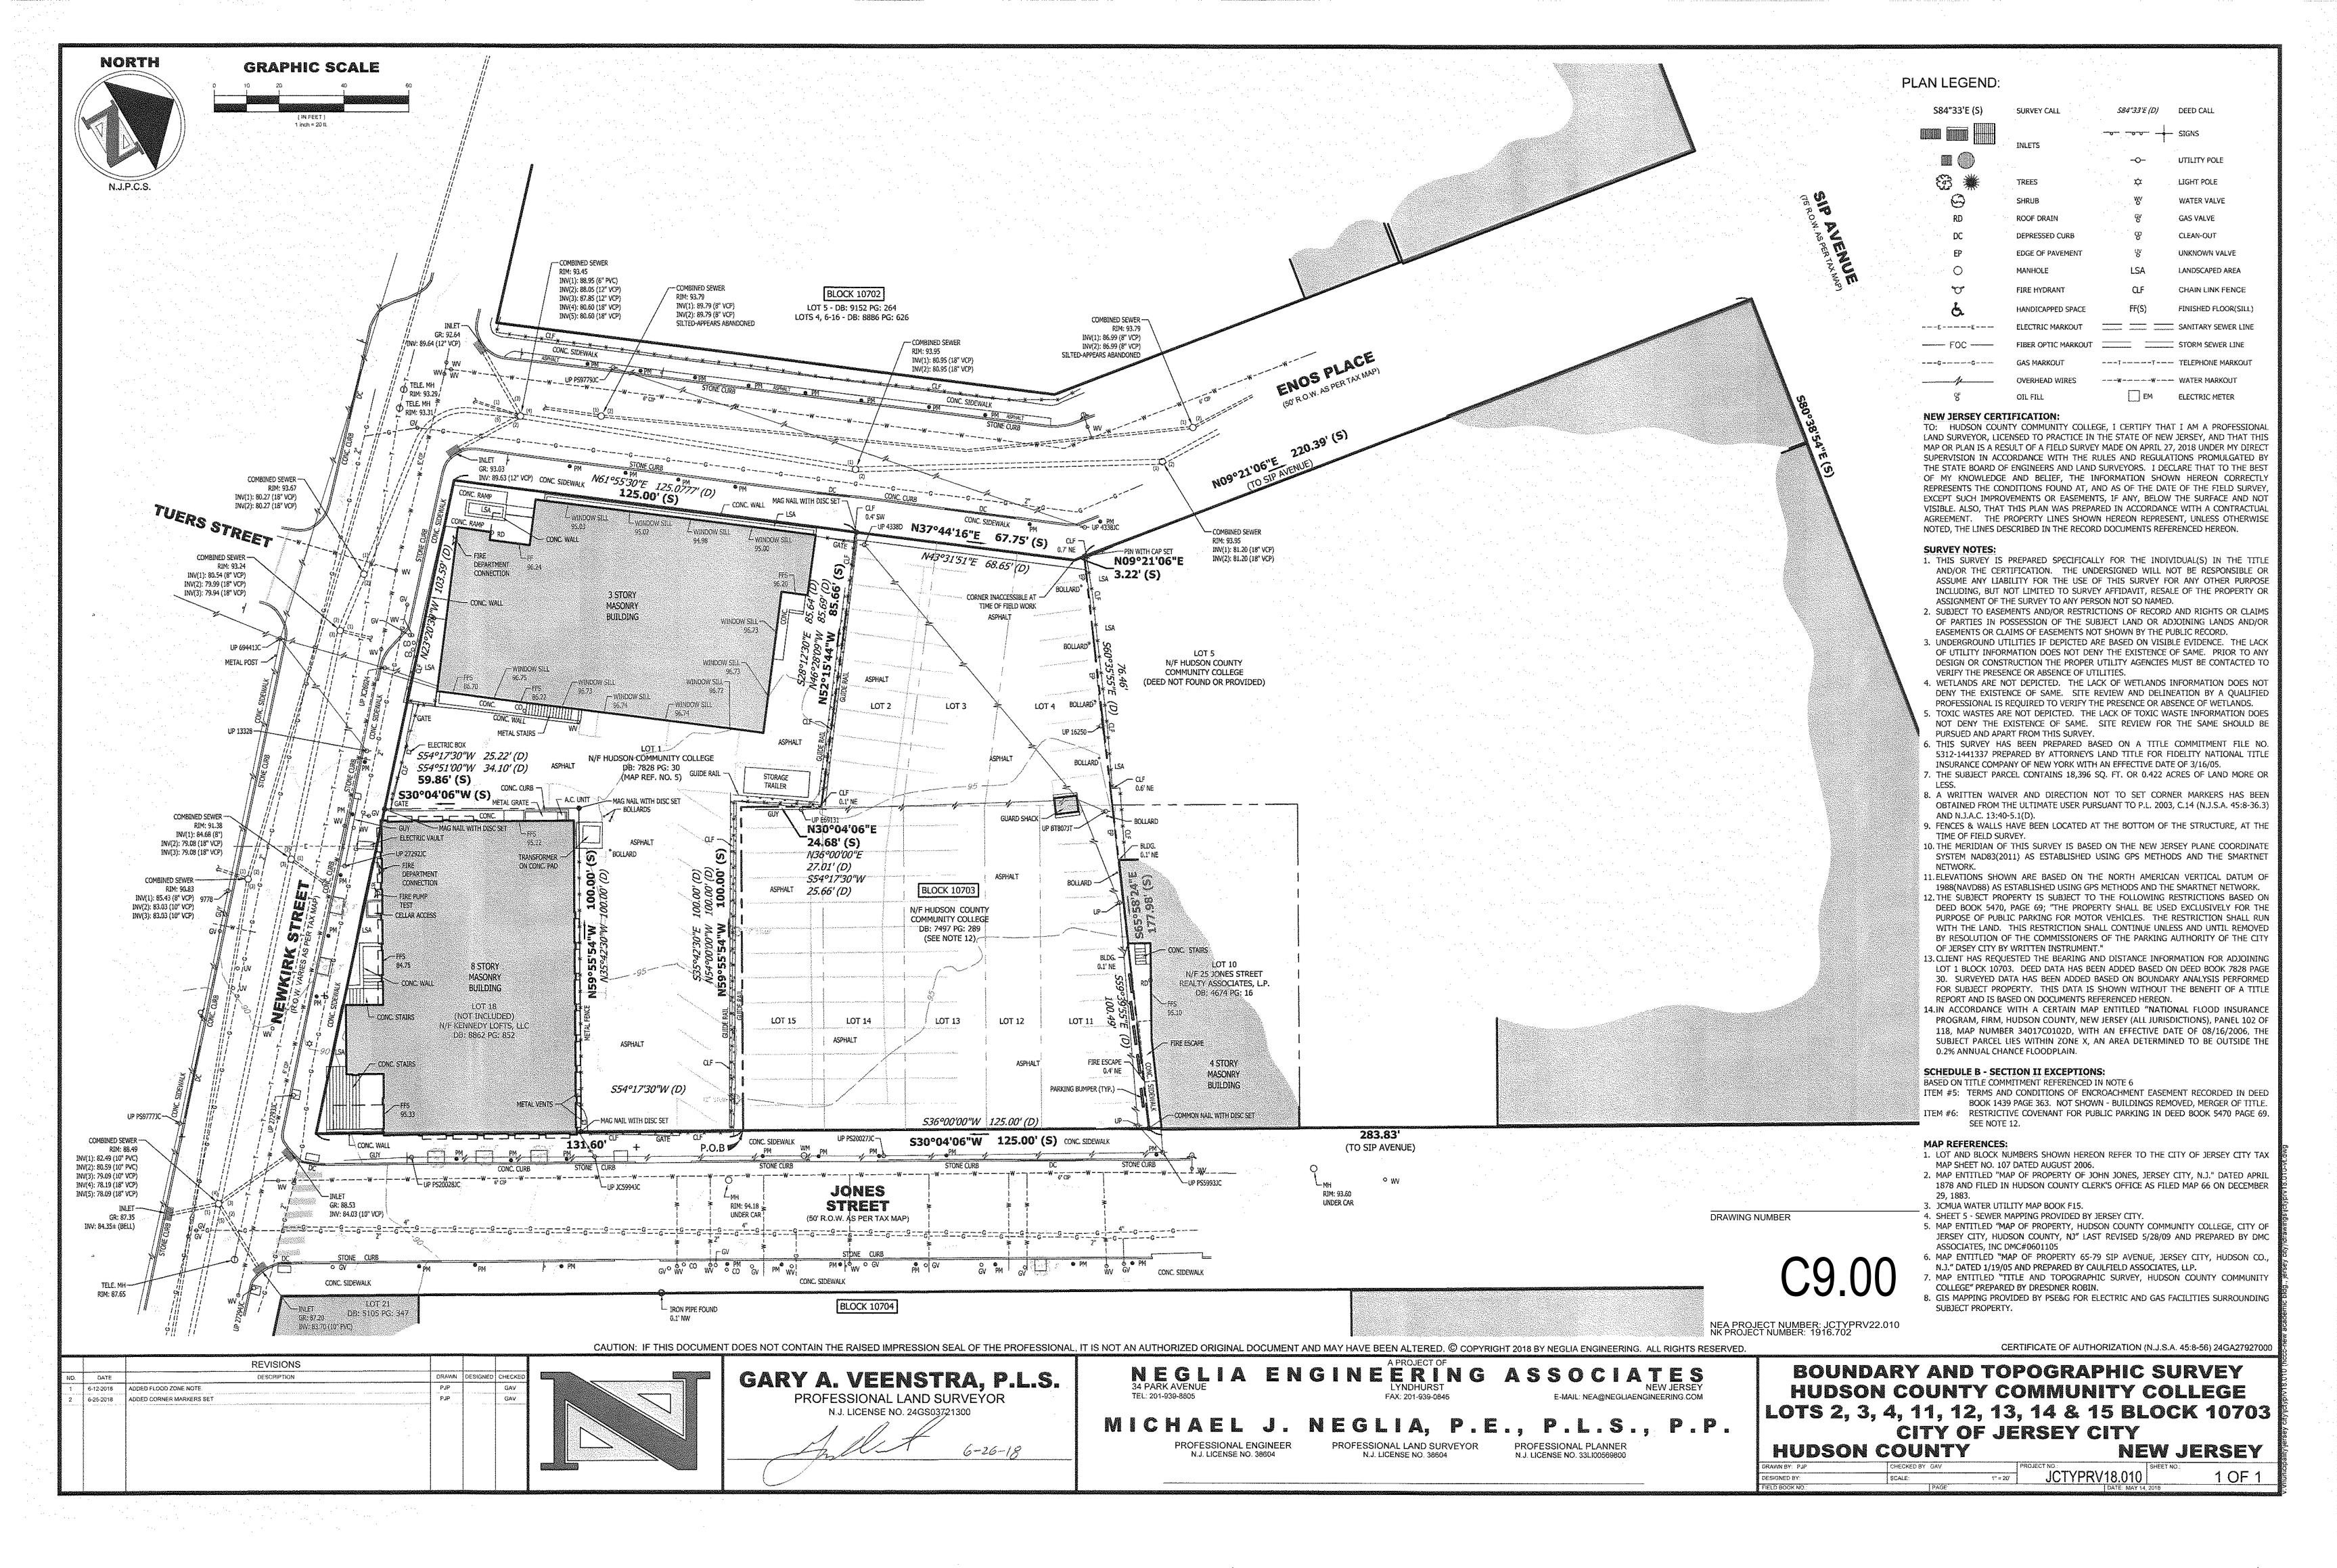

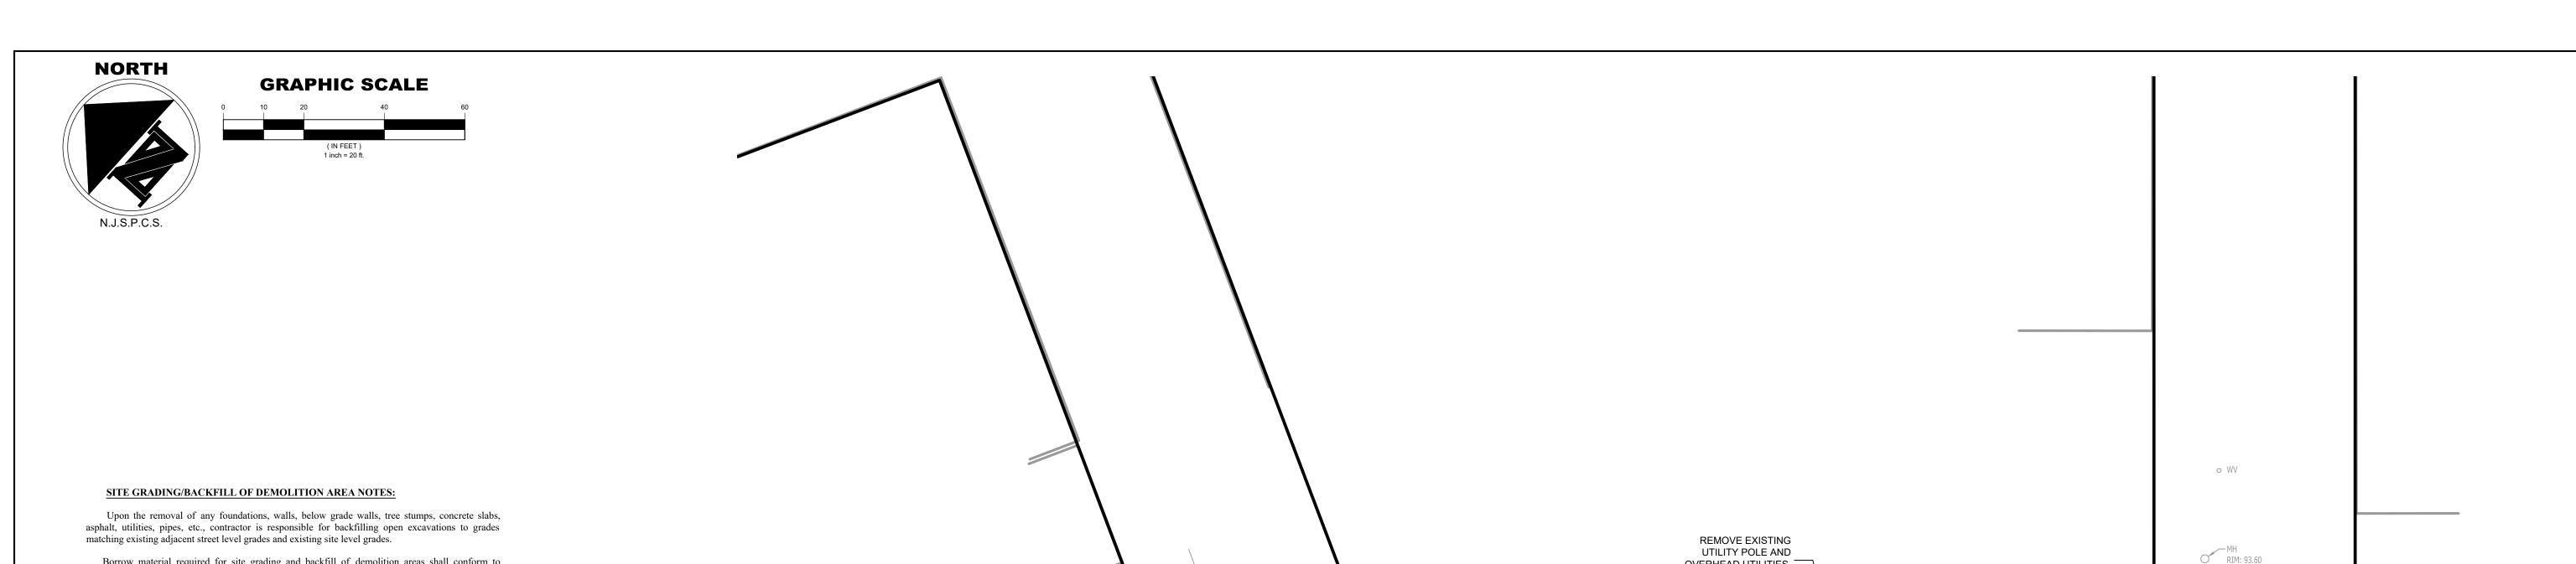

APPROXIMATE LOCATION OF PRE-EXISTING

BUILDING FOOTPRINTS PER HISTORICAL

MAPPING. CONTRACTOR SHALL REMOVE

CONSTRUCT THE PROJECT. TYP FOR ALL

COMBINED SEWER -

ALL BELOW GRADE OBSTRUCTIONS (I.E. ₹

BELOW GRADE WALLS, SLABS, ETC)

ENCOUNTERED AS NECESSARY TO

FOUNDATIONS, FOUNDATION WALLS,

(SEE NOTES)

CONSTRUCTION

REMOVE EXISTING

OVERHEAD UTILITIES.

CONTRACTOR TO

COORDINATE WITH

UTILITY AUTHORITIES

COMBINED SEWER -

INV(1): 80.95 (18" VCP)

DEMO/REMOVE

GUARD RAIL

AND FENCING

CONTRACTOR TO

OF 2 ENOS FIBER

DESIGN BY OTHERS

RELOCATION/RE-FEEDING -

CONNECTION WITH UTILITY AUTHORITY AND TELCOM

COMBINED SEWER —

INV(1): 89.79 (8" VCP)

INV(2): 89.79 (8" VCP)

SILTED-APPEARS ABANDONED

COMBINED SEWER —

RIM: 93,45 INV(1): 88.95 (6" PVC)

RIM: 93.79

COORDINATE

RIM: 93.95

ENOS

COMBINED SEWER -

INV(1): 80.27 (18" VCP) INV(2): 80.27 (18" VCP)

RIM: 93.67

COMBINED SEWER — RIM: 93.24

INV(1): 80.54 (8" VCP)

INV(2): 79.99 (18" VCP)

INV(3): 79.94 (18" VCP)

UTILITY POLE UP4338D AND -

FENCE (SEE NOTES

OVERHEAD UTILITIES.

UTILITY AUTHORITIES

DISCONNECT

UTILITIES AND >

REMOVE

GUARD

SHACK

EXISTING ASPHALT

REMOVE EXISTING

CONTRACTOR TO

REMOVE .

COORDINATE WITH

UTILITY AUTHORITIES

UTILITY POLE UP4BT807JT

AND OVERHEAD UTILITIES.

DEMO/REMOVE

AND FENCING

CONSTRUCTION

FENCE AND

RIM: 90.83

INV(1): 85.43 (8" VCP)

INV(2): 83,03 (10" VCP) INV(3): 83.03 (10" VCP)

RIM: 91.38

INV(1): 84,68 (8")

INV(2): 79.08 (18" VCP)

INV(3): 79.08 (18" VCP)

ACCESS GATE

GUIDE RAIL

TREE STUMP

REMOVE EXISTING

OVERHEAD UTILITIES.

- COMBINED SEWER

INV(1): 81.20 (18" VCP) INV(2): 81.20 (18" VCP)

DEMO/REMOVE

BOLLARDS

RIM: 93.95

UTILITY POLE

UP4BT807JT AND -

CONTRACTOR TO

COORDINATE WITH

REMOVE

TRAILER

STORAGE

WINDOW SILL

WINDOW SILL -

WINDOW SILL —

UTILITY AUTHORITIES

CONTRACTOR TO

COORDINATE WITH

Borrow material required for site grading and backfill of demolition areas shall conform to section 201 of the NJDOT Standard Specifications. Borrow material required shall be composed of clean, well drained granular soils and shall be Certified Clean Fill. The Contractor shall provide the Engineer with certification attesting that the said material is free of contaminants and suitable for use as backfill. Borrow material shall be smooth, soft and free of depressions, clods, mounds, stones, or other debris and shall be approved by the Engineer.

Backfill shall be placed uniformly in layers not to exceed twelve (12) inches loose thickness. Each layer shall be compacted to 95% density. Backfill shall be constructed in accordance with methods specified within the NJDOT standard specification section 203. All depressions, holes, openings, low spots created by site demolition shall be refilled with approved borrow material and solidly compacted in lifts in accordance with NJDOT standard specifications as noted above so as to make the finished ground surface at these locations match/conform with the adjoining grades.

Demolition Plan Notes

- Before the demolition work is started, contractor shall obtain all permits required by Federal, State, and local jurisdictions for all phases and operations of the Work.
- 2. Burning debris is prohibited.
- The use of explosives is prohibited.
- 4. Protect utilities during the Work of this Section.
- 5. Contractor shall verify the location and status of all utilities within and surrounding the demolition limits.
- 6. Disconnection of all utility services, including sewer, water, gas, and electric lines, and plugging and capping of services shall be in accordance with the requirements of all Municipal and Public Services Corporations.
- 7. Remove and dispose of concrete and bituminous pavement and sidewalk, trees, shrubs, hedges, brush, stumps, roots, dirt, stone, debris, surplus materials and rubbish, as shown or otherwise directed.
- 8. Remove curbs, slabs on grade, and fences as shown or directed otherwise.
- Repair any and all damages or injury to the adjoining properties caused by the work and leave the properties in as good condition as before work was started. The Contractor shall relieve the Owner of all responsibility for any claims due to such injury and shall defend any action brought by reason thereof.
- 10. If so directed, the Contractor shall thoroughly wet the work to prevent dust.
- 11. Protect trees not designated for removal as shown on the Plans.
- 11. Remove demolition debris and excess fill from the project site as soon as practicable.
- 12. Transport demolition debris and excess fill to designated disposal area as soon as practicable. Grade disposal areas to adjacent contours and slope to drain.
- 13. Do not store, sell, or burn materials on Borough property.
- The removal and disposal of materials and debris accumulated by clearing site is regulated under the Solid Waste Management Act (NJSA 13:1 E-1) and is governed by NJAC 7:26 et seq. The Contractor shall dispose of the material and debris according to the solid waste management plan developed by the solid waste management district of origin. Proper documentation from the disposal facility shall be submitted to the Engineer.
- 15. All demolition work shall be in accordance with local, county, state and federal regulations.
- 16. The contractor is specifically cautioned that the location and or records of the various utilities shown on these plans is based on records of the various utility companies and where possible field measurements. The information is not to be relied on as being complete or exact. A ground penetrating radar survey has not been conducted for the project. The contractor must contact all the appropriate utility companies at least 48 hours before any work or excavation to request a field mark out of existing utilities. The contractor must call 1800-242-1000 before commencement of work. It shall be the contractor's responsibility to locate all on site utilities prior to start of demolition work.
- 17. Contractor shall prepare and submit for approval by the owners engineer a plan detailing the locations of the temporary fencing, gates, barricades and other items required to secure the demolition work area and to protect the public. Location of temporary construction fencing and gates shown on plan is approximate and is subject to approval of owner prior to construction. Contractor shall include in his price bid all costs to secure project site with fencing, barricades, and gates.

GENERAL NOTES:

- 1. EXISTING TOPOGRAPHIC AND BOUNDARY SURVEY INFORMATION WAS OBTAINED FROM A PLAN ENTITLED "BOUNDARY AND TOPOGRAPHIC SURVEY, HUDSON COUNTY COMMUNITY COLLEGE, LOTS 2, 3, 4, 11, 12, 13, 14 & 15, BLOCK 10703, CITY OF JERSEY CITY, HUDSON COUNTY, NEW JERSEY" PREAPRED BY NEGLIA ENGINEERING AND ASSOCIATES, DATED MAY 14, 2018.
- 2. DEMOLITION WORK SHALL INCLUDE ITEMS DENOTED ON THIS PLAN AND ANY ADDITIONAL DEMOLITION WORK NECESSARY FOR PROPOSED SITE WORK AS DEPICTED ON THE SITE PLAN DRAWINGS.
- 3. CONTRACTOR SHALL BE ADVISED THAT THERE MAY BE BURIED/BELOW GRADE BUILDING FOUNDATIONS, BURIED/BELOW GRADE CONCRETE WALLS, BURED/BELOW GRADE CONCRETE SLABS ASSOCIATED WITH STRUCTURES THAT PREVIOUSLY EXISTING ON THE PROPERTY. THE LOCATION OF THE PRE-EXISTING BUILDING FOUNDATIONS SHOWN ON THIS PLAN ARE APPROXIMATED AS PER HISTORICAL SANBORN MAPPING. CONTRACTOR SHALL REMOVE ANY BELOW GRADE OBSTRUCTIONS AS NECESSARY TO CONSTRUCT THE PROJECT AS PER PLANS AND SPECIFICATIONS.
- 4. ANY UTILITIES ENCOUNTERED ON SITE THAT ARE TO BE DISCONTINUED SHALL BE CUT/CAPPED AT THE PROPERTY LINE IN ACCORDANCE WITH ALL UTILITY AUTHORITY REQUIREMENTS.

NK ARCHITECTS 95 WASHINGTON STREET, MORRISTOWN, NJ 07960

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HUDSON COUNTY COMMUNITY COLLEGE MIXED-USE ACADEMIC **BUILDING**

Jersey City, New Jersey



MICHAEL J. NEGLIA

PROFESSIONAL ENGINEER PROFESSIONAL LAND SURVEYOR PROFESSIONAL PLANNE N.J. LICENSE NO. 38604 N.J. LICENSE NO. 5698 GREGORY J. POLYNIAK, P.E., P.P.

PROFESSIONAL ENGINEER PROFESSIONAL PLANNER
N.J. LICENSE NO. 43136 NJ. LICENSE NO. 5883

ANTHONY KURUS, P.E., P.P.

PROFESSIONAL ENGINEER PROFESSIONAL PLANNER
N.J. LICENSE NO. 46445 N.J. LICENSE NO. 6145

KEY PLAN

ISSUED FOR BID DESCRIPTION

SITE DEMOLITION **PLAN**

09/15/2022 SCALE

RIM: 86.24

COMBINED SEWER —

INV(1): 77,69 (10" VCP)

INV(2): 77.49 (10" VCP)

RIM: 86.69

└─ TELE. MH

RIM: 87.65

DRAWING TITLE

1" = 20' DRAWN CHECKED

DRAWING NUMBER

NEA PROJECT NUMBER: JCTYPRV22.010 NK PROJECT NUMBER: 1916.702

GR: 87.35

RIM: 88.49

INV(2): 80.59 (10" PVC)

INV(3): 79.09 (10" VCP)

INV(4): 78.19 (18" VCP)

INV(5): 78.09 (18" VCP)

INV(1): 82.49 (10" PVC) INV: 84.35± (BELL)

UNDER CAR

REMOVE

EXISTING

PARKING

BUMPER BLOCKS

CONSTRUCTION

(SEE NOTES)

FENCE

STREET

APPROXIMATE LOCATION OF PRE-EXISTING

BUILDING FOOTPRINTS PER HISTORICAL

MAPPING. CONTRACTOR SHALL REMOVE


FOUNDATIONS, FOUNDATION WALLS,

BELOW GRADE WALLS, SLABS, ETC) ENCOUNTERED AS NECESSARY TO

(SEE NOTES)

ALL BELOW GRADE OBSTRUCTIONS (I.E.

CONSTRUCT THE PROJECT. TYP FOR ALL

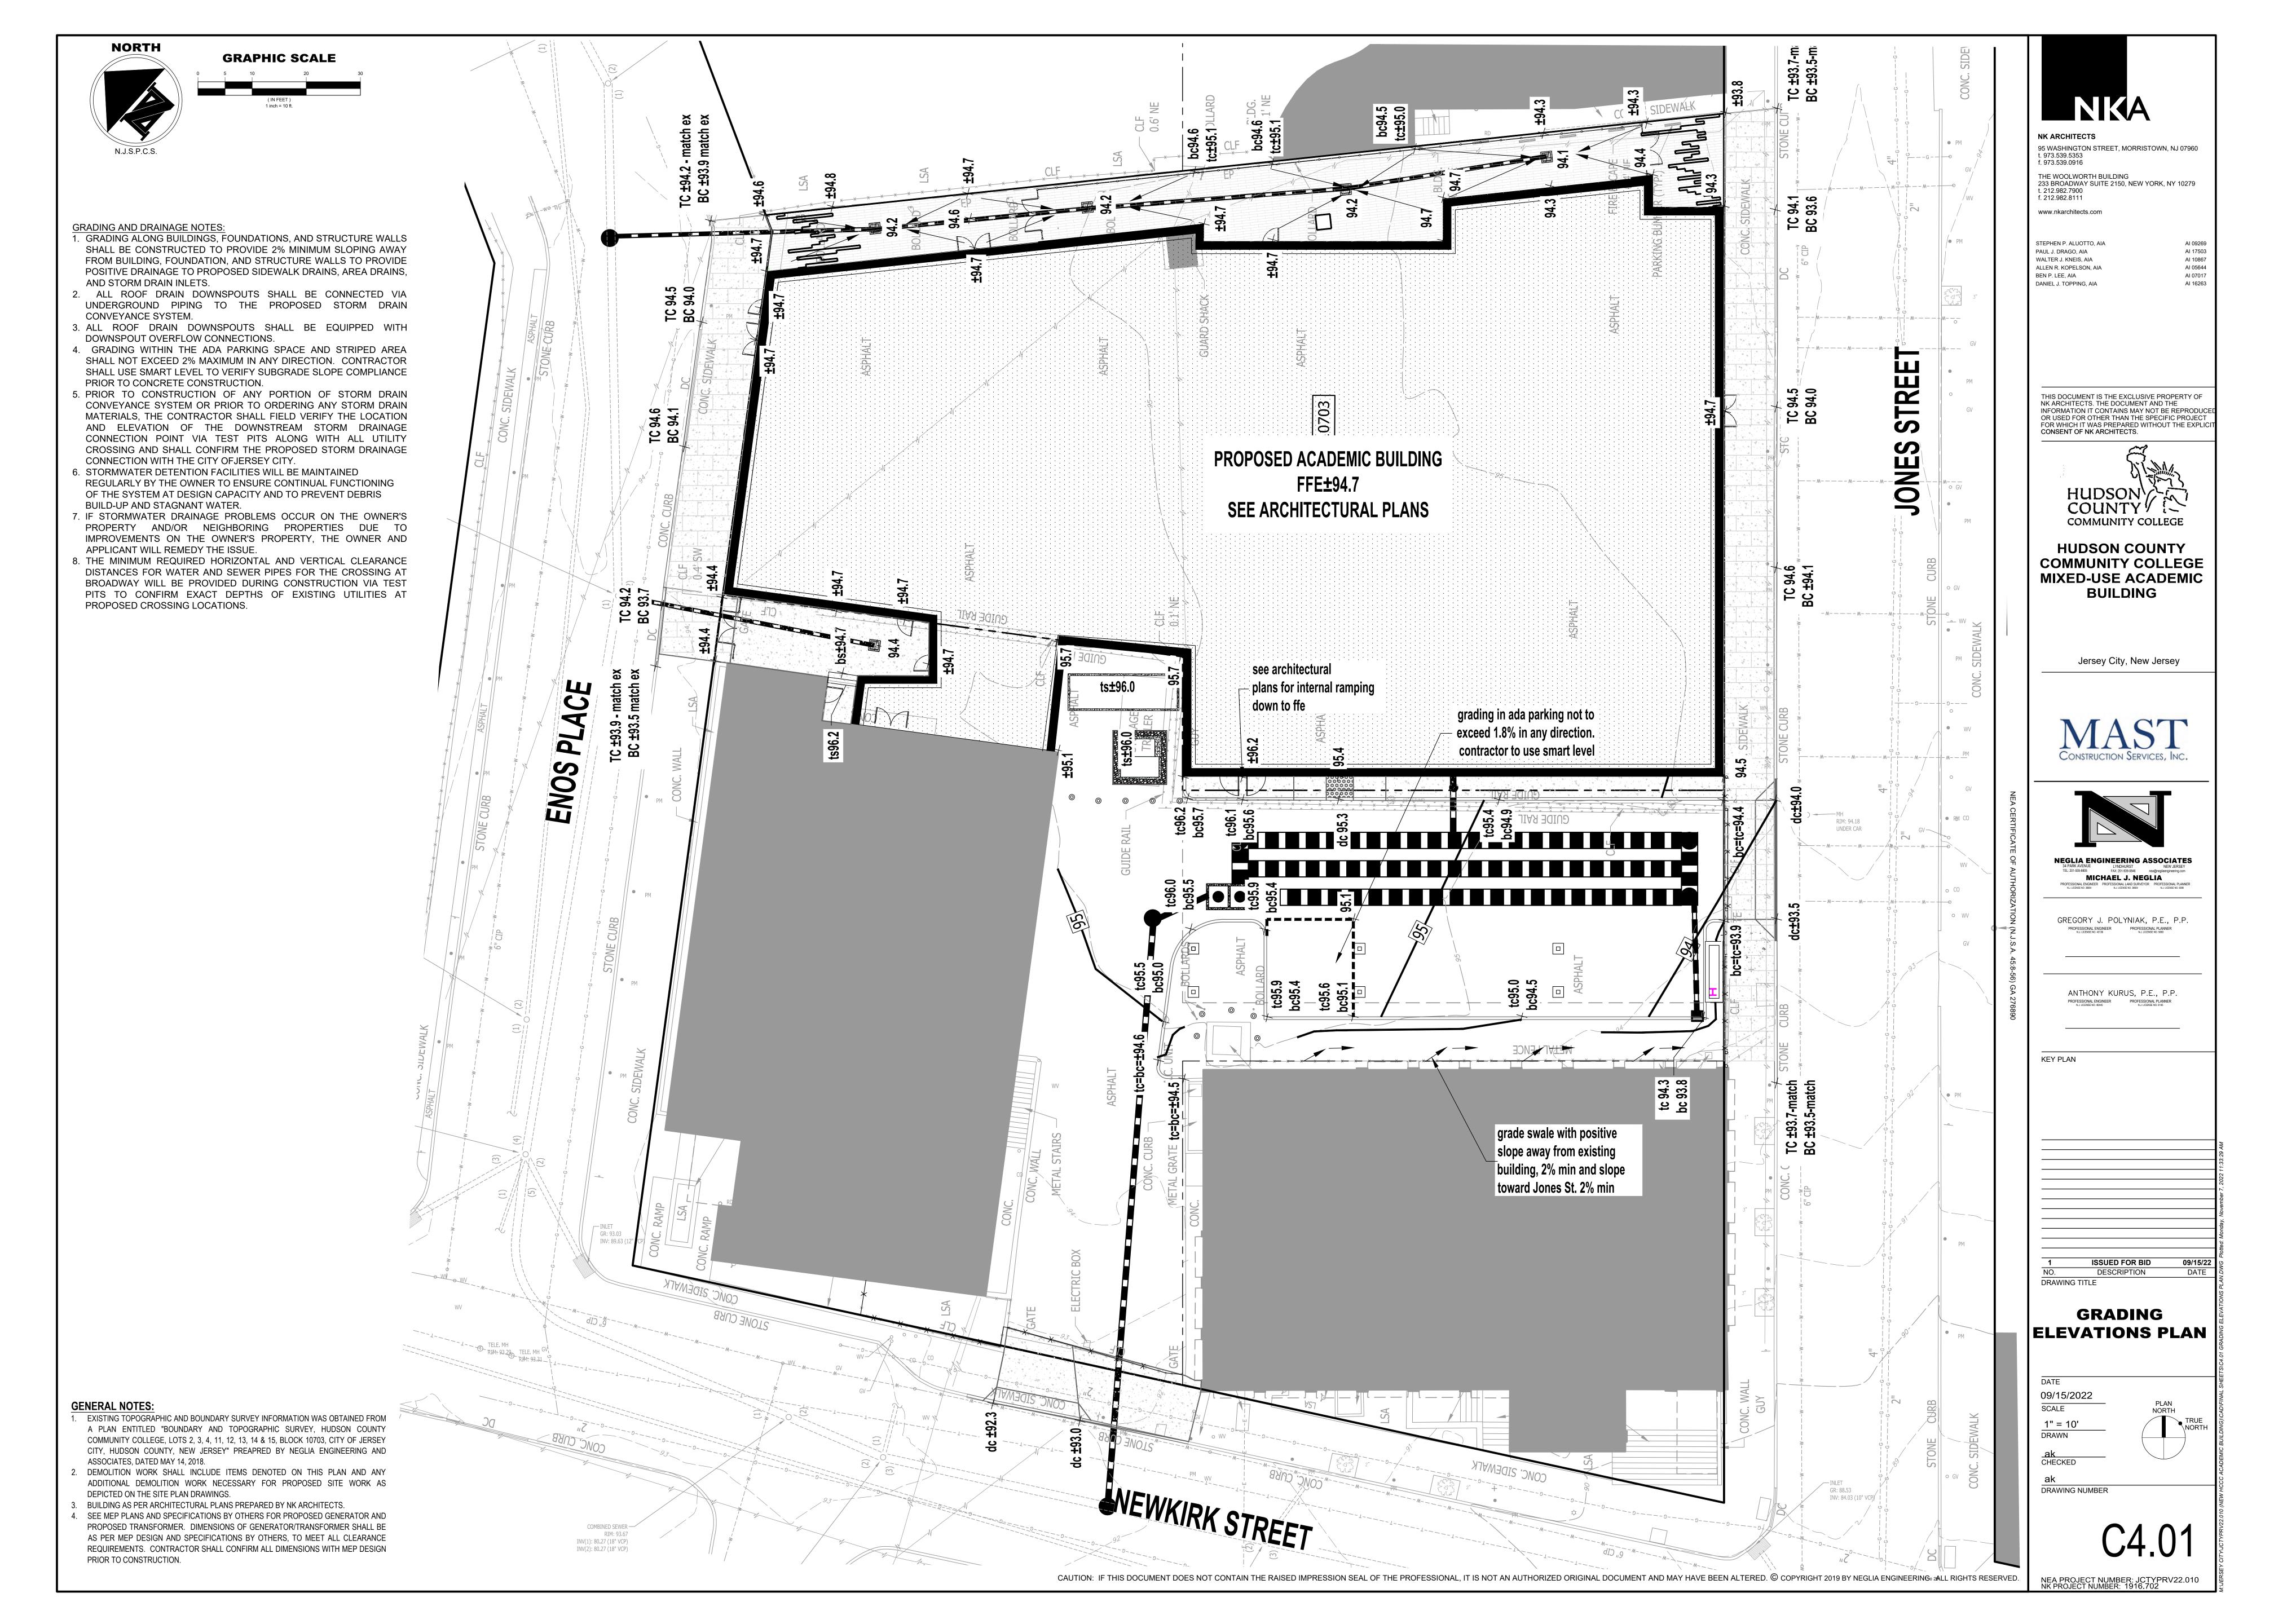



WHERE NEW DOORS & FRAMES ARE TO BE INSTALLED, PLACE DOOR AS INDICATED (U.O.N.) CONSTRUCTION. REFER

TO DRAWING A0.30 FOR PARTITION TYPE. **NEW MASONRY** CONSTRUCTION. REFER TO DRAWING A0.30 FOR PARTITION TYPE.

EXISTING WALL TO REMAIN FEC RECESSED FIRE **EXTINGUISHER** CABINET

- SCOPE OF CONSTRUCTION WORK IS NOT LIMITED TO WORK SHOWN ON CONSTRUCTION DRAWINGS.
- REFER TO DRAWING A0.20 FOR BARRIER FREE DETAILS. ALL PARTITIONS TO BE TYPE 'A0S' UNLESS OTHERWISE

CONTROL JOINT

- NOTED ON PLAN. REFER TO DRAWING SERIES A0.30 FOR PARTITION TYPES.
- REFER TO DRAWING SERIES A7.00 FOR DOOR TYPES,
- REFER TO DRAWING SERIES A7.10 FOR WINDOW TYPES AND
- REFER TO DRAWING SERIES A10.00 AND/OR SPECIFICATIONS FOR FINISH SCHEDULE.
- REFER TO DRAWING SERIES A11.00 FOR EQUIPMENT
- BOX OUT ALL EXPOSED PIPING, VALVES, AND FITTINGS FROM FLOOR LINE TO A MINIMUM OF 4" ABOVE CEILING LINE WITH 5/8" GYPSUM BOARD ON 1 5/8" METAL STUDS. PROVIDE METAL ACCESS DOOR FOR ALL VALVES, CLEANOUTS, ETC.
- . PROVIDE MASONRY CONTROL JOINTS AT 30'-0" O.C., MAXIMUM, AT ALL MASONRY WALLS. REFER TO PLANS AND ELEVATIONS FOR JOINT LOCATIONS. IF MASONRY WALL IS PART OF THE STRUCTURAL SHEAR DESIGN, THEN REFER TO STRUCTURAL DRAWINGS FOR LOCATIONS & ADDITIONAL DETAILING INFOMATION.
- PROVIDE CONTROL JOINTS AT 30'-0" O.C., MAXIMUM FOR ALL GYPSUM BOARD PARTITIONS. REFER TO PLANS AND ELEVATIONS FOR JOINT LOCATIONS. IF GYPSUM BOARD WALL IS PART OF THE STRUCTURAL SHEAR DESIGN. THEN REFER TO STRUCTURAL DRAWINGS FOR LOCATIONS & ADDITIONAL DETAILING INFOMATION.
- B. MAINTAIN INTEGRITY OF ALL EXISTING FIREPROOFING ON ALL STRUCTURAL BEAMS, COLUMNS AND PENETRATIONS. REPAIR AS REQUIRED ON ALL STRUCTURAL STEEL, INCLUDING BUT NOT LIMITED TO BEAMS, COLUMNS AND METAL DECKING; MAINTAIN ALL EXISTING FIRESTOPPING. REPAIR WHEN DAMAGED IN COURSE OF WORK.

KEY NOTES - 1

KEYNOTE #	DESCRIPTION
1	ADA OPERATOR IN PEDESTAL
2	(2) FACE LAYERS AT THE OUTER SIDE OF THE ELEVATOR SHAFT AND STAIRCASE TO BE IMPACT-RESISTANT GYPSUM WALL BOARD W/MIN. HARD BODY CLASSIFICATION LEVEL 2
3	FACE LAYER AT THE INTERIOR SIDE OF THE ROOM TO BE IMPACT-RESISTANT GYPSUM WALL BOARD W/ MIN. HARD BODY CLASSIFICATION LEVEL 2.
4	MOTORIZED TELESCOPING SEATING PLATFORM SYSTEM AS SPECIFIED
5	PARTITIONS UP TO STRUCTURE OF CATWALK/ FLOOR ABOVE
6	SUSPENDED 1-1/2" SCHED. 40 STL. PIPE GRID (TYP.). REFER TO ENLARGED THEATER SECTION AND DETAILS
7	WALK ALONG DRAPERY TRACK AND CURTAINS. REFER TO ENLARGED THEATER SECTION AND DETAILS
8	GRILLED SECURITY SHUTTER DOOR CEILING MOUNTED AS SPECIFIED
9	3RD LEVEL MEZZANINE MECHANICAL FLOOR AT 44' - 3" AFF. REFER TO ENLARGED FLOOR PLANS
10	MOTORIZED TELESCOPIC SEATING RISER SYSTEM AS SPECIFIED
11	INDOOR LED SCOREBOARD AS SPECIFIED
12	SCORES TABLE
13	RECESSED VOLEYBALL COURT SLEEVES
14	MOTORIZED SIDE-FOLD BASKETBALL BACKSTOP
15	PROTECTIVE WALL PADS AS SPECIFIED
16	3 1/2" MINERAL WOOL INSULATION LAYER PINNED BEHIND SHADOW BOX METAL BACK PAN FROM FLOOR TO UNDERSIDE OF DECK.
17	INTERIOR PARTITION TO BE CENTERED IN COL. GRID AS NOTED.
18	FILL IN FLOOR AROUND DUCT & PIPE PENETRATIONS W/ RATED HORIZ. ASSEMBLY (SEE DETAIL 8/A0.31)
19	INSTALL DUCT LINER ALL AROUND RETURN AIR PLENUM. REFER TO MEP DWGS FOR ADDITIONAL INFORMATION
20	APPROX.CENTER OF MULTIPLE SPORT COURT LAYOUTS.
21	ACCESS LADDER AS SPECIFIED. REFER TO ENLARGED FLOOR PLANS, SECTION AND DETAILS
22	ACCESS LADDER WITH LOCKABLE DOOR AS SPECIFIED. REFER TO ENLARGED FLOOR PLANS SECTION AND DETAILS



NK ARCHITECTS 95 WASHINGTON STREET, MORRISTOWN, NJ 07960 t. 973.539.5353

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HUDSON COUNTY COMMUNITY COLLEGE

MIXED-USE ACADEMIC BUILDING Jersey City, NJ

KEY PLAN


1ST LEVEL FLOOR PLAN

09/15/2022 SCALE 1/8" = 1'-0"


DRAWN CHECKED

DRAWING NUMBER

A1.01

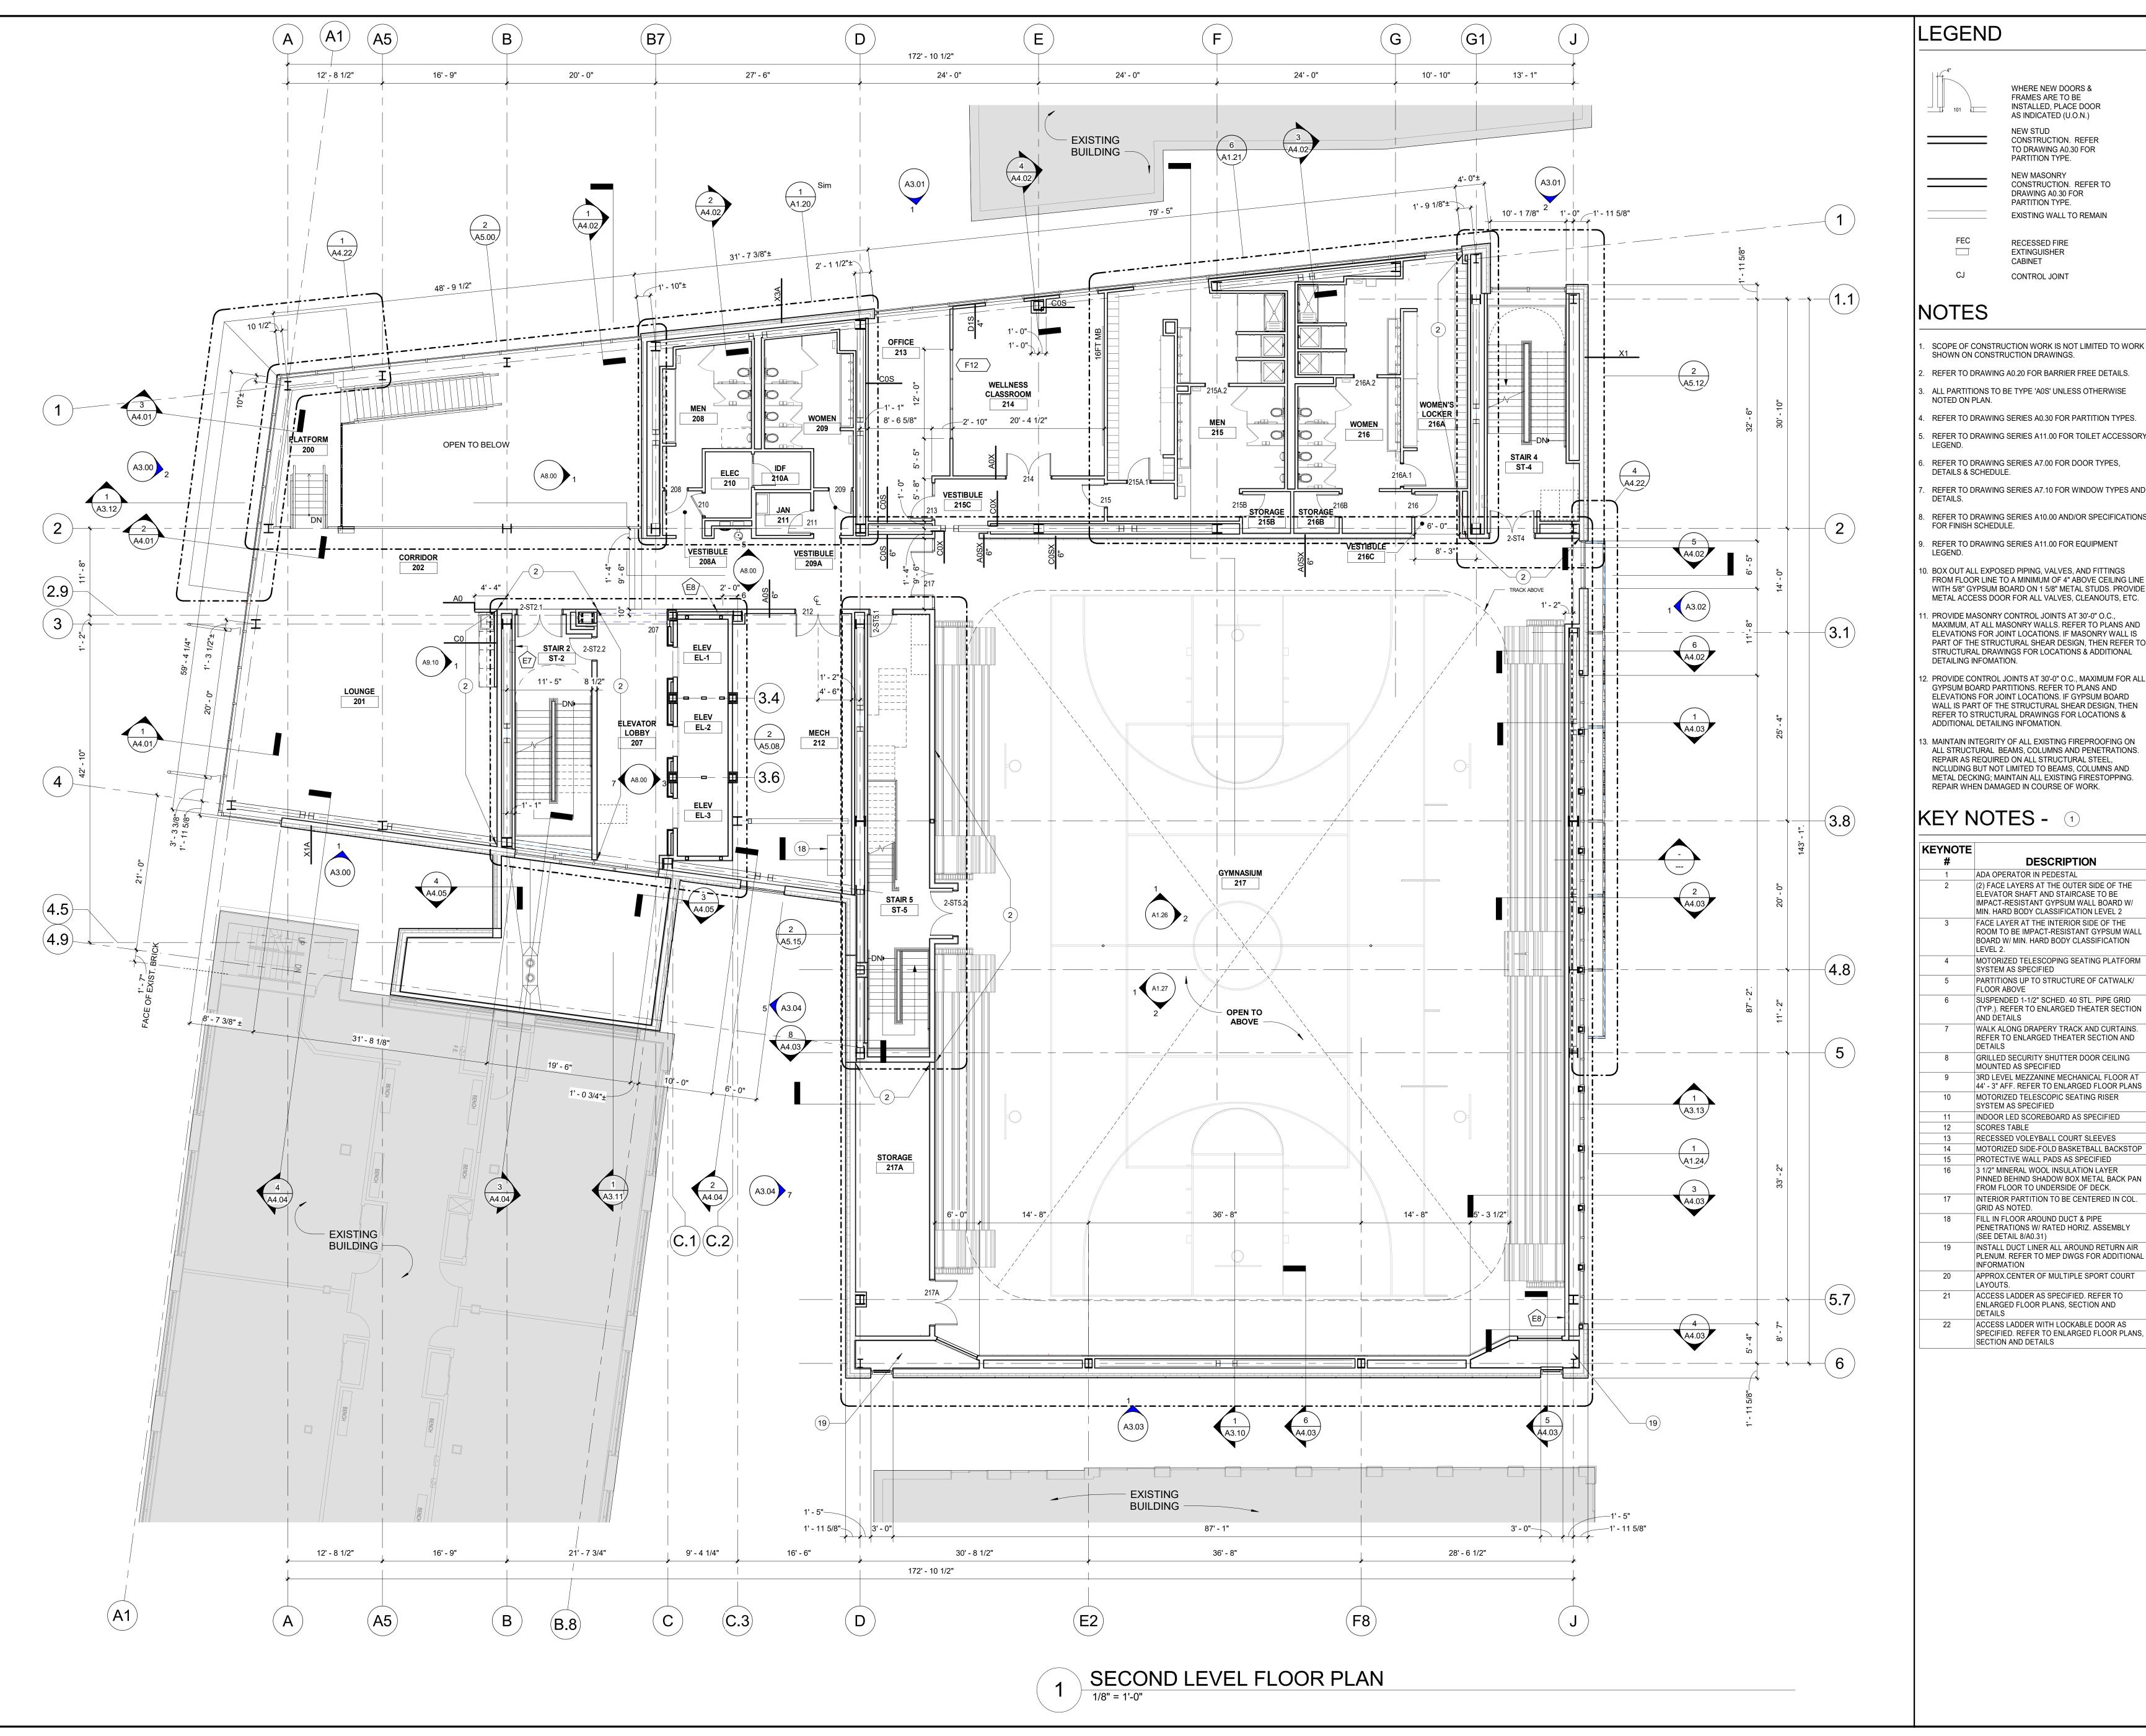

WHERE NEW DOORS & FRAMES ARE TO BE INSTALLED, PLACE DOOR

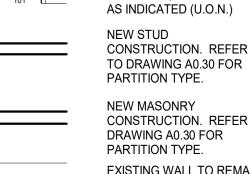

NEW MASONRY CONSTRUCTION. REFER TO DRAWING A0.30 FOR PARTITION TYPE. EXISTING WALL TO REMAIN



NOTES

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- REFER TO DRAWING A0.20 FOR BARRIER FREE DETAILS. ALL PARTITIONS TO BE TYPE 'A0S' UNLESS OTHERWISE
- NOTED ON PLAN. REFER TO DRAWING SERIES A0.30 FOR PARTITION TYPES.
- REFER TO DRAWING SERIES A11.00 FOR TOILET ACCESSORY REFER TO DRAWING SERIES A7.00 FOR DOOR TYPES,
- DETAILS & SCHEDULE. REFER TO DRAWING SERIES A7.10 FOR WINDOW TYPES AND
- REFER TO DRAWING SERIES A10.00 AND/OR SPECIFICATIONS
- FOR FINISH SCHEDULE. REFER TO DRAWING SERIES A11.00 FOR EQUIPMENT
- D. BOX OUT ALL EXPOSED PIPING, VALVES, AND FITTINGS
- METAL ACCESS DOOR FOR ALL VALVES, CLEANOUTS, ETC. . PROVIDE MASONRY CONTROL JOINTS AT 30'-0" O.C., MAXIMUM, AT ALL MASONRY WALLS. REFER TO PLANS AND ELEVATIONS FOR JOINT LOCATIONS. IF MASONRY WALL IS PART OF THE STRUCTURAL SHEAR DESIGN, THEN REFER TO
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17	INTERIOR PARTITION TO BE CENTERED IN COL. GRID AS NOTED.
18	FILL IN FLOOR AROUND DUCT & PIPE PENETRATIONS W/ RATED HORIZ. ASSEMBLY (SEE DETAIL 8/A0.31)
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HUDSON COUNTY COMMUNITY COLLEGE

> **MIXED-USE ACADEMIC BUILDING** Jersey City, NJ

KEY PLAN


2ND LEVEL FLOOR PLAN

09/15/2022


SCALE 1/8" = 1'-0" DRAWN Author CHECKED

Checker DRAWING NUMBER

A1.02

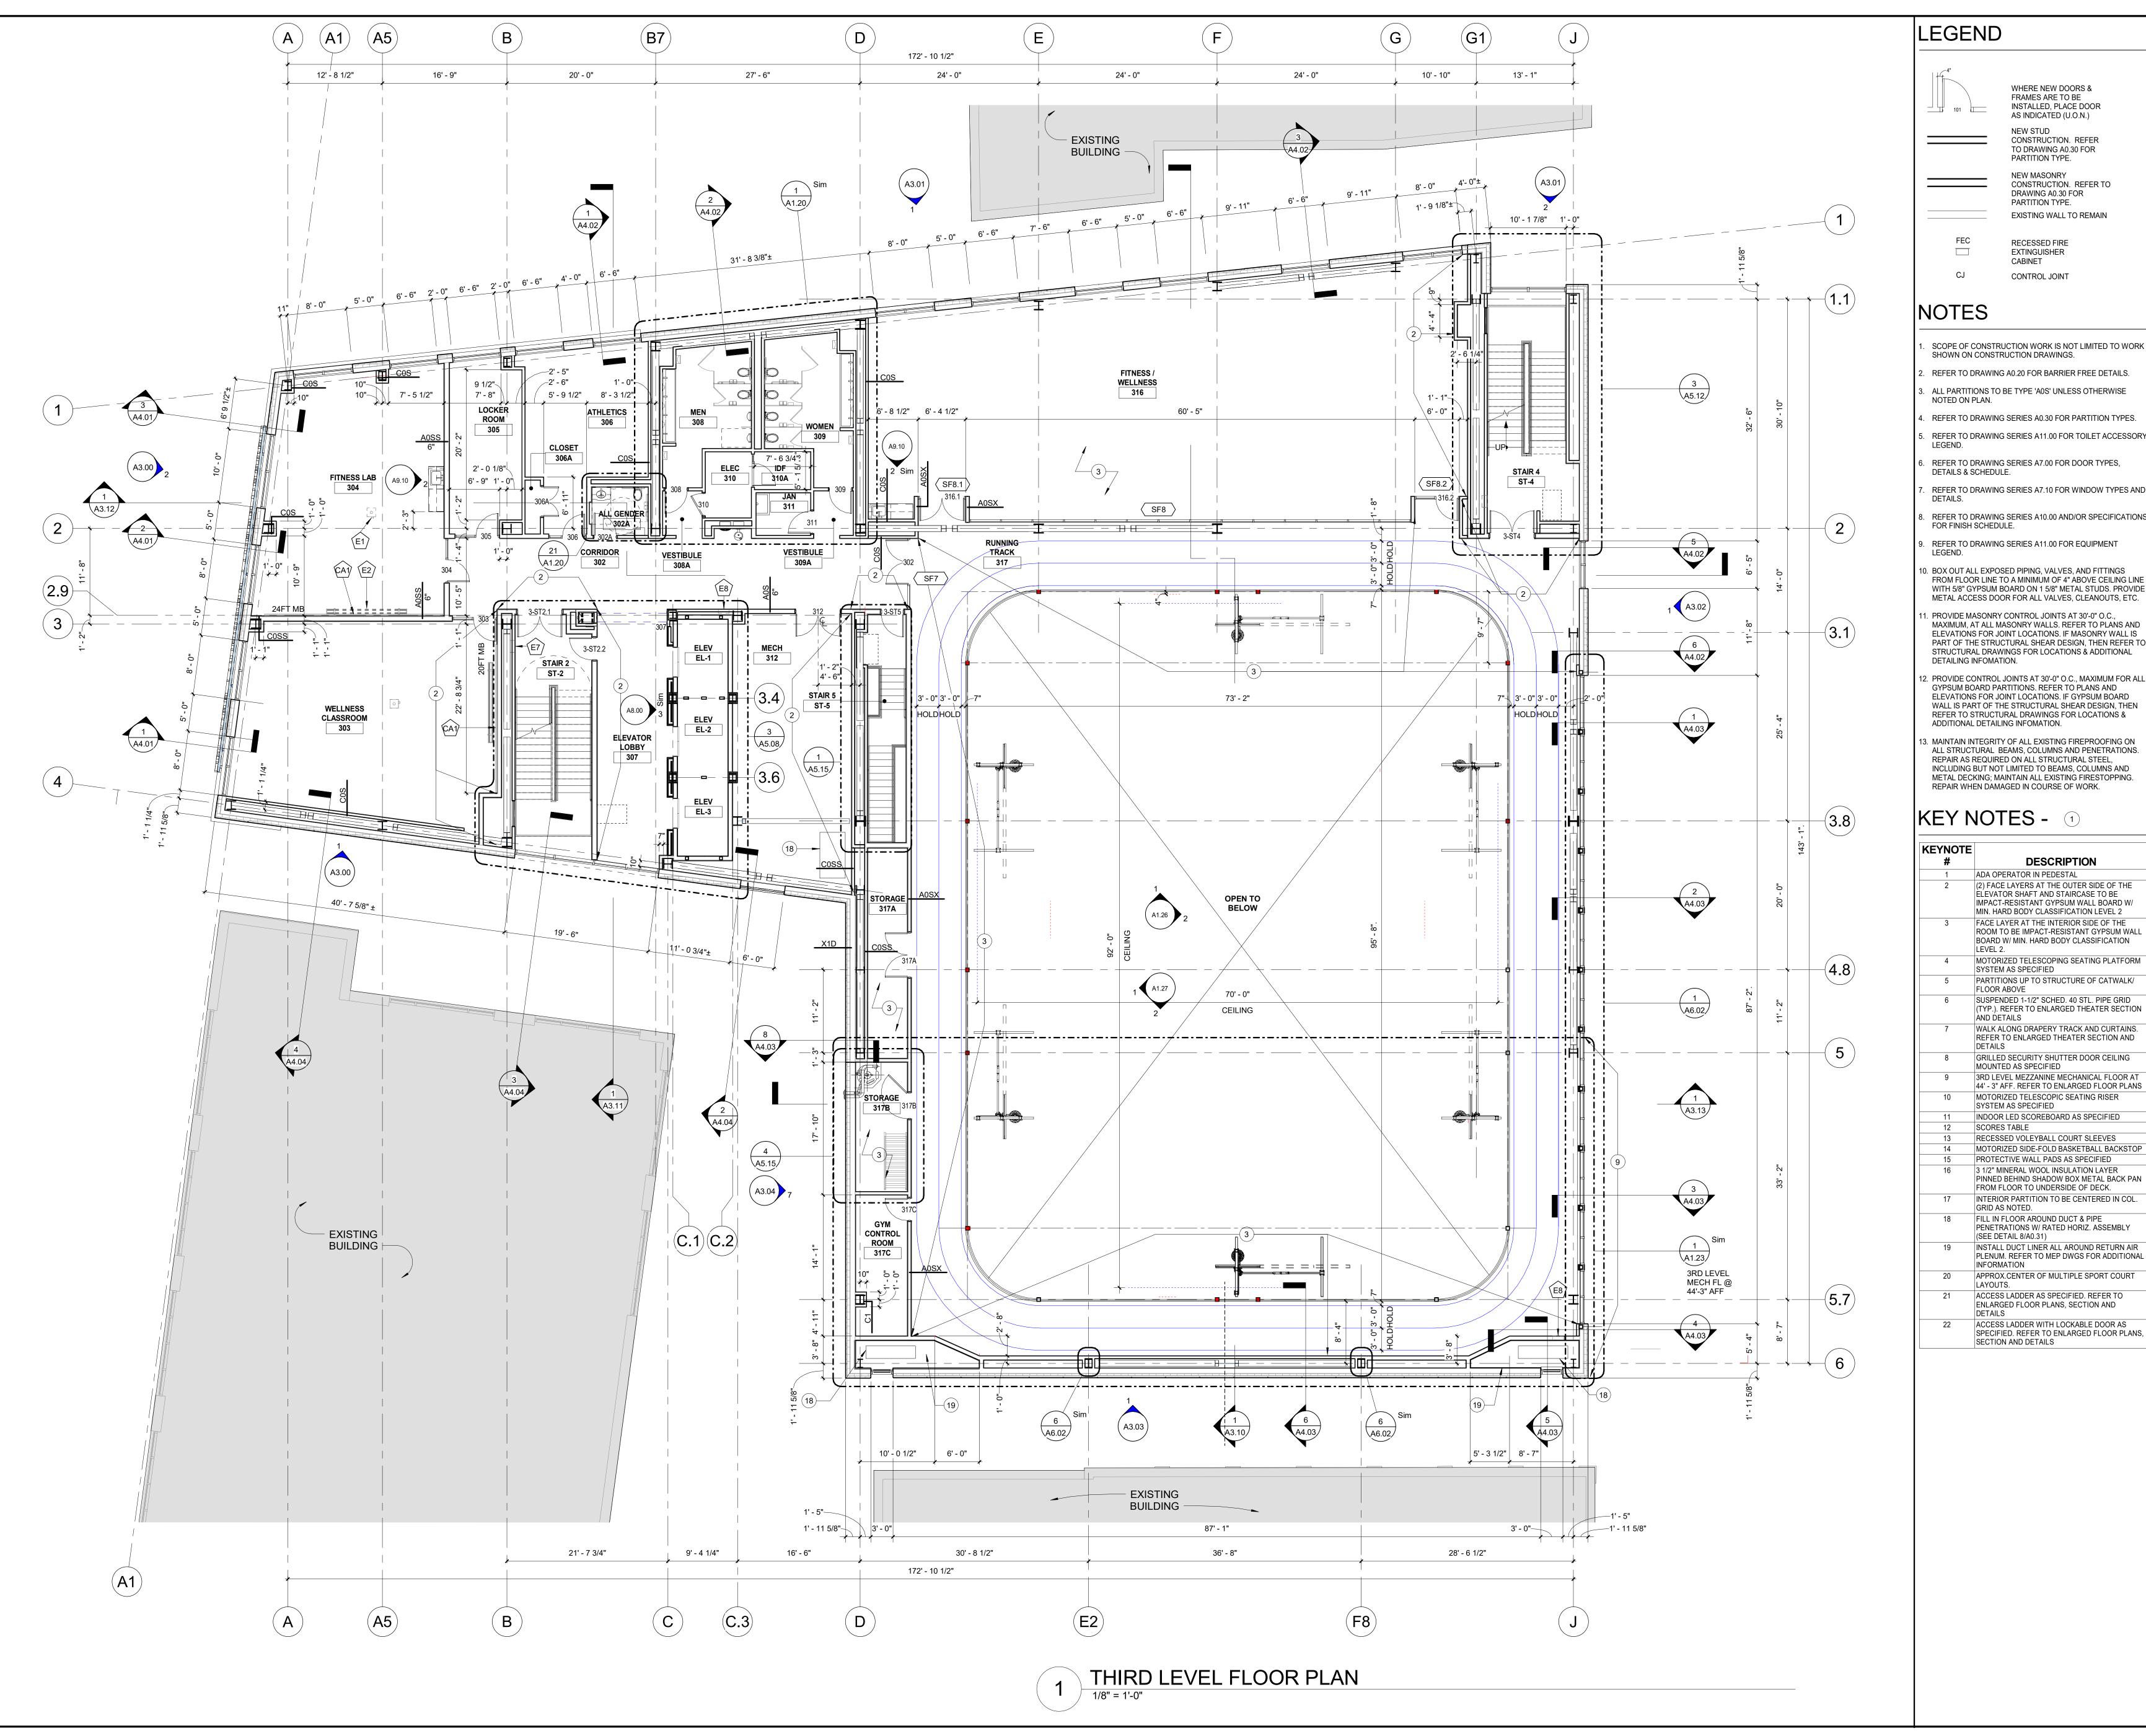


WHERE NEW DOORS & FRAMES ARE TO BE INSTALLED, PLACE DOOR

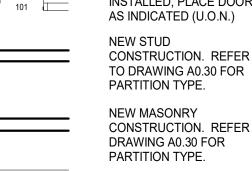

NEW MASONRY CONSTRUCTION. REFER TO DRAWING A0.30 FOR PARTITION TYPE. EXISTING WALL TO REMAIN

RECESSED FIRE

EXTINGUISHER

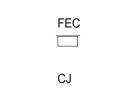

CABINET CONTROL JOINT

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- NOTED ON PLAN. REFER TO DRAWING SERIES A0.30 FOR PARTITION TYPES.
- REFER TO DRAWING SERIES A7.00 FOR DOOR TYPES, DETAILS & SCHEDULE.
- REFER TO DRAWING SERIES A7.10 FOR WINDOW TYPES AND DETAILS.
- REFER TO DRAWING SERIES A10.00 AND/OR SPECIFICATIONS FOR FINISH SCHEDULE.
- REFER TO DRAWING SERIES A11.00 FOR EQUIPMENT
- D. BOX OUT ALL EXPOSED PIPING, VALVES, AND FITTINGS FROM FLOOR LINE TO A MINIMUM OF 4" ABOVE CEILING LINE WITH 5/8" GYPSUM BOARD ON 1 5/8" METAL STUDS. PROVIDE METAL ACCESS DOOR FOR ALL VALVES, CLEANOUTS, ETC.
- . PROVIDE MASONRY CONTROL JOINTS AT 30'-0" O.C., MAXIMUM, AT ALL MASONRY WALLS. REFER TO PLANS AND ELEVATIONS FOR JOINT LOCATIONS. IF MASONRY WALL IS PART OF THE STRUCTURAL SHEAR DESIGN, THEN REFER TO STRUCTURAL DRAWINGS FOR LOCATIONS & ADDITIONAL DETAILING INFOMATION.
- PROVIDE CONTROL JOINTS AT 30'-0" O.C., MAXIMUM FOR ALL GYPSUM BOARD PARTITIONS. REFER TO PLANS AND ELEVATIONS FOR JOINT LOCATIONS. IF GYPSUM BOARD WALL IS PART OF THE STRUCTURAL SHEAR DESIGN, THEN REFER TO STRUCTURAL DRAWINGS FOR LOCATIONS & ADDITIONAL DETAILING INFOMATION.
- B. MAINTAIN INTEGRITY OF ALL EXISTING FIREPROOFING ON ALL STRUCTURAL BEAMS, COLUMNS AND PENETRATIONS. REPAIR AS REQUIRED ON ALL STRUCTURAL STEEL, INCLUDING BUT NOT LIMITED TO BEAMS, COLUMNS AND METAL DECKING; MAINTAIN ALL EXISTING FIRESTOPPING. REPAIR WHEN DAMAGED IN COURSE OF WORK.

KEY NOTES - 1

KEYNOTE #	DESCRIPTION
1	ADA OPERATOR IN PEDESTAL
2	(2) FACE LAYERS AT THE OUTER SIDE OF THE ELEVATOR SHAFT AND STAIRCASE TO BE IMPACT-RESISTANT GYPSUM WALL BOARD W/MIN. HARD BODY CLASSIFICATION LEVEL 2
3	FACE LAYER AT THE INTERIOR SIDE OF THE ROOM TO BE IMPACT-RESISTANT GYPSUM WALL BOARD W/ MIN. HARD BODY CLASSIFICATION LEVEL 2.
4	MOTORIZED TELESCOPING SEATING PLATFORM SYSTEM AS SPECIFIED
5	PARTITIONS UP TO STRUCTURE OF CATWALK/ FLOOR ABOVE
6	SUSPENDED 1-1/2" SCHED. 40 STL. PIPE GRID (TYP.). REFER TO ENLARGED THEATER SECTION AND DETAILS
7	WALK ALONG DRAPERY TRACK AND CURTAINS. REFER TO ENLARGED THEATER SECTION AND DETAILS
8	GRILLED SECURITY SHUTTER DOOR CEILING MOUNTED AS SPECIFIED
9	3RD LEVEL MEZZANINE MECHANICAL FLOOR AT 44' - 3" AFF. REFER TO ENLARGED FLOOR PLANS
10	MOTORIZED TELESCOPIC SEATING RISER SYSTEM AS SPECIFIED
11	INDOOR LED SCOREBOARD AS SPECIFIED
12	SCORES TABLE
13	RECESSED VOLEYBALL COURT SLEEVES
14	MOTORIZED SIDE-FOLD BASKETBALL BACKSTOP
15	PROTECTIVE WALL PADS AS SPECIFIED
16	3 1/2" MINERAL WOOL INSULATION LAYER PINNED BEHIND SHADOW BOX METAL BACK PAN FROM FLOOR TO UNDERSIDE OF DECK.
17	INTERIOR PARTITION TO BE CENTERED IN COL. GRID AS NOTED.
18	FILL IN FLOOR AROUND DUCT & PIPE PENETRATIONS W/ RATED HORIZ. ASSEMBLY (SEE DETAIL 8/A0.31)
19	INSTALL DUCT LINER ALL AROUND RETURN AIR PLENUM. REFER TO MEP DWGS FOR ADDITIONAL INFORMATION
20	APPROX.CENTER OF MULTIPLE SPORT COURT LAYOUTS.
21	ACCESS LADDER AS SPECIFIED. REFER TO ENLARGED FLOOR PLANS, SECTION AND DETAILS
22	ACCESS LADDER WITH LOCKABLE DOOR AS SPECIFIED. REFER TO ENLARGED FLOOR PLANS SECTION AND DETAILS



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HUDSON COUNTY COMMUNITY COLLEGE

> **MIXED-USE ACADEMIC BUILDING** Jersey City, NJ

KEY PLAN


3RD LEVEL FLOOR PLAN

09/15/2022 SCALE

1/8" = 1'-0" DRAWN Author CHECKED

Checker DRAWING NUMBER

A1.03

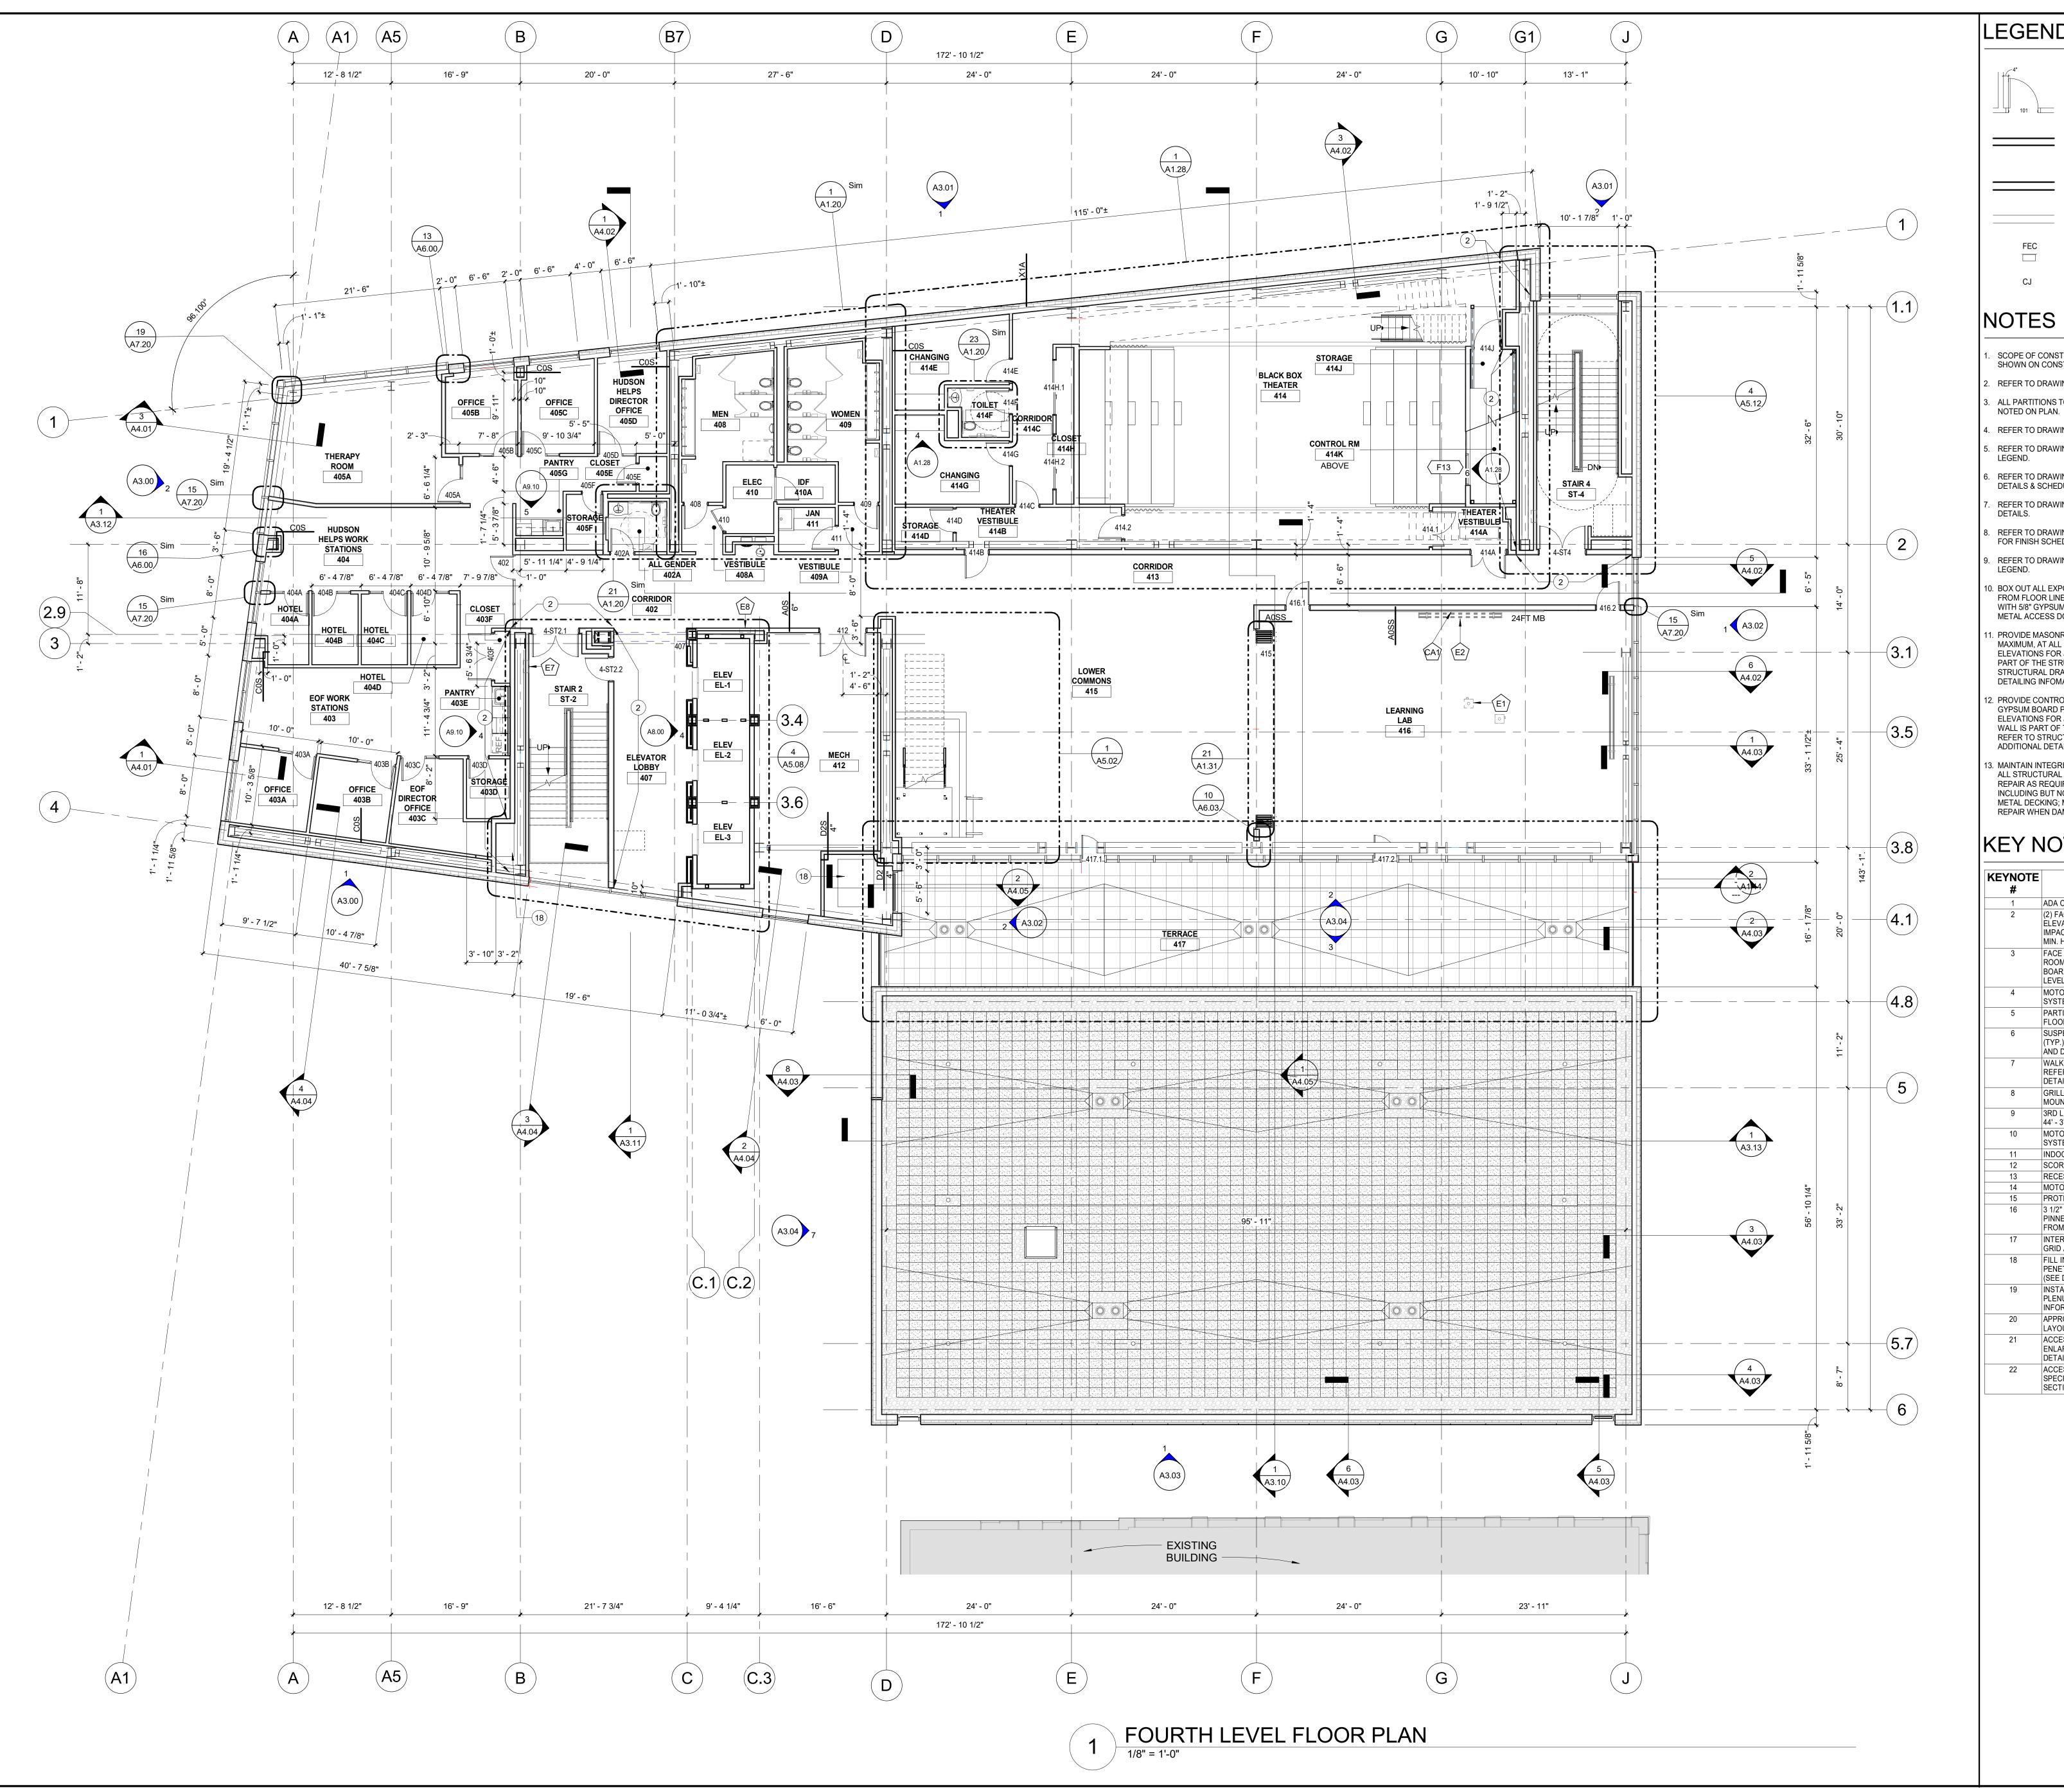

WHERE NEW DOORS &

NK ARCHITECTS

FRAMES ARE TO BE INSTALLED, PLACE DOOR AS INDICATED (U.O.N.) CONSTRUCTION. REFER TO DRAWING A0.30 FOR

PARTITION TYPE. **NEW MASONRY** CONSTRUCTION. REFER TO DRAWING A0.30 FOR PARTITION TYPE. EXISTING WALL TO REMAIN

FEC RECESSED FIRE **EXTINGUISHER** CABINET CONTROL JOINT

- SCOPE OF CONSTRUCTION WORK IS NOT LIMITED TO WORK SHOWN ON CONSTRUCTION DRAWINGS.
- REFER TO DRAWING A0.20 FOR BARRIER FREE DETAILS. ALL PARTITIONS TO BE TYPE 'A0S' UNLESS OTHERWISE
- REFER TO DRAWING SERIES A0.30 FOR PARTITION TYPES. REFER TO DRAWING SERIES A11.00 FOR TOILET ACCESSORY
- REFER TO DRAWING SERIES A7.00 FOR DOOR TYPES, DETAILS & SCHEDULE.
- REFER TO DRAWING SERIES A7.10 FOR WINDOW TYPES AND DETAILS.
- REFER TO DRAWING SERIES A10.00 AND/OR SPECIFICATIONS FOR FINISH SCHEDULE.
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8	GRILLED SECURITY SHUTTER DOOR CEILING MOUNTED AS SPECIFIED
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11	INDOOR LED SCOREBOARD AS SPECIFIED
12	SCORES TABLE
13	RECESSED VOLEYBALL COURT SLEEVES
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HUDSON COUNTY COMMUNITY COLLEGE

> **MIXED-USE ACADEMIC BUILDING** Jersey City, NJ


KEY PLAN

4TH LEVEL FLOOR PLAN

09/15/2022 SCALE 1/8" = 1'-0" DRAWN Author

CHECKED Checker DRAWING NUMBER

A1.04

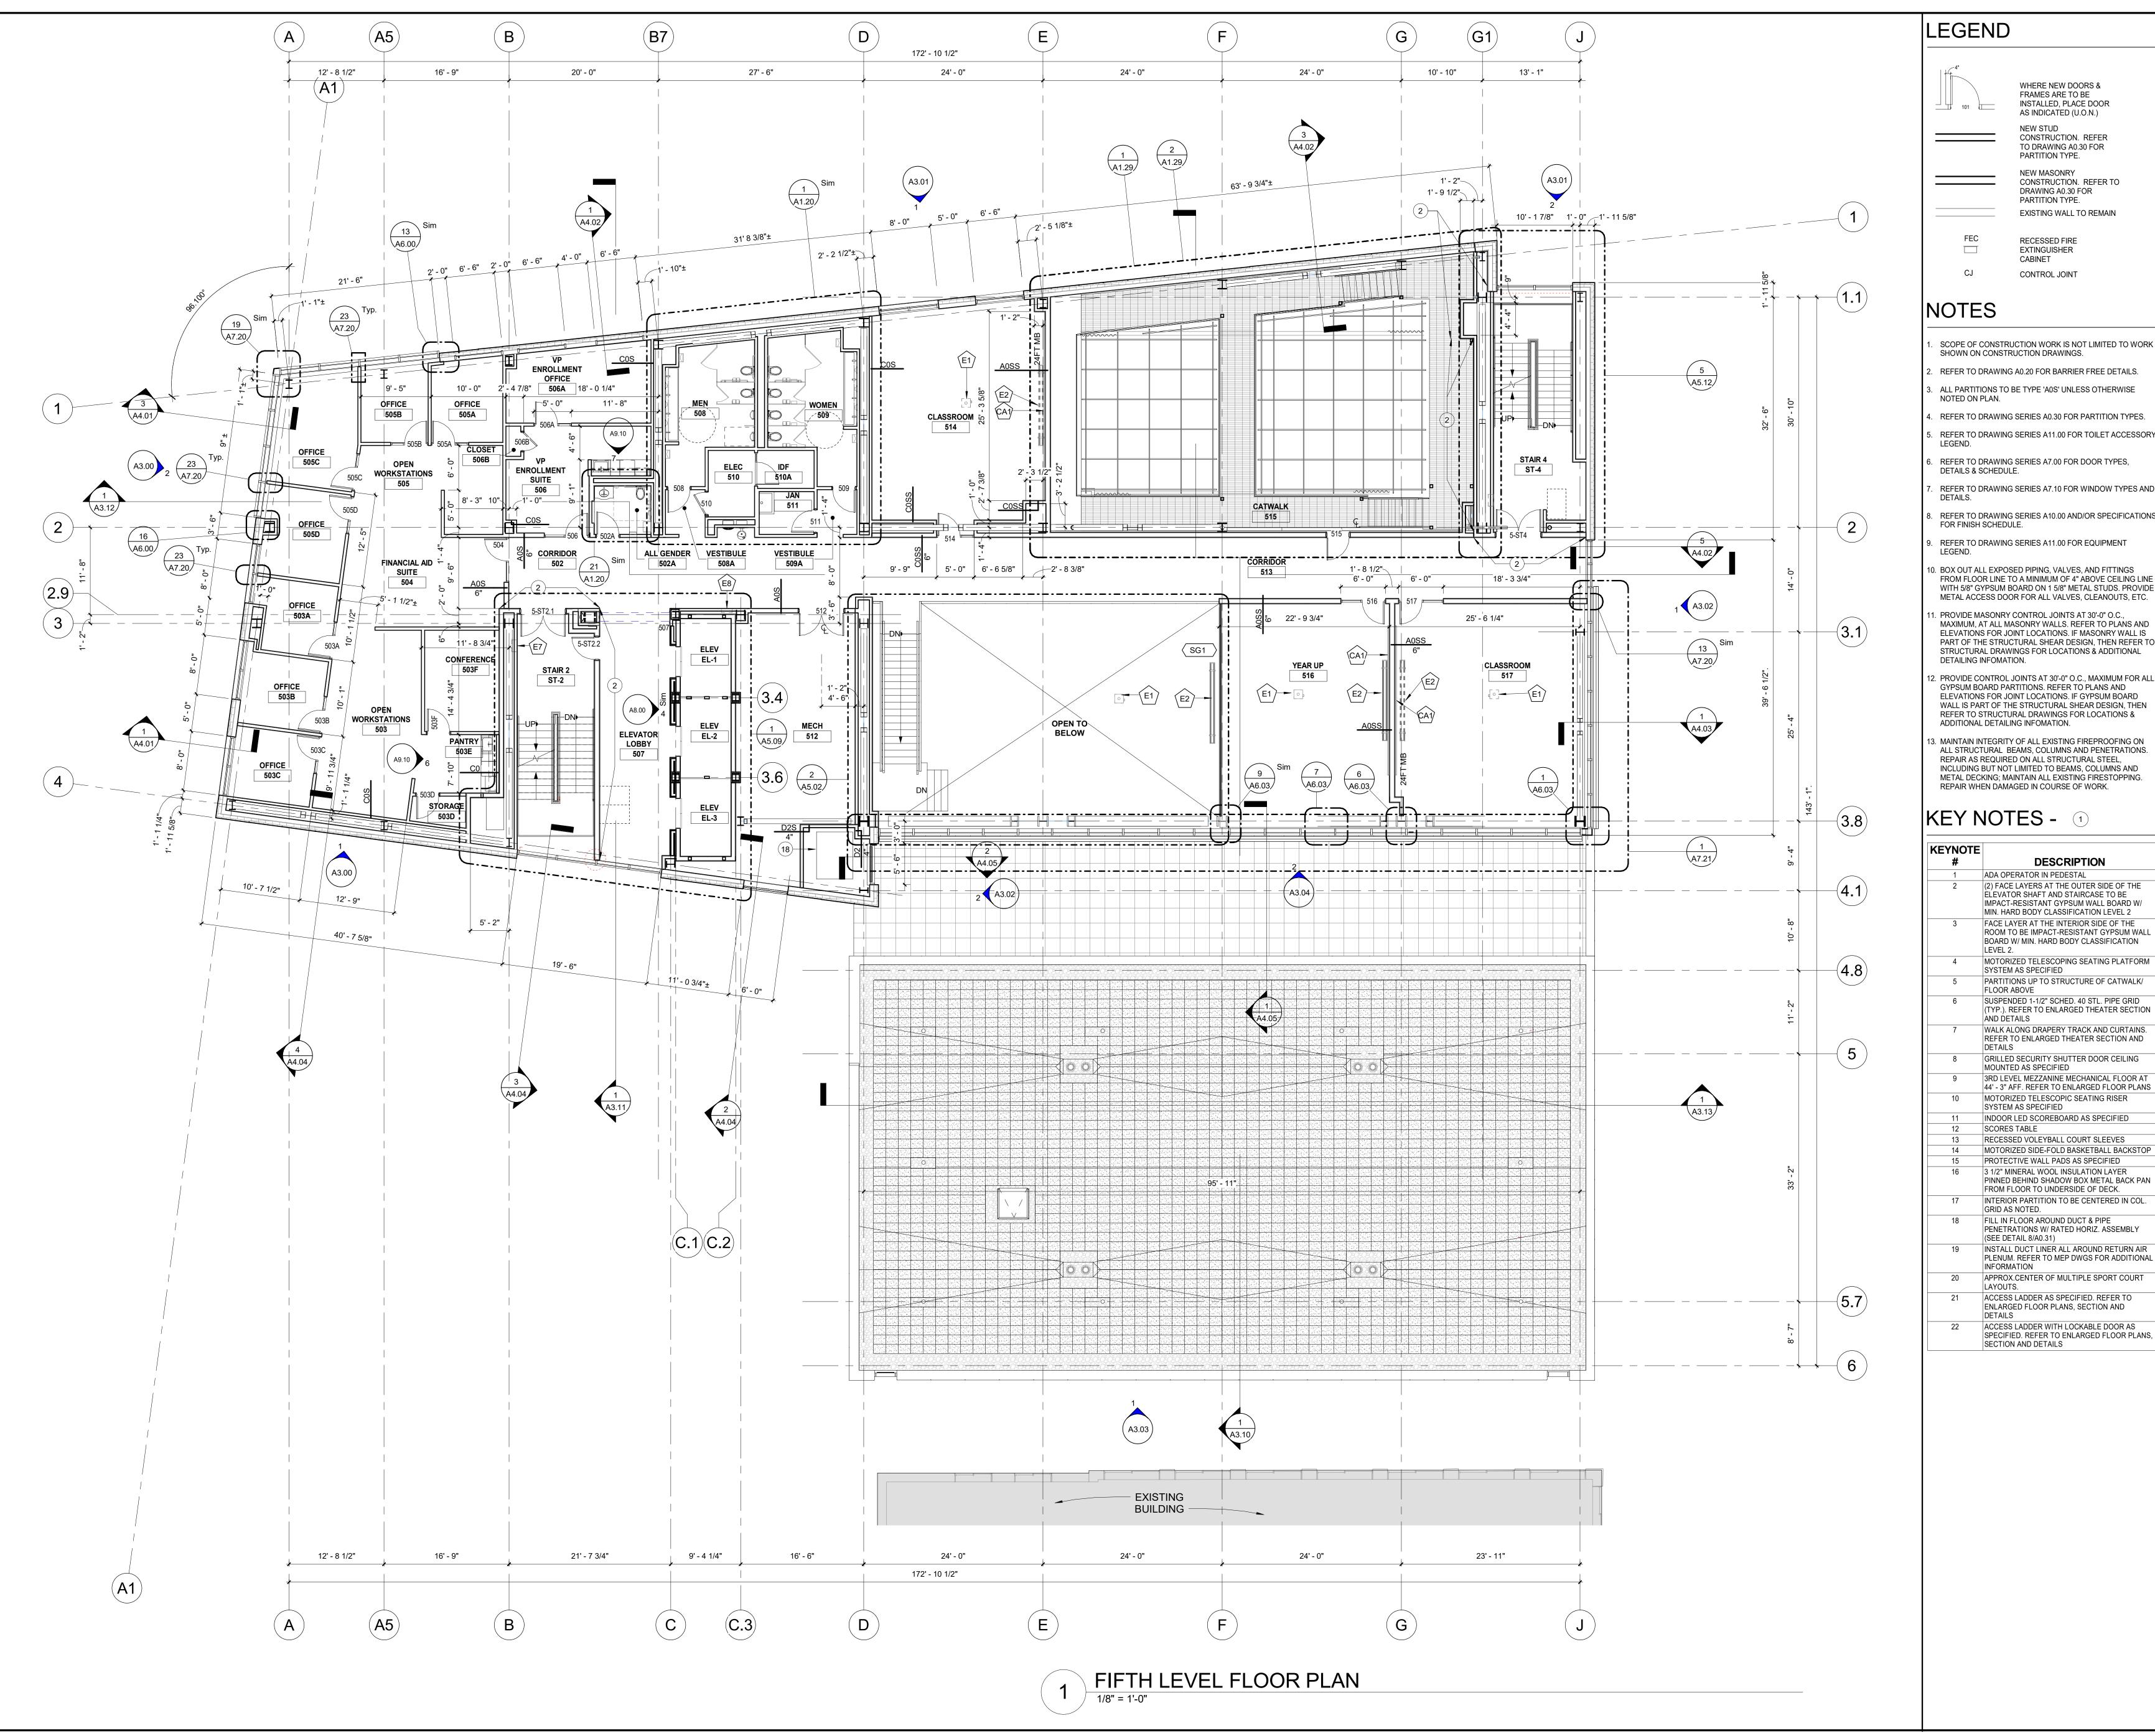

FRAMES ARE TO BE INSTALLED, PLACE DOOR AS INDICATED (U.O.N.) CONSTRUCTION. REFER TO DRAWING A0.30 FOR PARTITION TYPE.

WHERE NEW DOORS &

NEW MASONRY CONSTRUCTION. REFER TO DRAWING A0.30 FOR PARTITION TYPE. EXISTING WALL TO REMAIN

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- REFER TO DRAWING SERIES A7.10 FOR WINDOW TYPES AND
- REFER TO DRAWING SERIES A10.00 AND/OR SPECIFICATIONS FOR FINISH SCHEDULE.
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HUDSON COUNTY COMMUNITY COLLEGE

> **MIXED-USE ACADEMIC BUILDING** Jersey City, NJ

KEY PLAN


5TH LEVEL FLOOR PLAN

09/15/2022 SCALE 1/8" = 1'-0" DRAWN Author CHECKED


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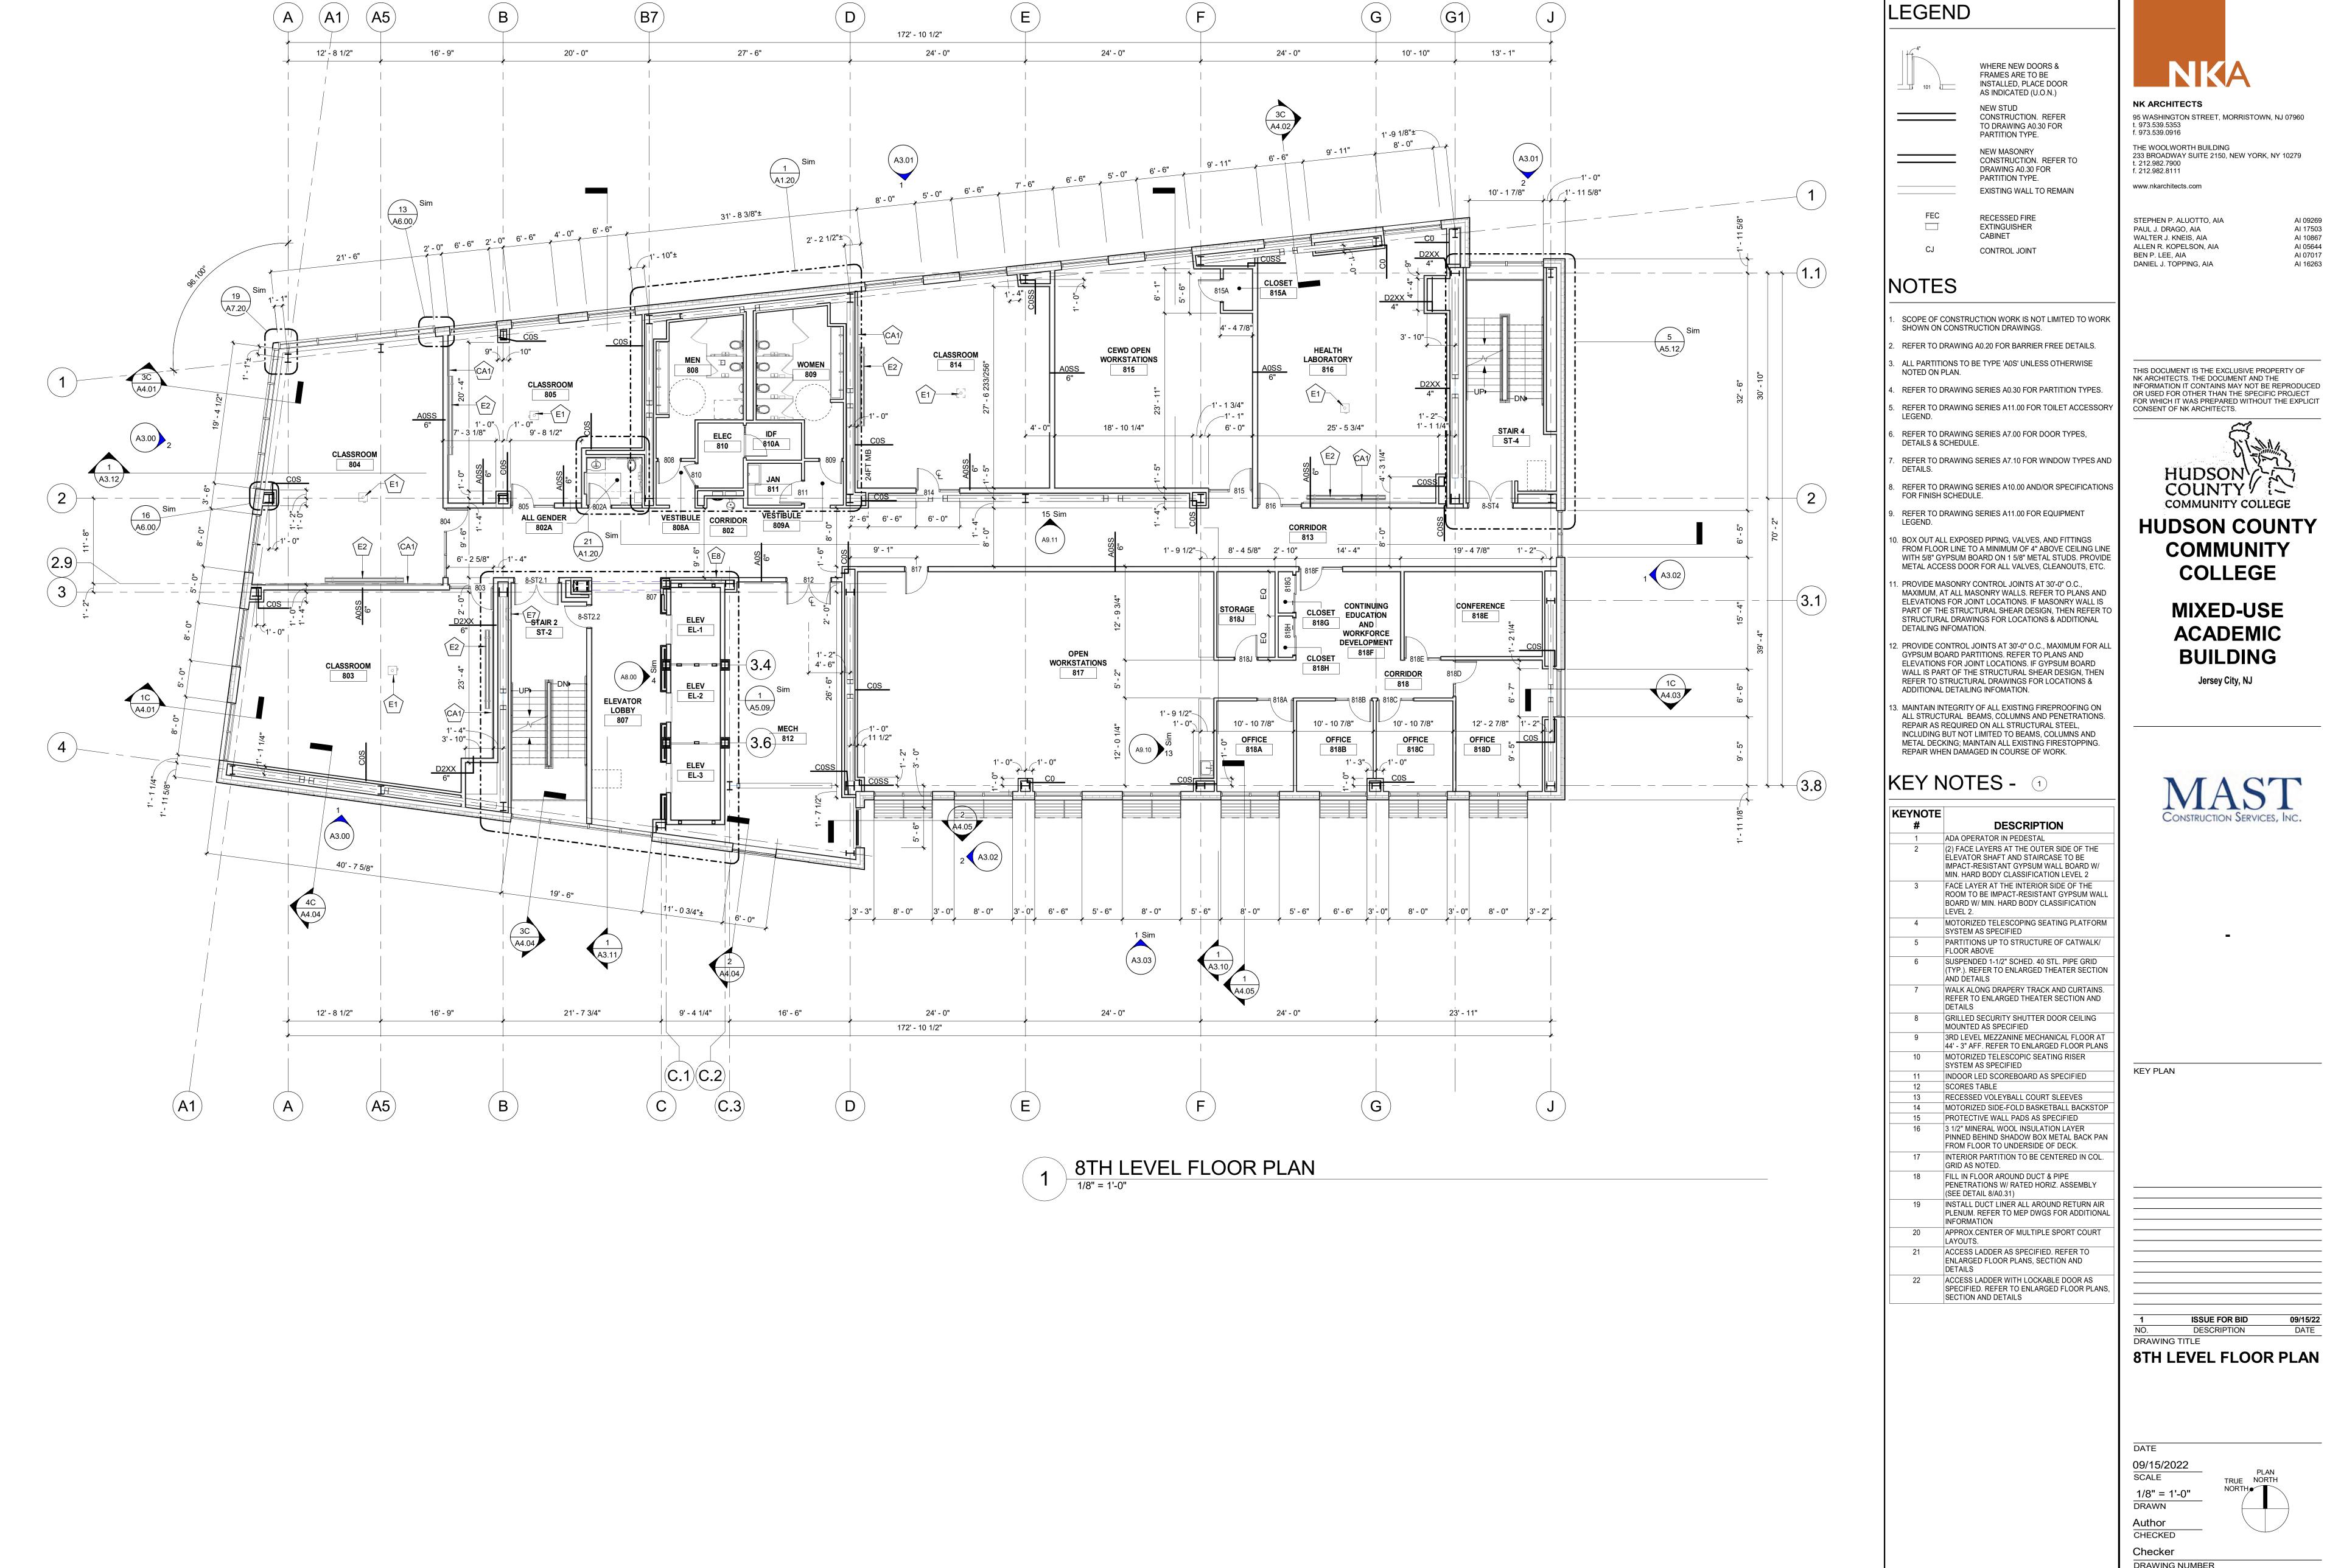
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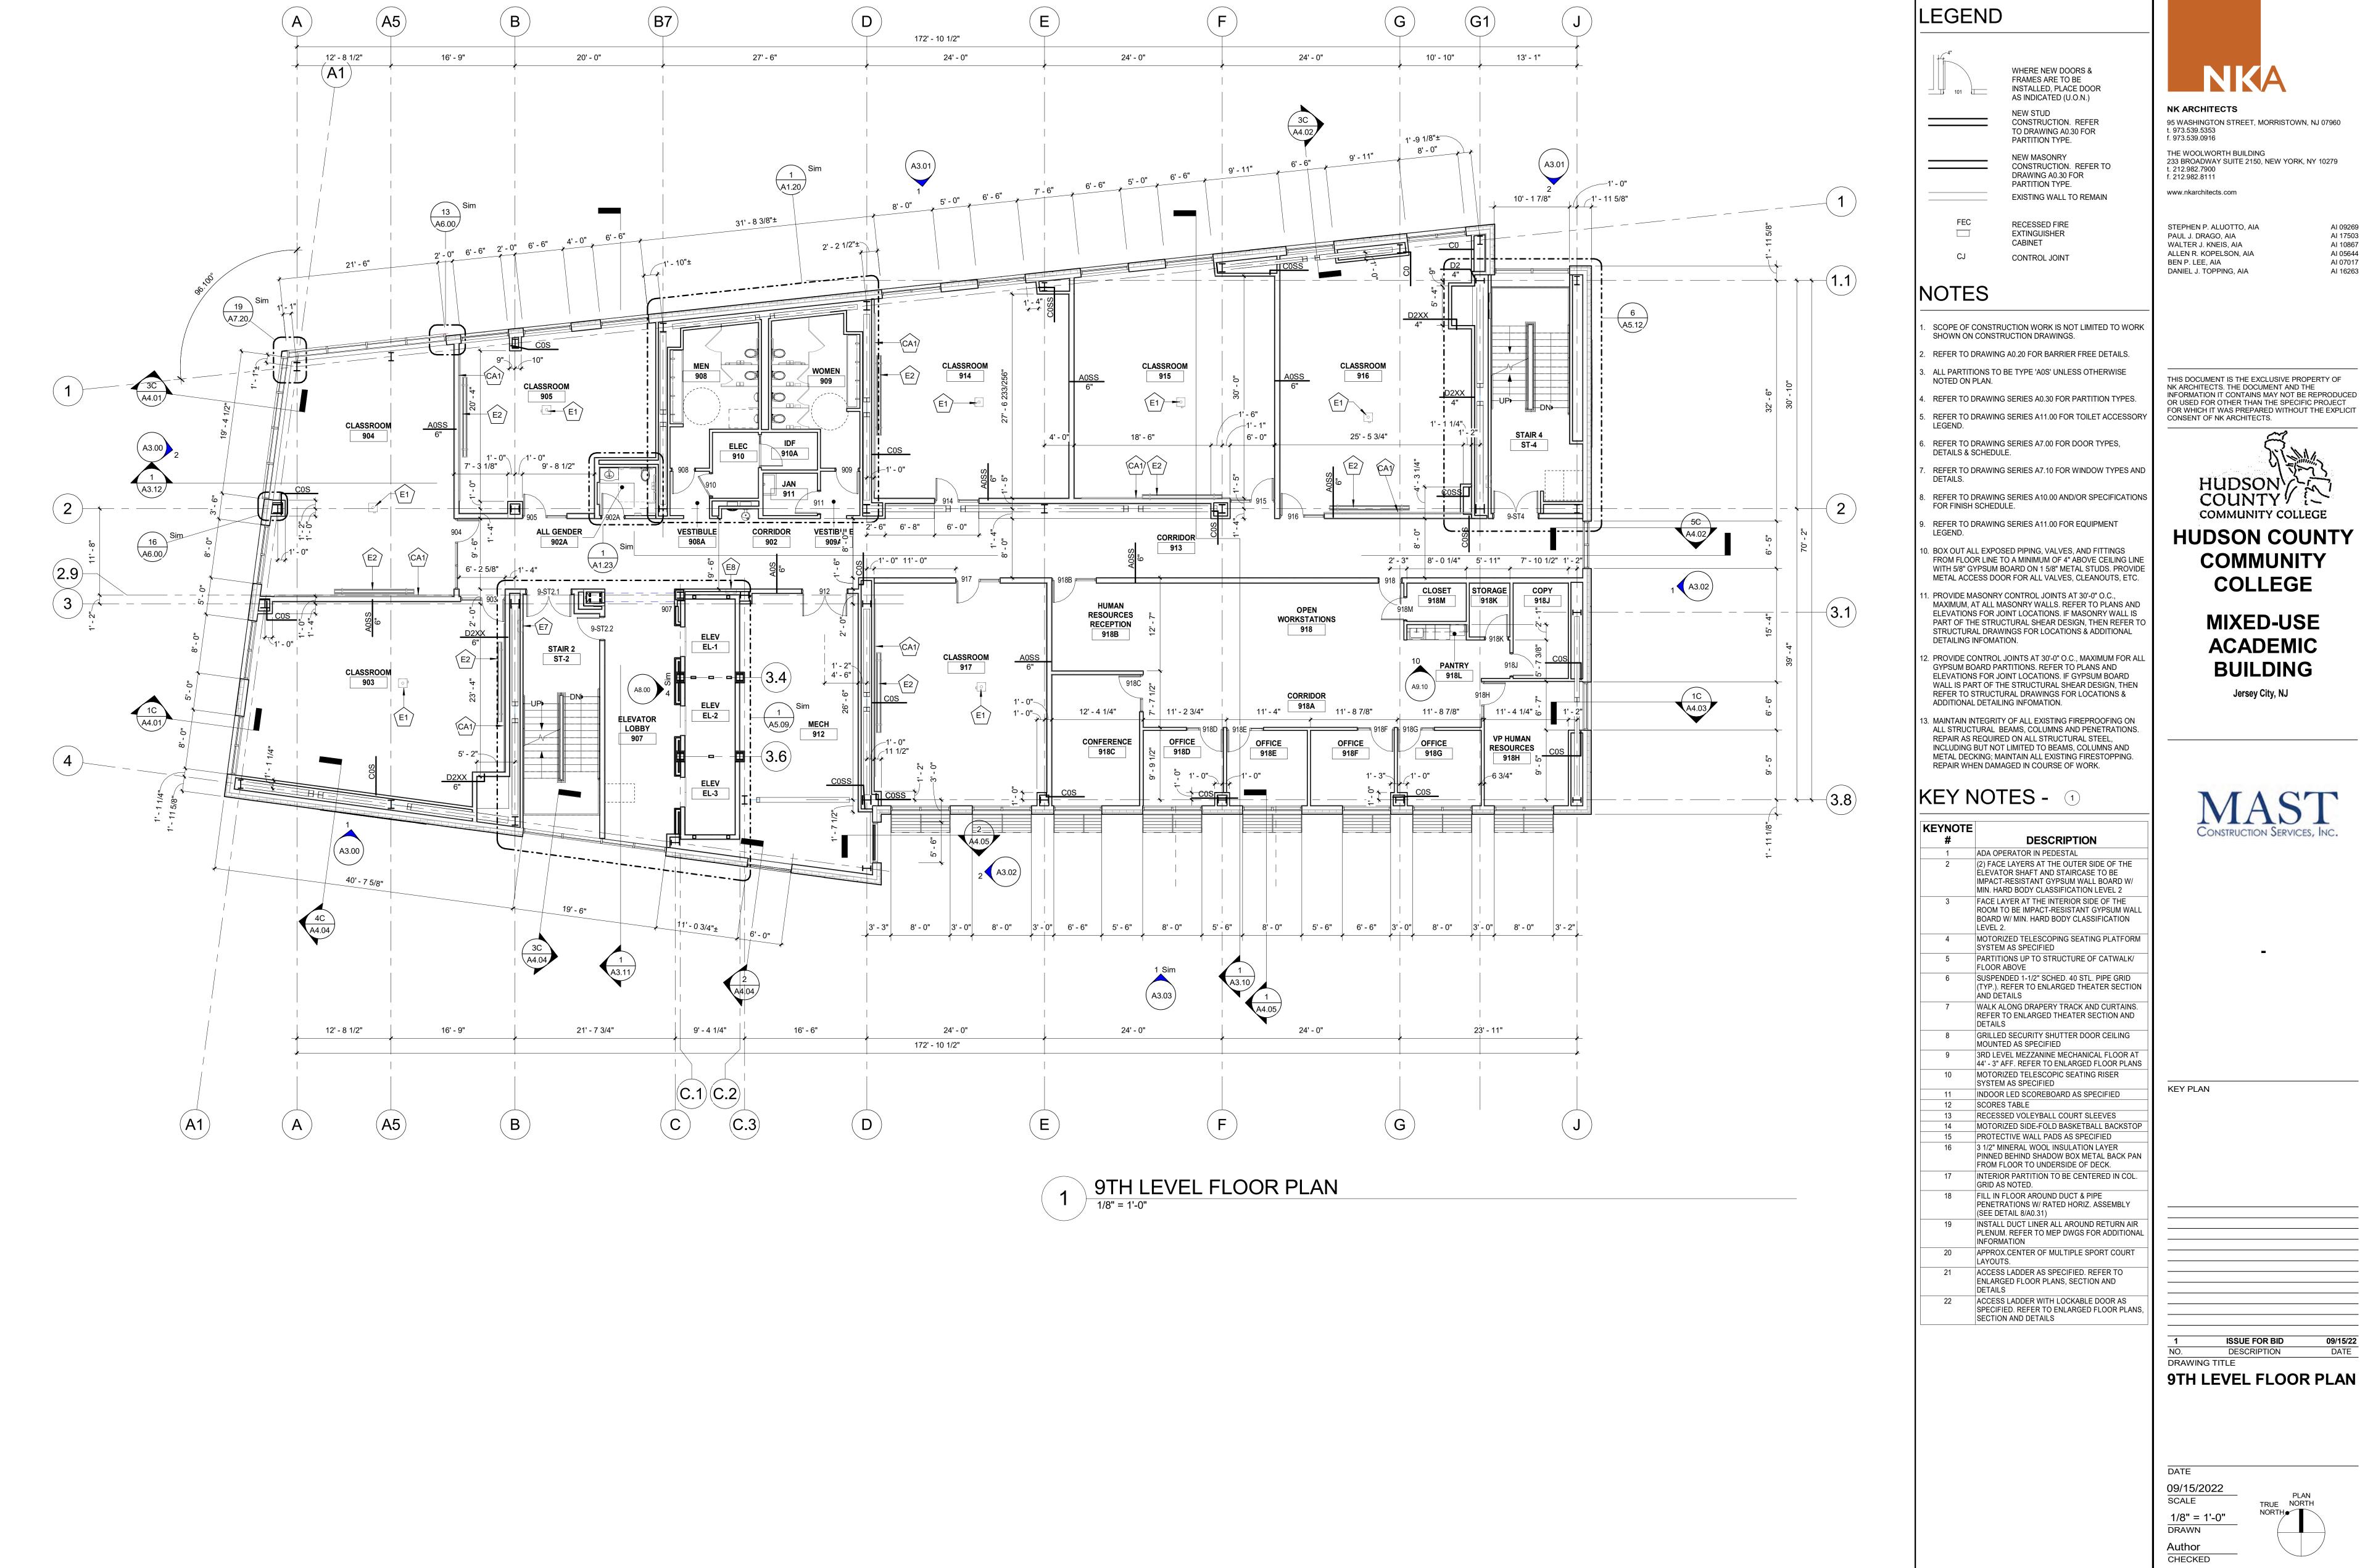
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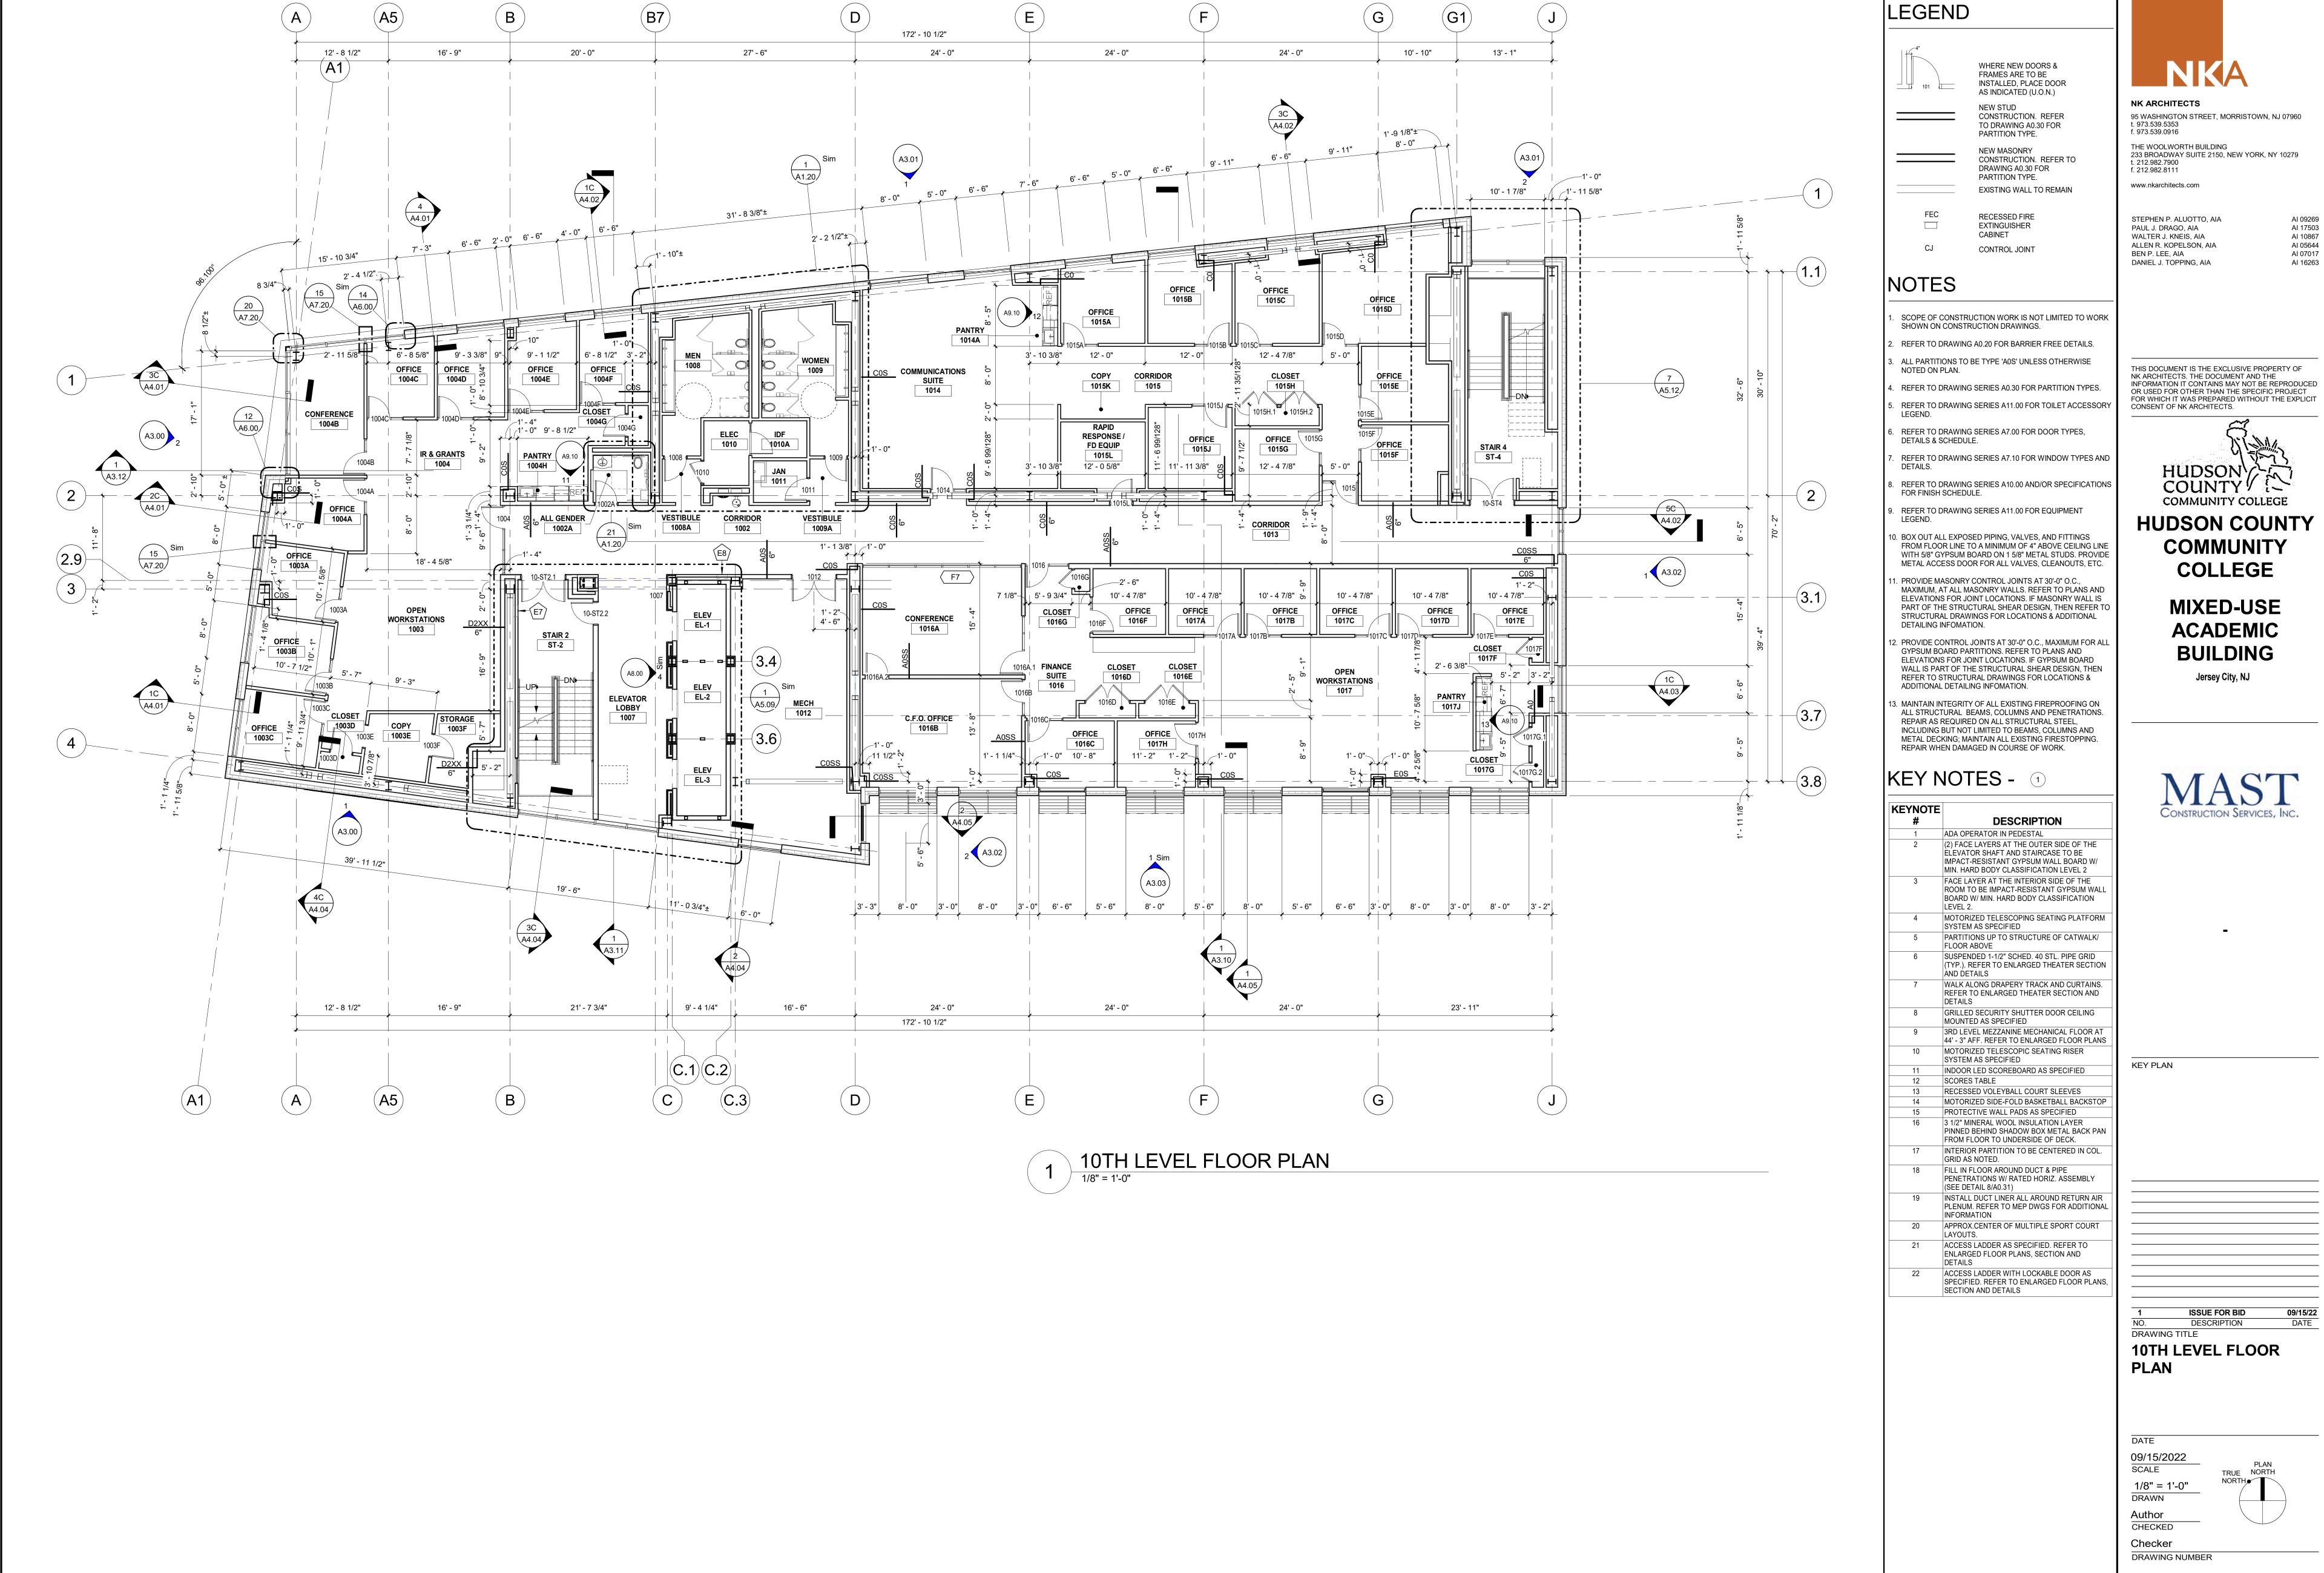
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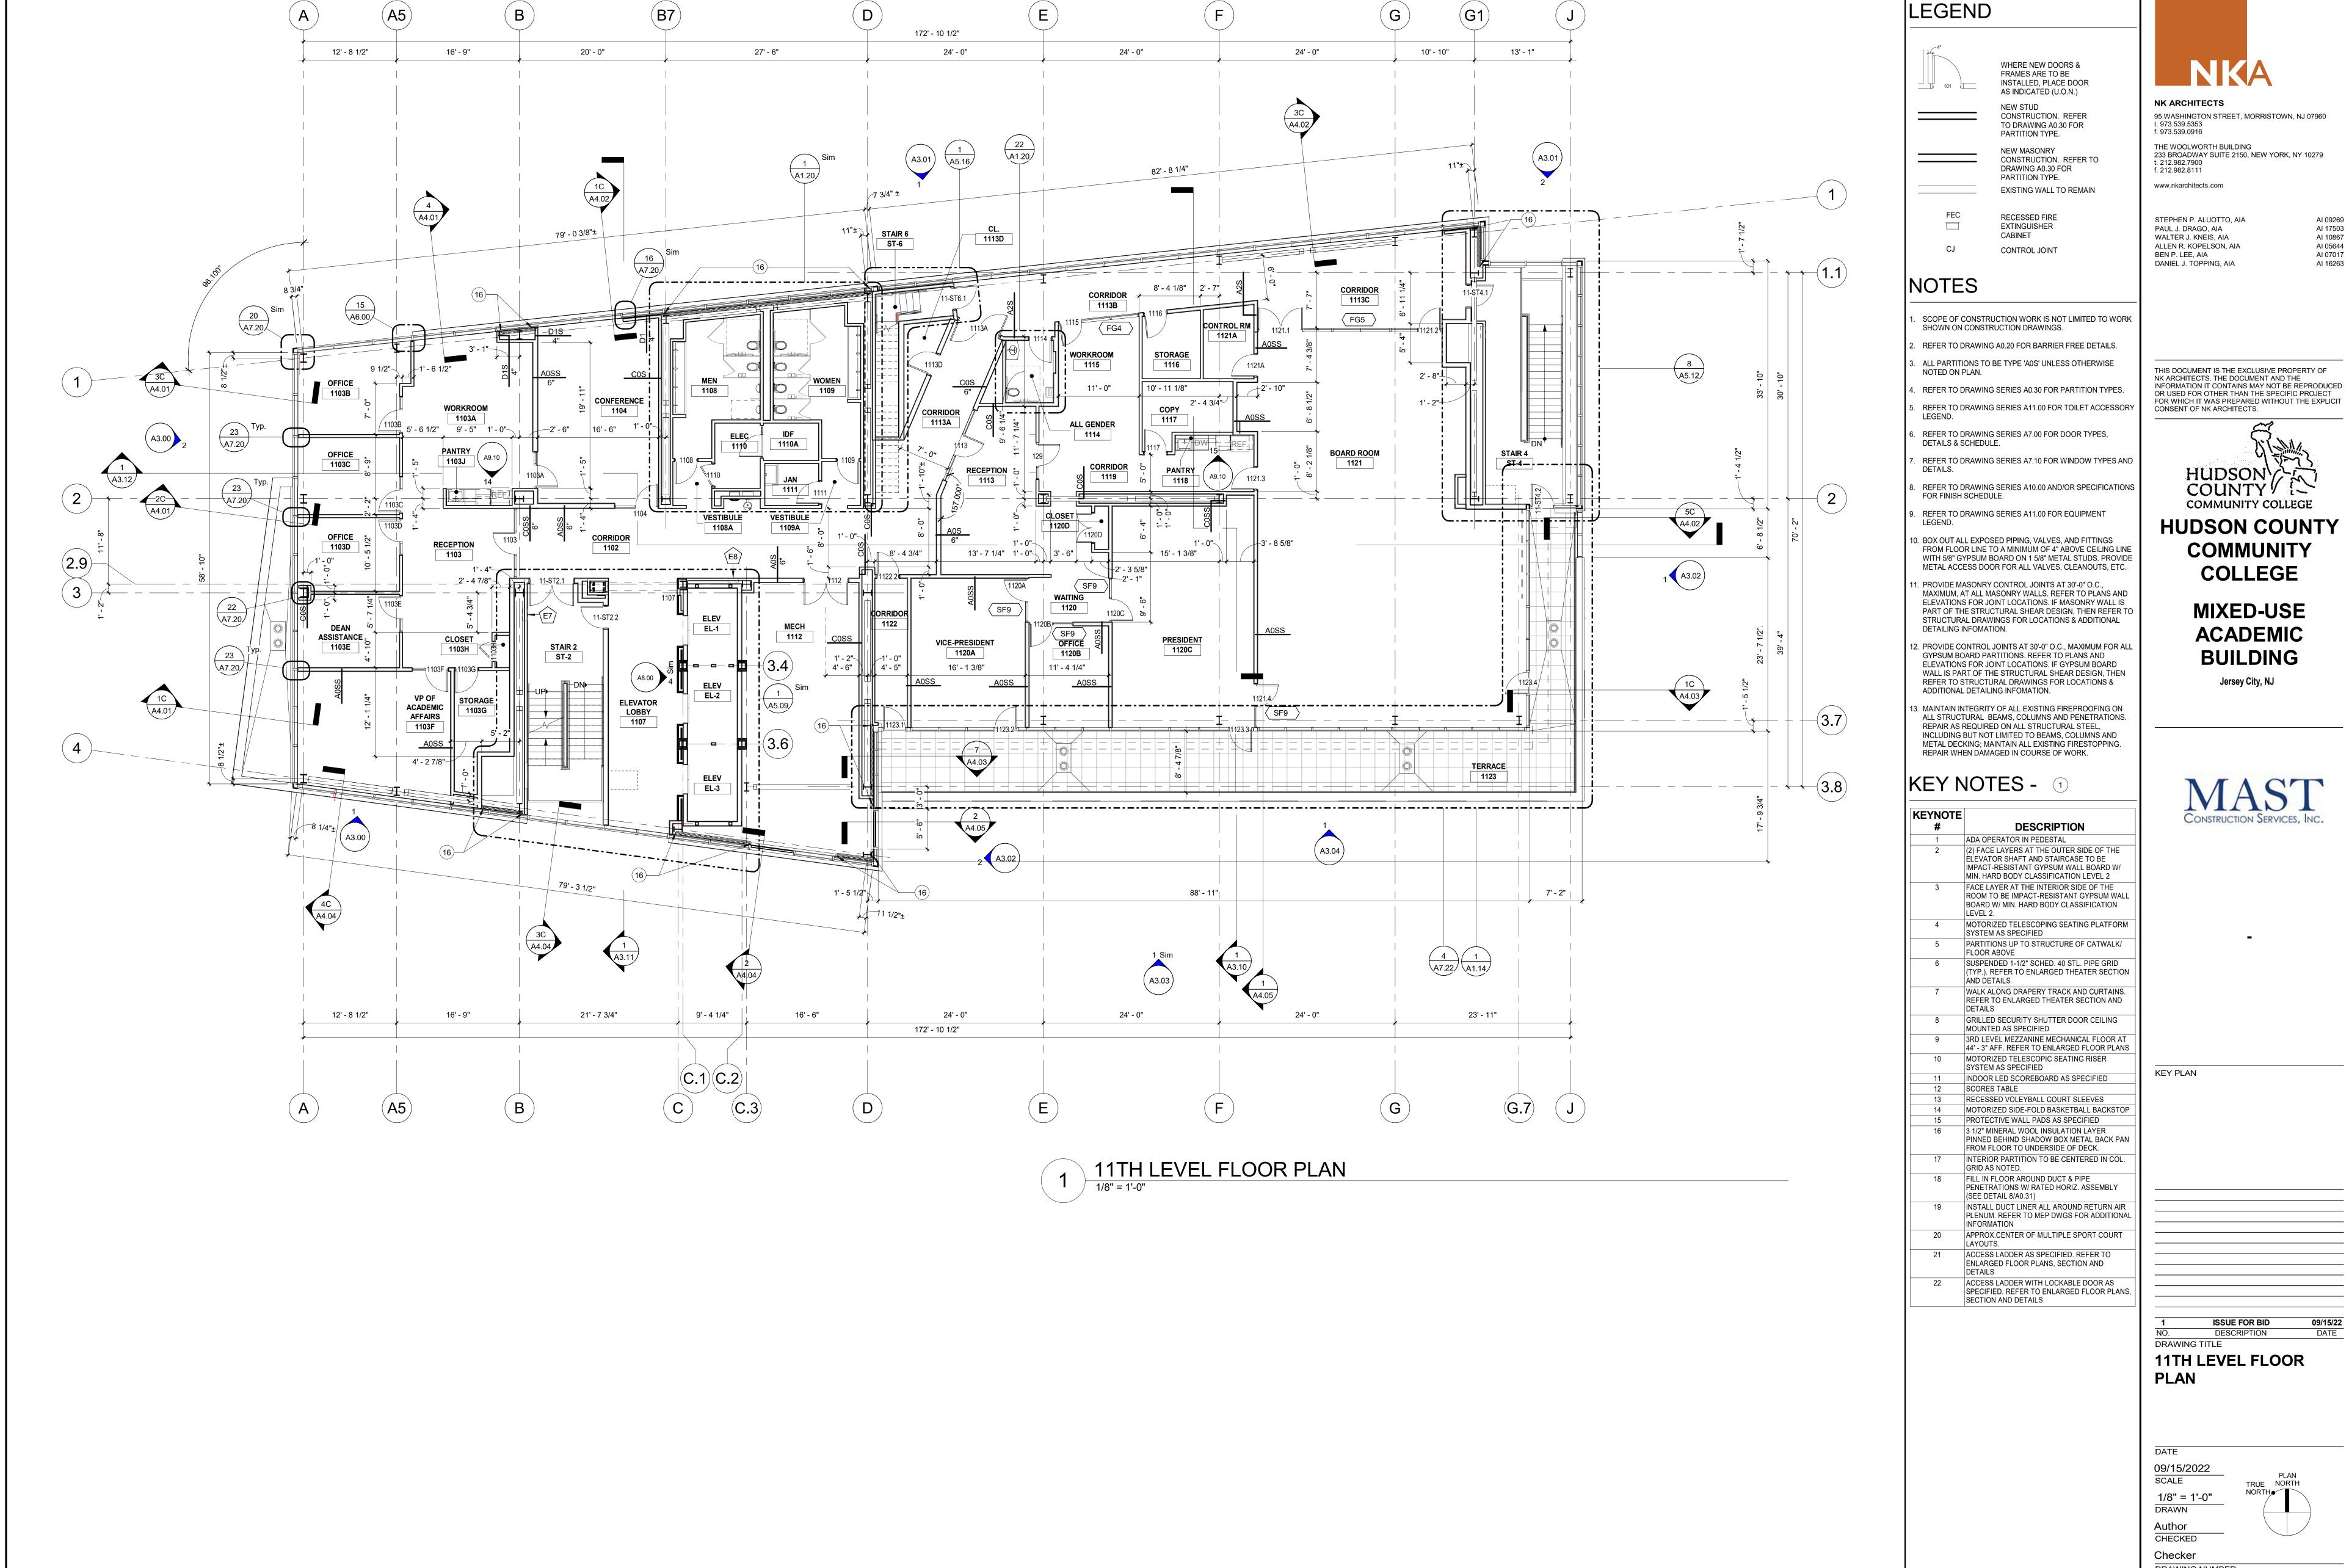


Checker **DRAWING NUMBER**

A1.09

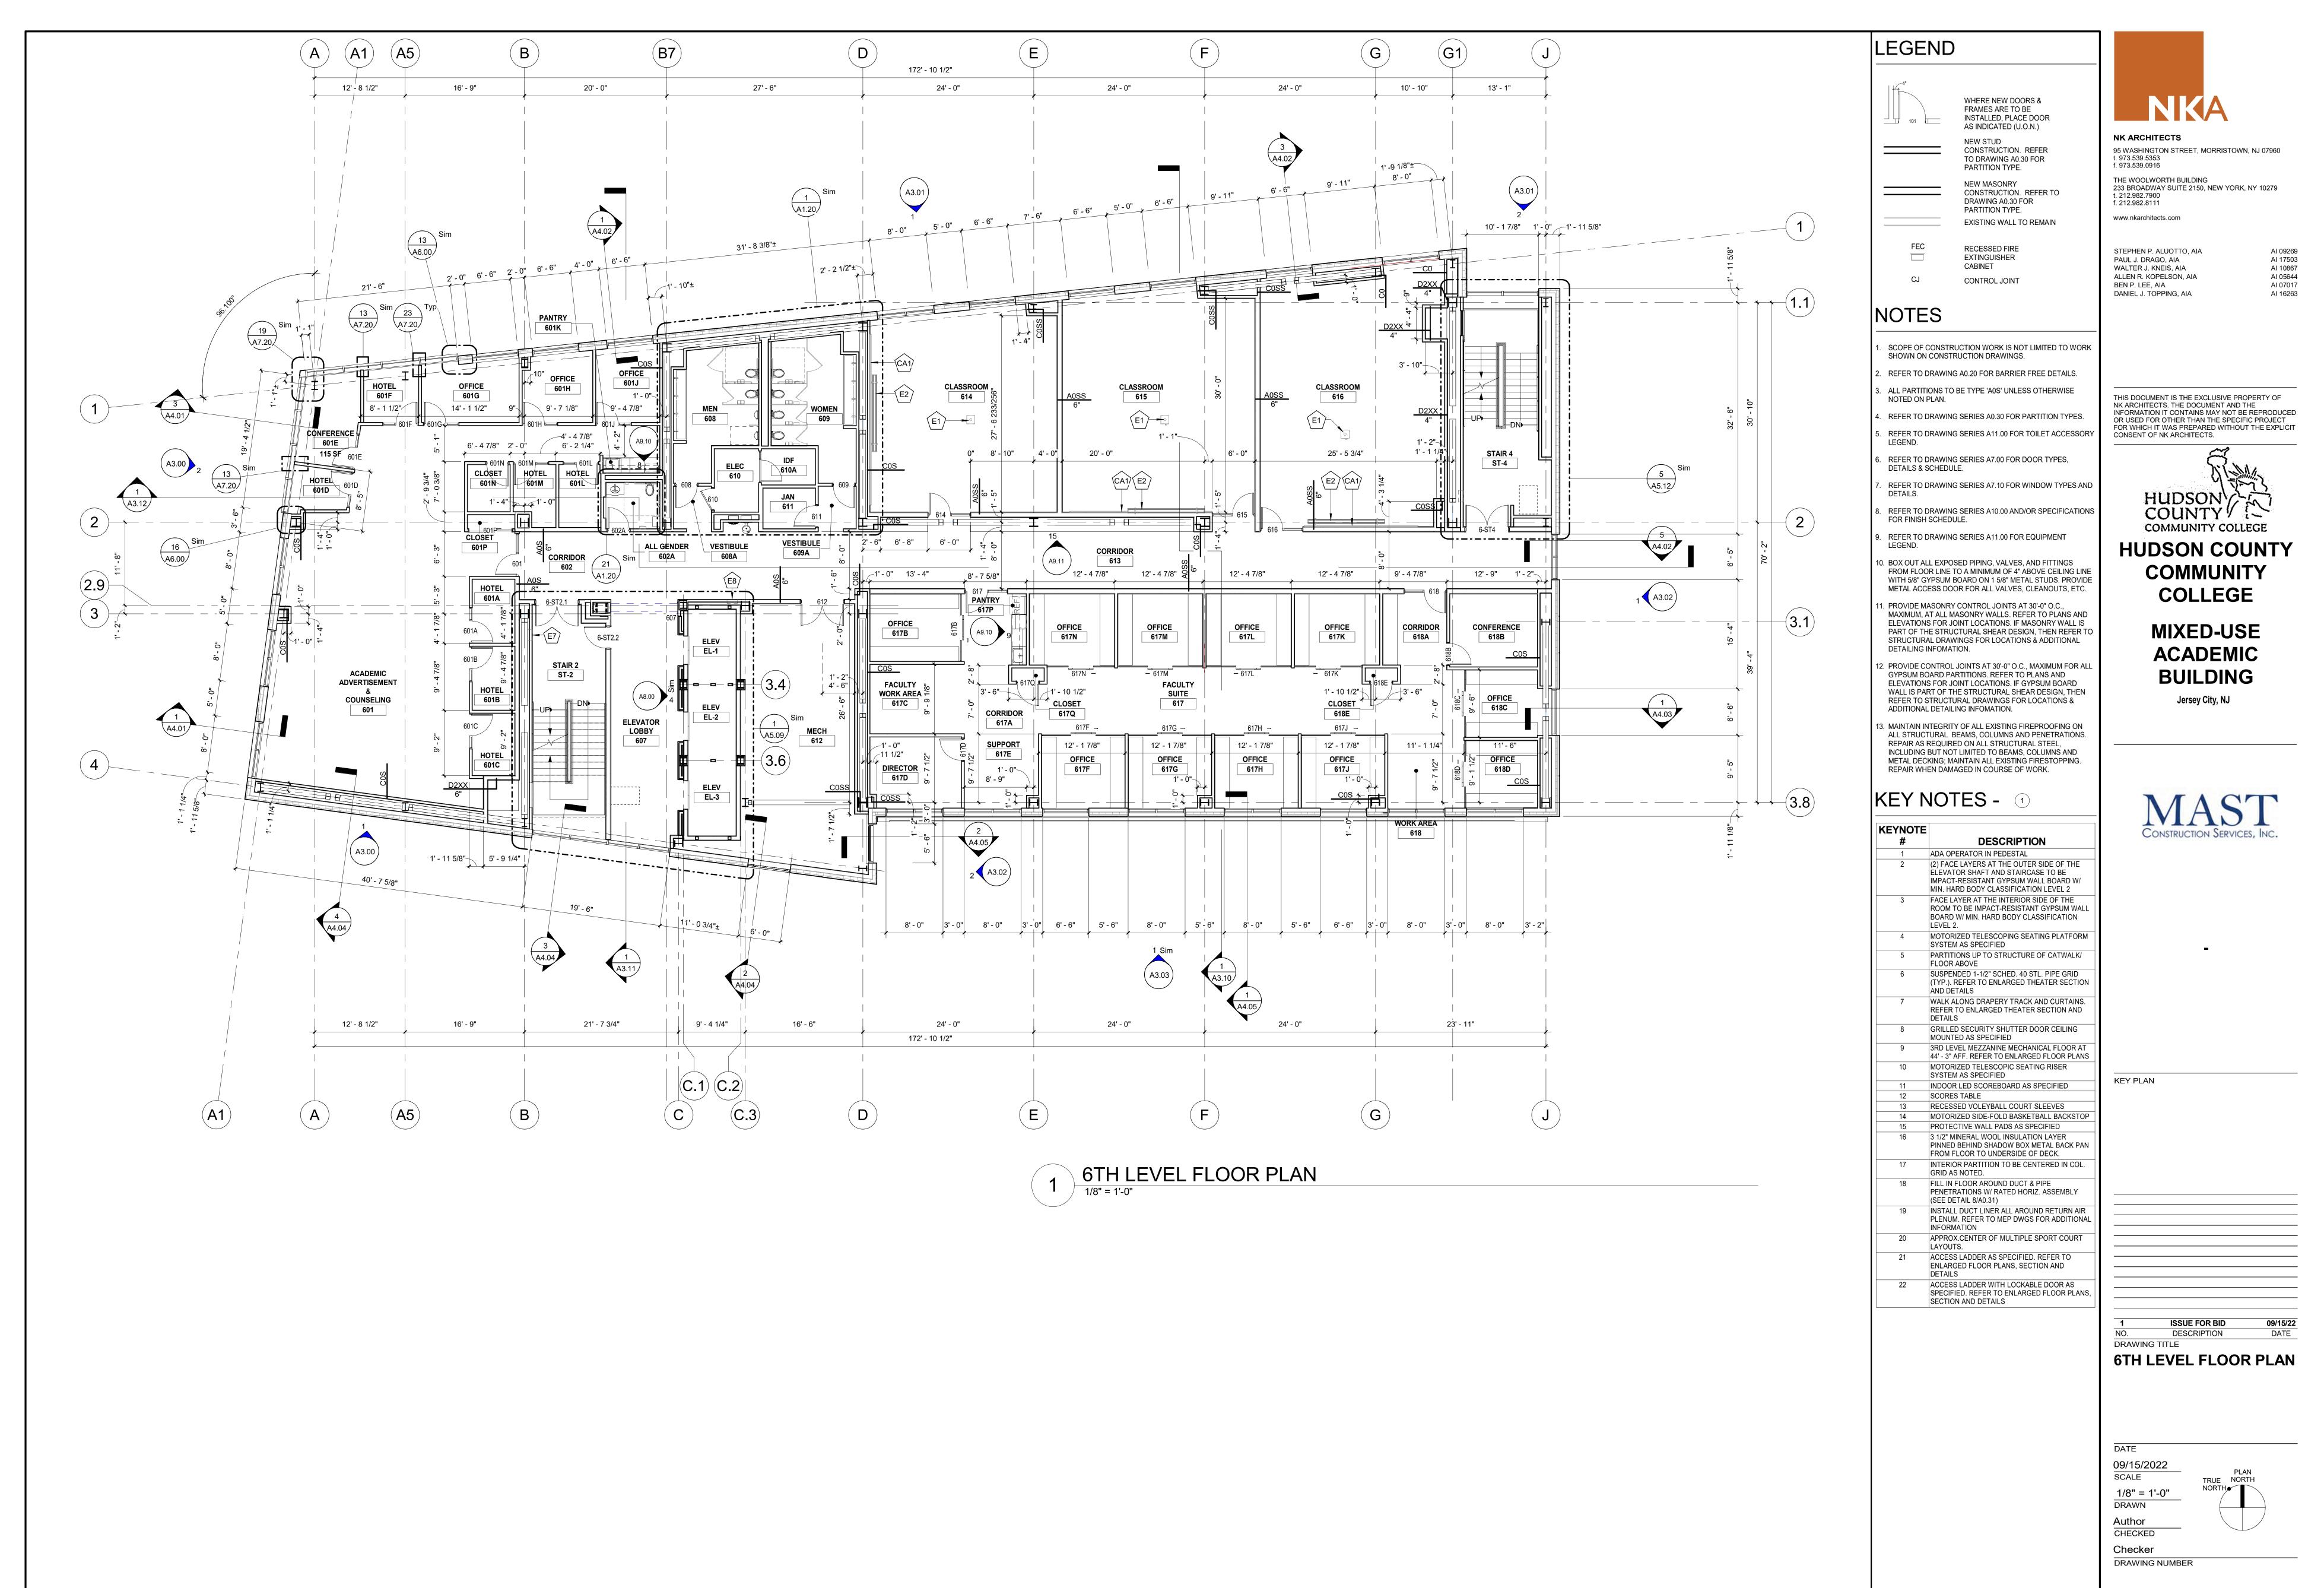


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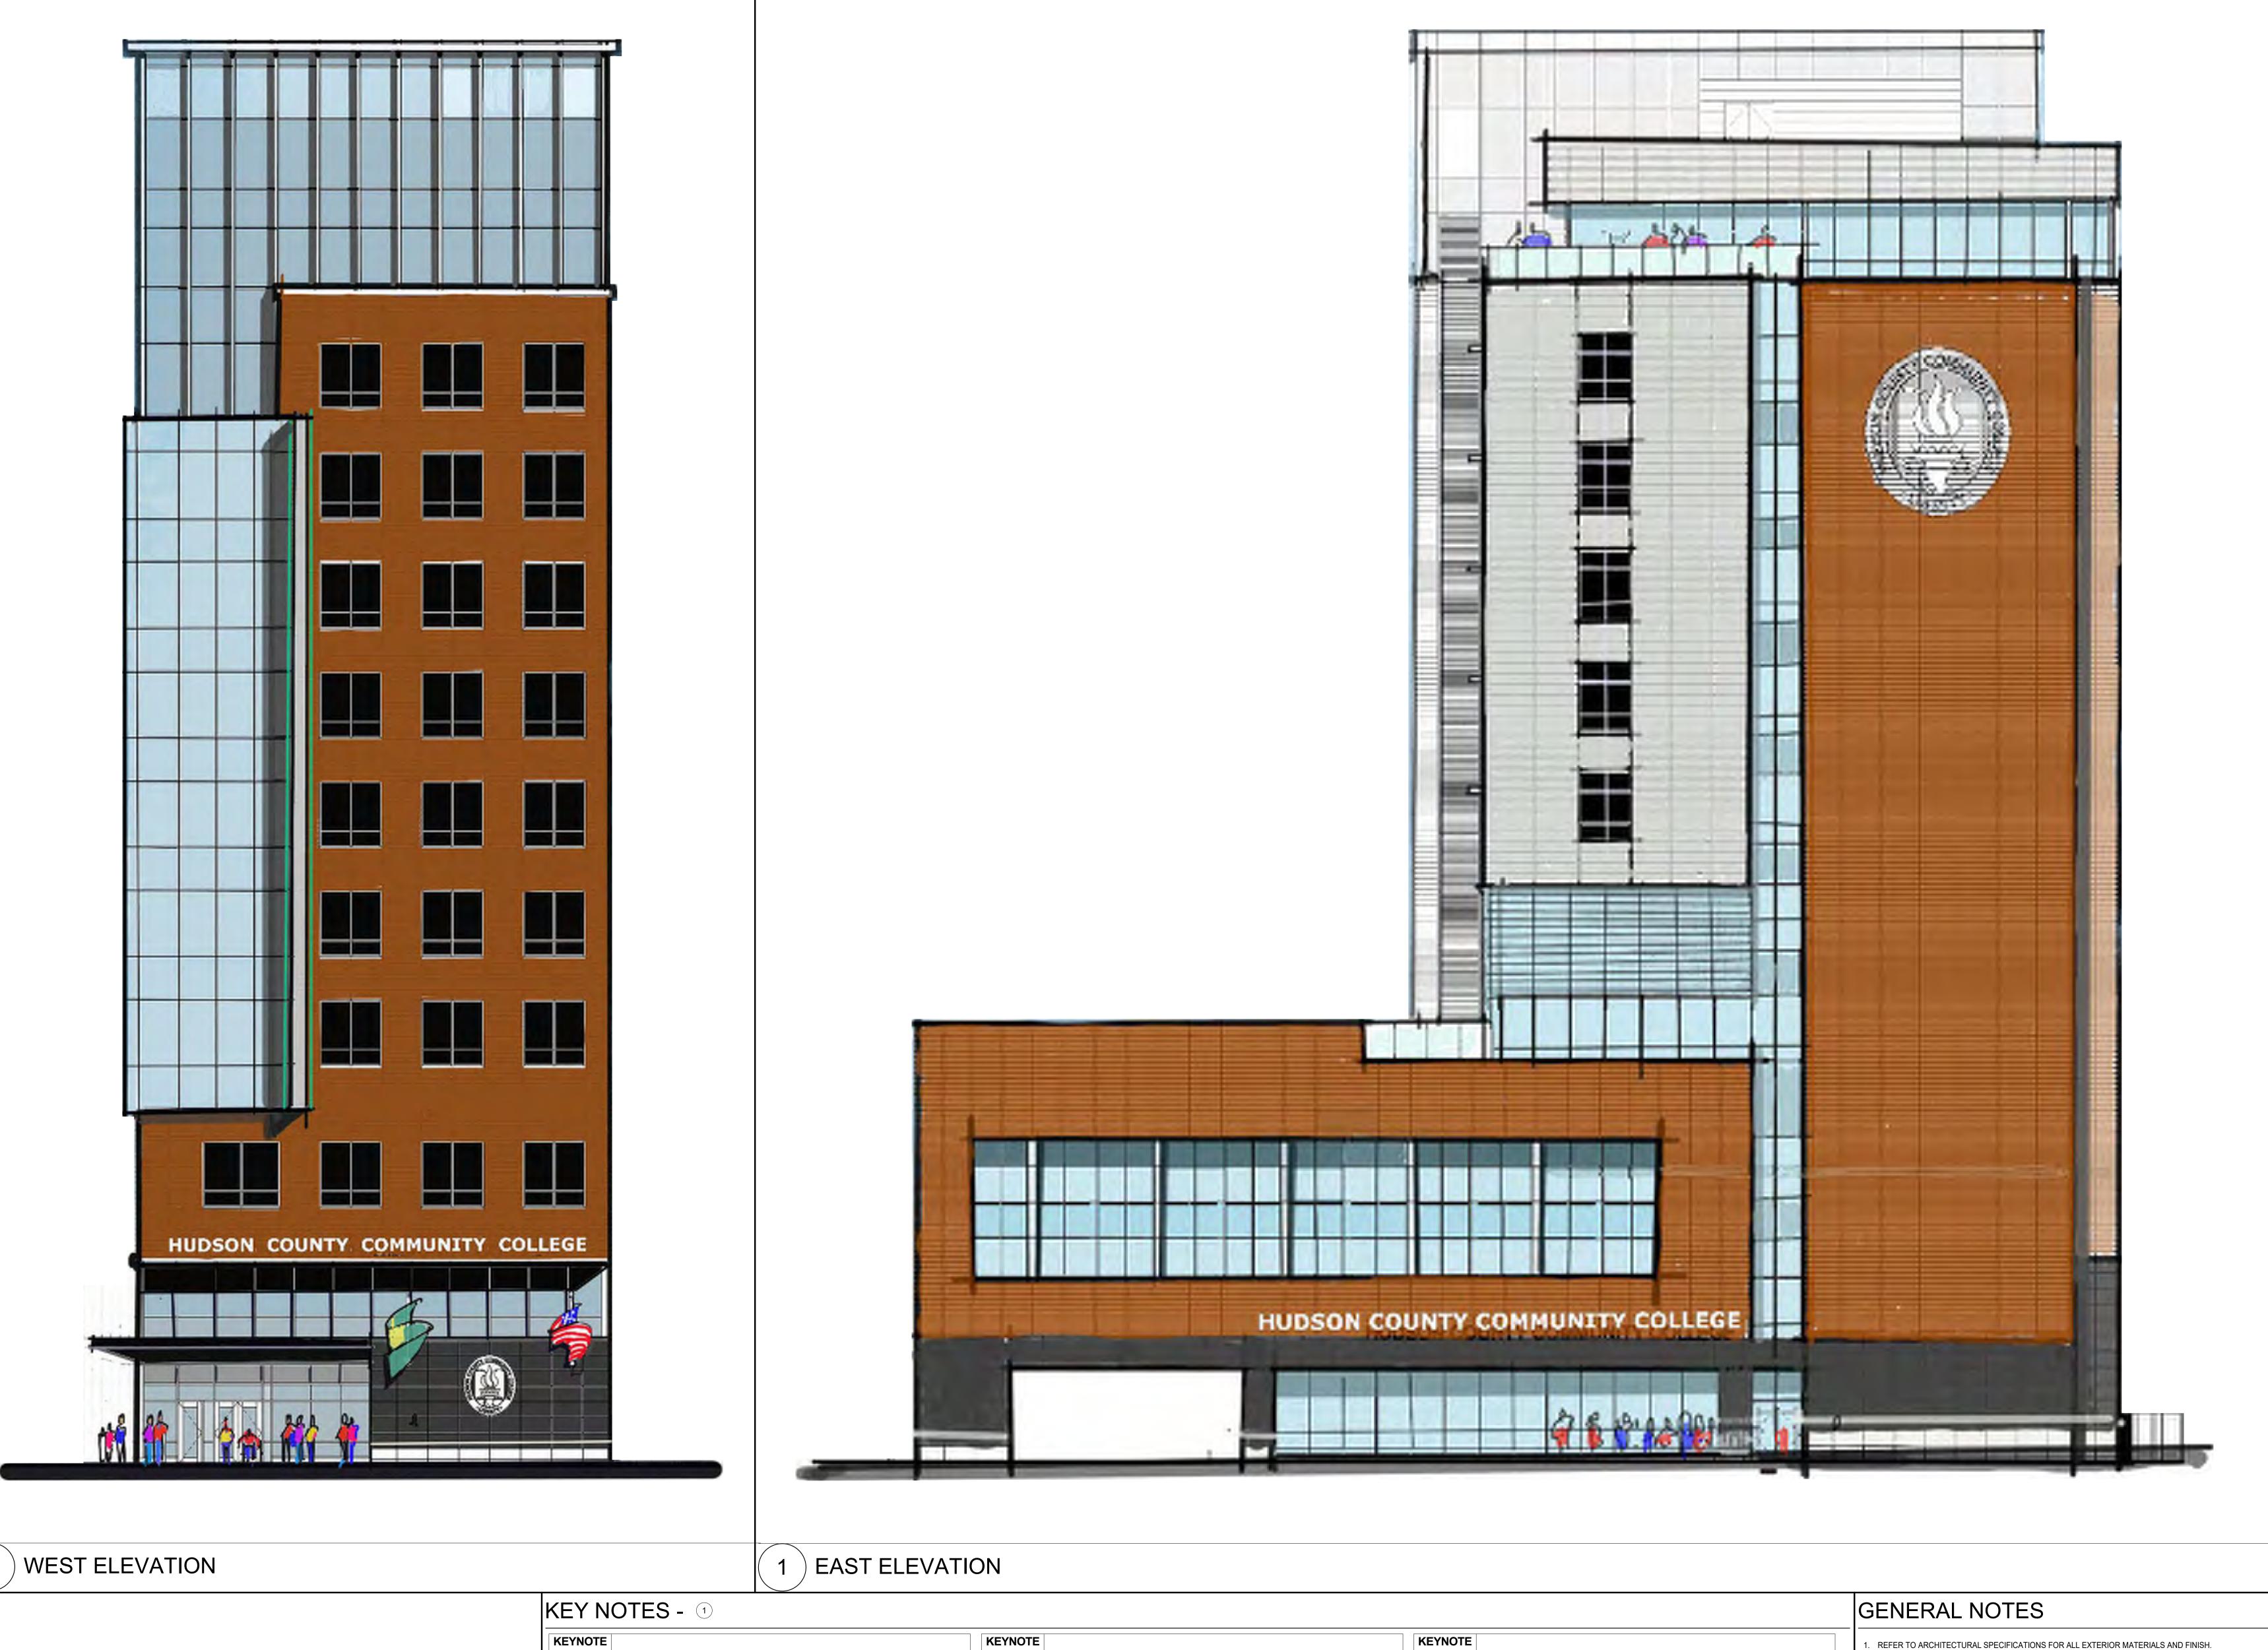


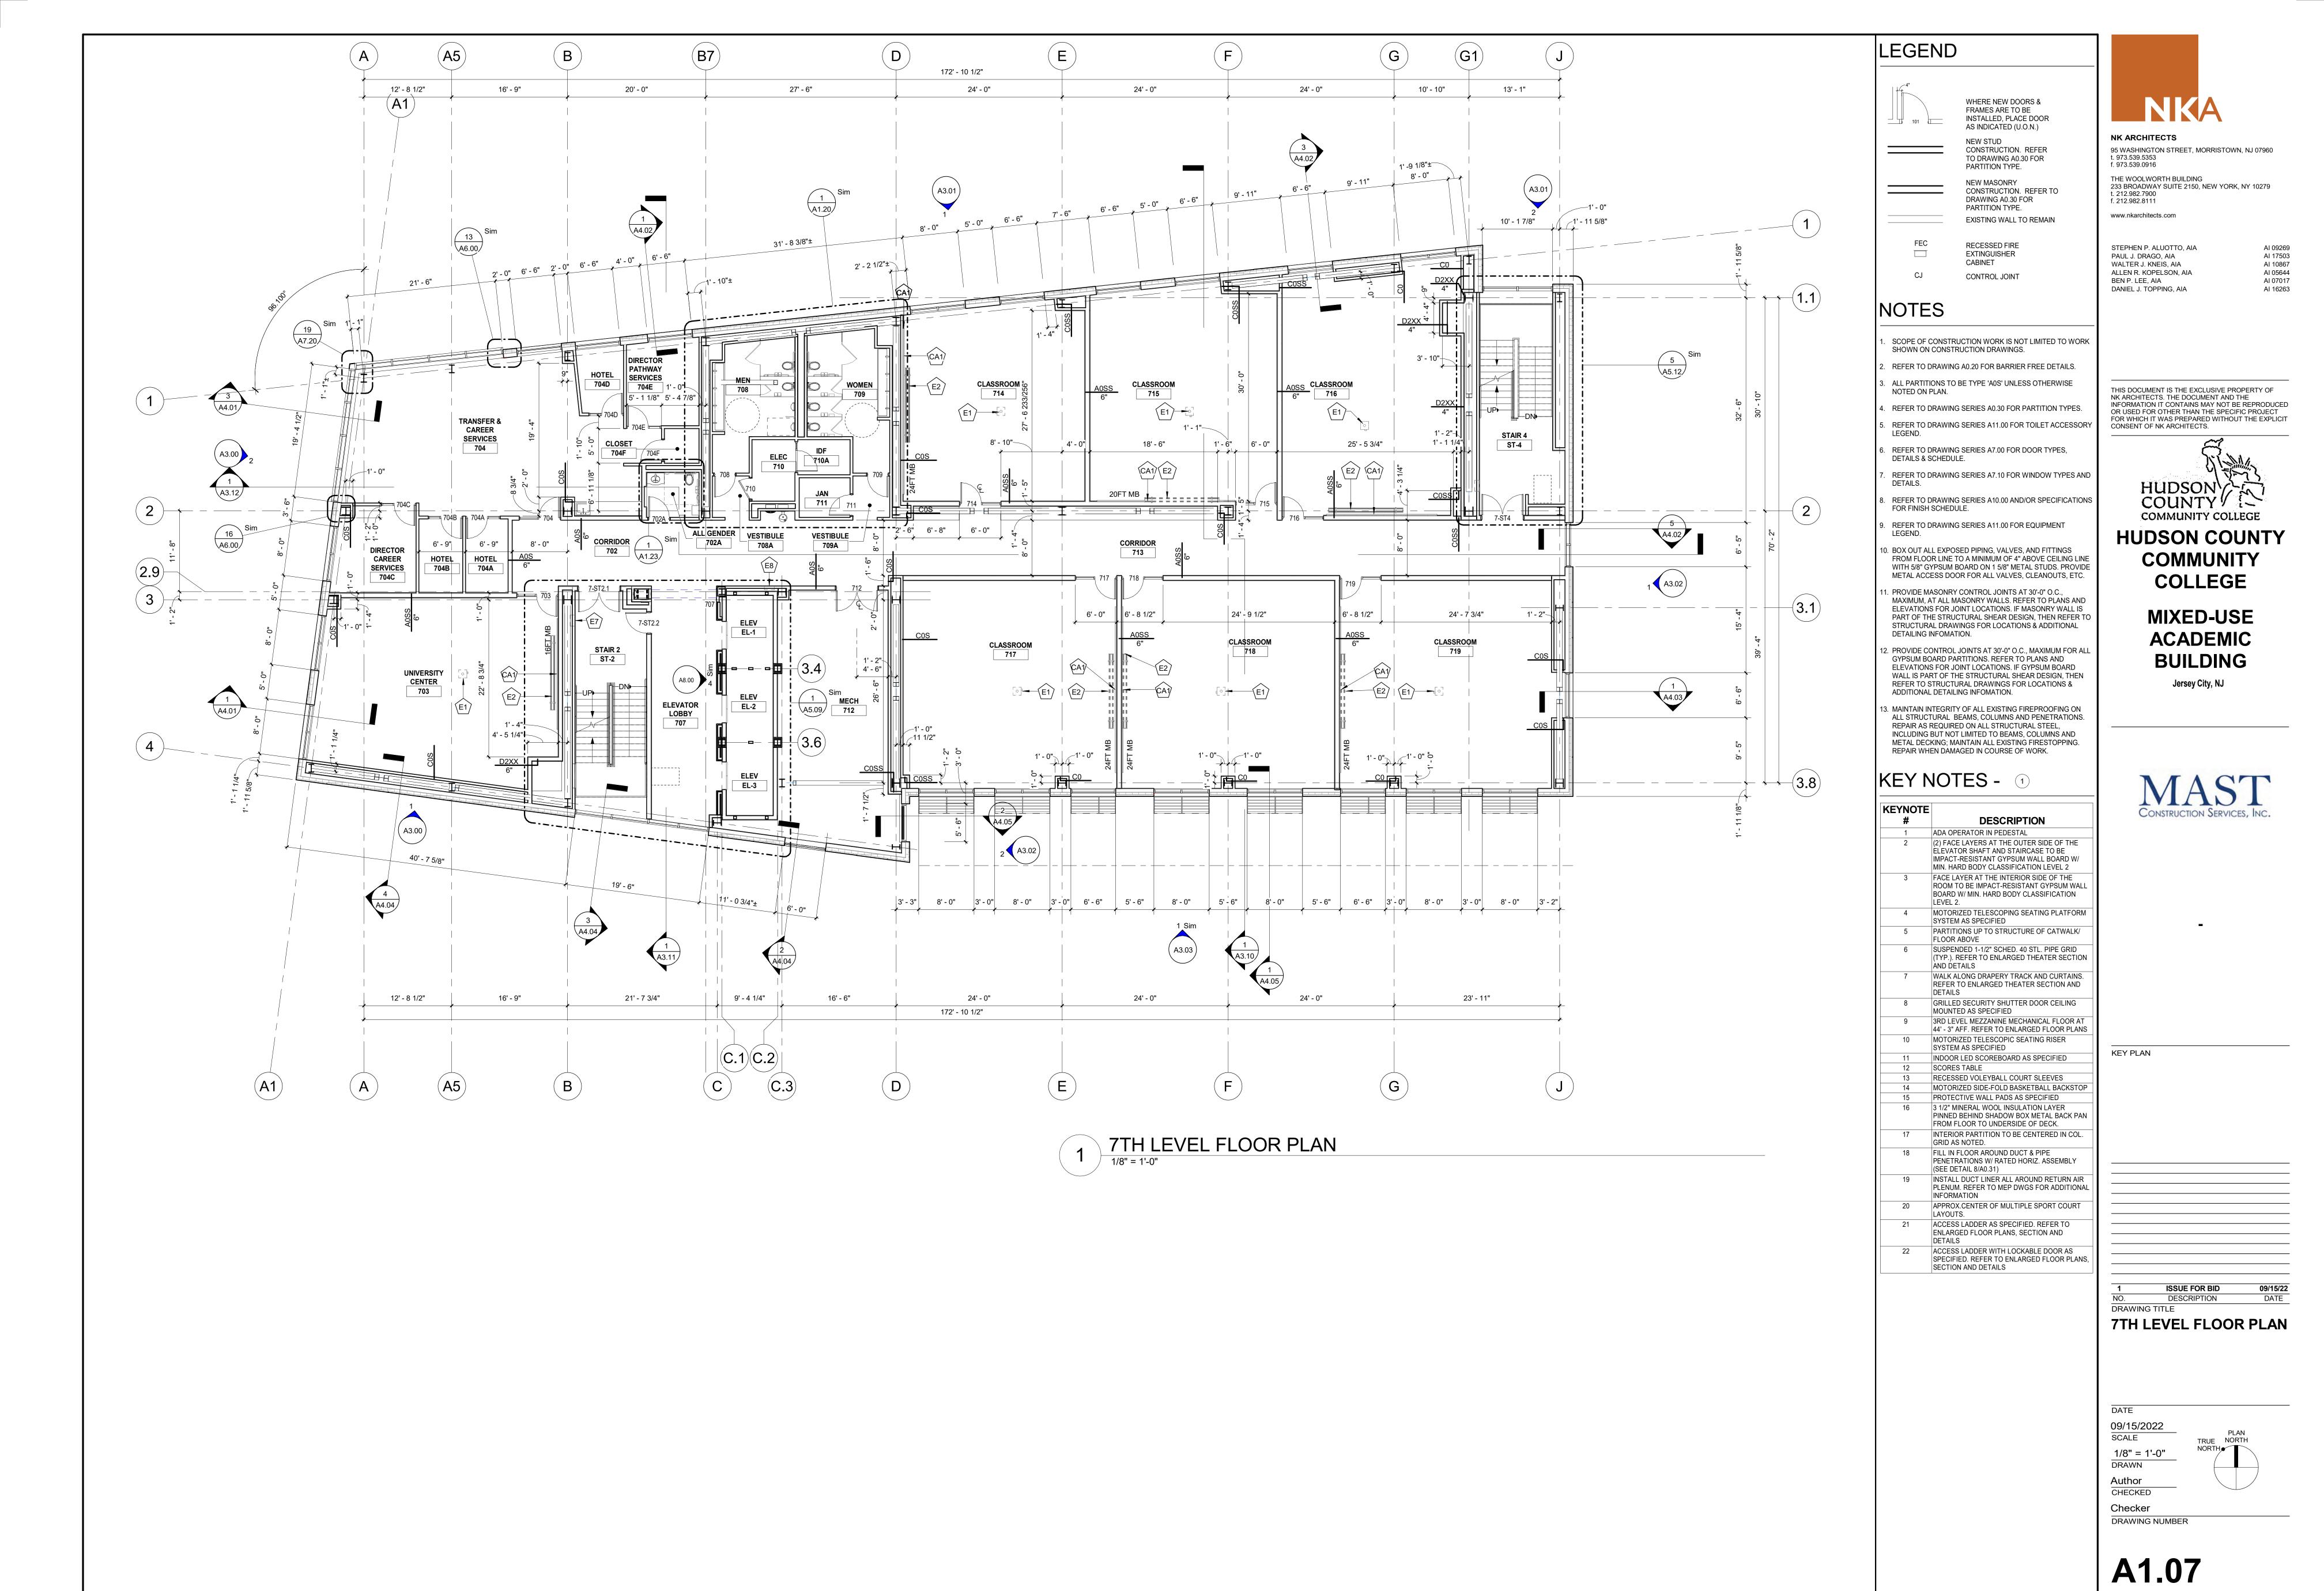DRAWING NUMBER

A1.11

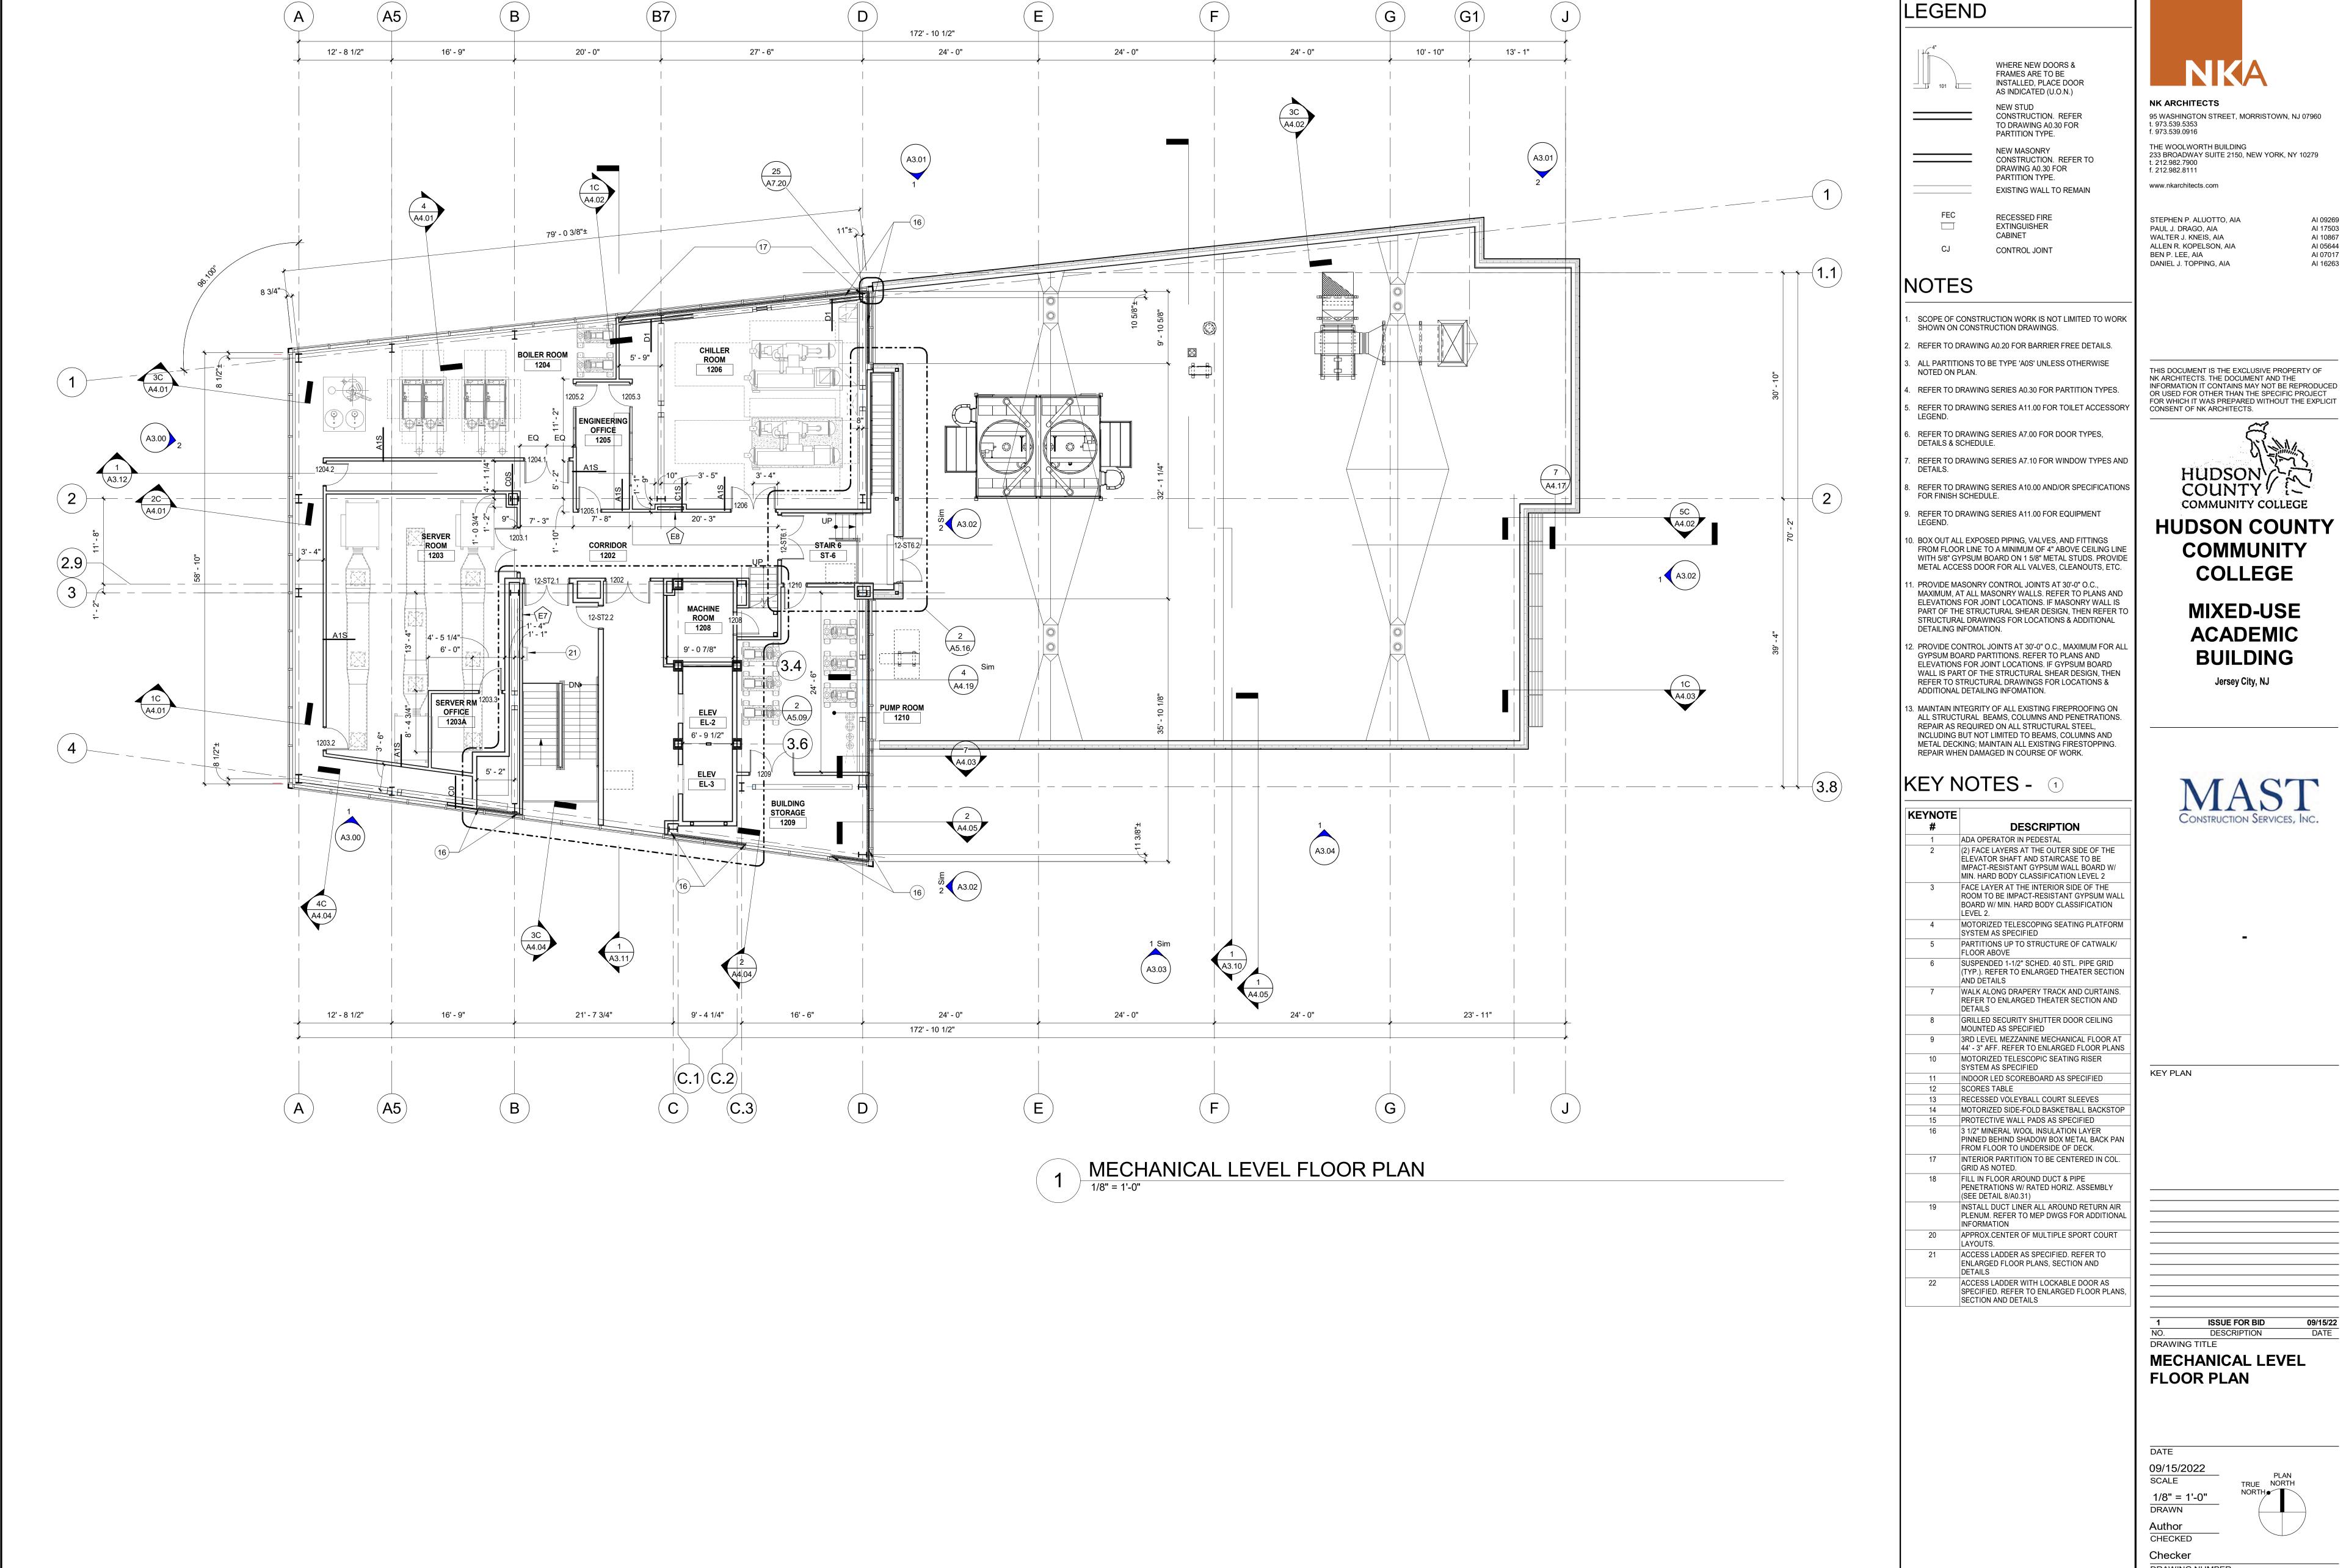

A1.12



DESCRIPTION

HORIZONTAL SUNSHADE SYSTEM ATTACHED TO CURTAIN WALL AS SPECIFIED

EXTERIOR RAILING ASSEMBLY AS SPECIFIED

LOGO "A" CENTERED AT WALL AS SPECIFIED

30" SUNSHADES OUTRIGGER SYSTEM AS SPECIFIED
ALTERNATE SCREEN AS SPECIFIED. REFER TO DETAILS

ARCHITECTURAL GRADE FINISH CONCRETE AS SPECIFIED

ARCHITECTURAL LOUVERS AS SPECIFIED

CONCRETE SLAB AND STEPS AS SPECIFIED

LOGO "B" AS SPECIFIED
LETTERING "B" AS SPECIFIED

EXPANSION JOINT AS SPECIFIED

DESCRIPTION

STRUCTURAL FRAMELESS GLAZING AS SPECIFIED. REFER TO FLOOR PLAN AND DETAILS

ACCESS LADDER WITH LOCKABLE DOOR AS SPECIFIED. REFER TO ENLARGED FLOOR PLANS, SECTION AND DETAILS

ALIGN VERTICAL JOINTS

DESCRIPTION

PERFORATED FENCE SYSTEM SWING GATE AND PANELS AS SPECIFIED. REFER TO CIVIL DWGS FOR MORE INFORMATION

TERRACOTTA RAINSCREEN SYSTEM AS SPECIFIED

EXTERIOR ALUM. GLAZING SYSTEM AS SPECIFIED

ALUM. COMPOSITE METAL PANEL AS SPECIFIED

CANOPY AS SPECIFIED. REFER TO DETAILS

ALUM. SHADING SYSTEM AS SPECIFIED

GRANITE VENEER AS SPECIFIED

ALUM. COPING AS SPECIFIED

LETTERING "A" AS SPECIFIED

FLAG POLE AS SPECIFIED

NKA

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ELEVATIONS FOR REFERENCE

KEY PLAN

DESCRIPTION DATE

EXTERIOR ELEVATIONS

DATE 09/15/2022 SCALE

 $\frac{1/8" = 1'-0"}{DRAWN}$

VA CHECKED

RH

DRAWING NUMBER

REFER TO A400 SERIES DRAWINGS FOR TYPICAL WALL SECTIONS AND ADDITIONAL INFORMATION.

3. REFER TO CIVIL DRAWINGS FOR FINISHED GRADE AND FLOOR HEIGHTS.

SK.01

