URBY JOURNAL SQUARE

JERSEY CITY, NEW JERSEY

LANDSCAPE ARCHITECTURE PLANS



OWNER / DEVELOPER

575 PAVONIA LLC 50 WASHINGTON STREET HOBOKEN, NJ 07030 PHONE (201) 963-5200

LANDSCAPE ARCHITECT

MELILLO + BAUER ASSOCIATES LANDSCAPE ARCHITECTURE 200 UNION AVENUE BRIELLE, NEW JERSEY 08730 (732) 528-0664

DESIGN ARCHITECT

CONCRETE
OUDEZIJDS ACHTERBURGWAL 78A
1012 DR AMSTERDAM
+31(0)20 5200 200

ARCHITECT

HLW 122 MAIN STREET MADISON, NJ 07940 (973) 210-4020

CIVIL ENGINEER

1955 ROUTE 34, SUITE 1A WALL, NJ 07719 (732) 531-7100

STRUCTURAL ENGINEER

DeSIMONE CONSULTING ENGINEERS PLLC 140 BROADWAY, 25TH FLOOR NEW YORK, NJ 10005 (212) 532-2211

MEF

BARONE ENGINEERING ASSOCIATES LLC 100 OAK RIDGE ROAD OAK RIDGE, NJ 07438 (973) 492-1220

PLANNING BOARD SUBMISSION 08/14/2020

Urby Journel Square (Project #19-154)				
DRAWING LIST		DATE	STATUS	
	Cover Sheet	08/14/2020	Planning Board Submission - Resolution Compliance	
L-1	Streetscape Materials Plan	08/14/2020	Planning Board Submission - Resolution Compliance	
L-2	Streetscape Lighting Plan	08/14/2020	Planning Board Submission - Resolution Compliance	
L-2A	Streetscape Lighting Point by Point Plan	08/14/2020	Planning Board Submission - Resolution Compliance	
L-3	Streetscape Planting Plan	08/14/2020	Planning Board Submission - Resolution Compliance	
L-4	Amenity Pool Deck - 25th Floor: Landscape Plans	08/14/2020	Planning Board Submission - Resolution Compliance	
L-5	Site Details - Streetscape	08/14/2020	Planning Board Submission - Resolution Compliance	
L-6	Site Details - Streetscape	08/14/2020	Planning Board Submission - Resolution Compliance	
L-7	Site Details - Streetscape	08/14/2020	Planning Board Submission - Resolution Compliance	
L-8	Planting and Irrigation Details and Notes	08/14/2020	Planning Board Submission - Resolution Compliance	

GENERAL NOTES:


I. THE CONTRACTOR SHALL GIVE ALL NOTICES AND COMPLY WITH ALL LAWS, ORDINANCES, RULES, REGULATIONS, AND LAWFUL ORDERS OF ANY PUBLIC AUTHORITY BEARING ON THE PERFORMANCE OF THE WORK

2. ALL GRADING SHALL BE VERIFIED IN THE FIELD BEFORE CONSTRUCTION AND SHALL BE COORDINATED WITH THE LANDSCAPE ARCHITECT AND CIVIL ENGINEER.

3. ALL PAVING SURFACES SHALL BE FLUSH AND MEET SMOOTHLY AND EVENLY. NO WALKS SHALL EXCEED 5% OR A 2% CROSS-PITCH. ALL WALKS TO BE LAID OUT IN THE FIELD UNDER THE DIRECTION OF THE LANDSCAPE ARCHITECT.

4. ALL SITE DETAILS SHALL BE REVIEWED AND SUPPLEMENTED BY A PROFESSIONAL LICENSED STRUCTURAL ENGINEER WHO SHALL SPECIFY ALL STRUCTURAL DATA, FOOTINGS, REINFORCEMENT, HARDWARE, ETC. REQUIRED FOR STRUCTURAL INTEGRITY, SAFETY AND COMPLIANCE WITH LOCAL CODES AND CONDITIONS PRIOR TO CONSTRUCTION.

- 5. ALL ARCHITECTURAL INFORMATION WAS PROVIDED BY: HLW ARCHITECTS
- 6. ALL ENGINEERING INFORMATION WAS PROVIDED BY: INSITE ENGINEERING
- 7. ALL PLANTED AREAS SHALL BE IRRIGATED WITH DRIP IRRIGATION. CONTRACTOR SHALL SUBMIT SHOP DRAWINGS.
- 8. ALL PLANT MATERIAL/LANDSCAPE MATERIALS SUBSTITUTIONS SHALL BE APPROVED BY THE L.A./OWNERS REPRESENTATIVES.

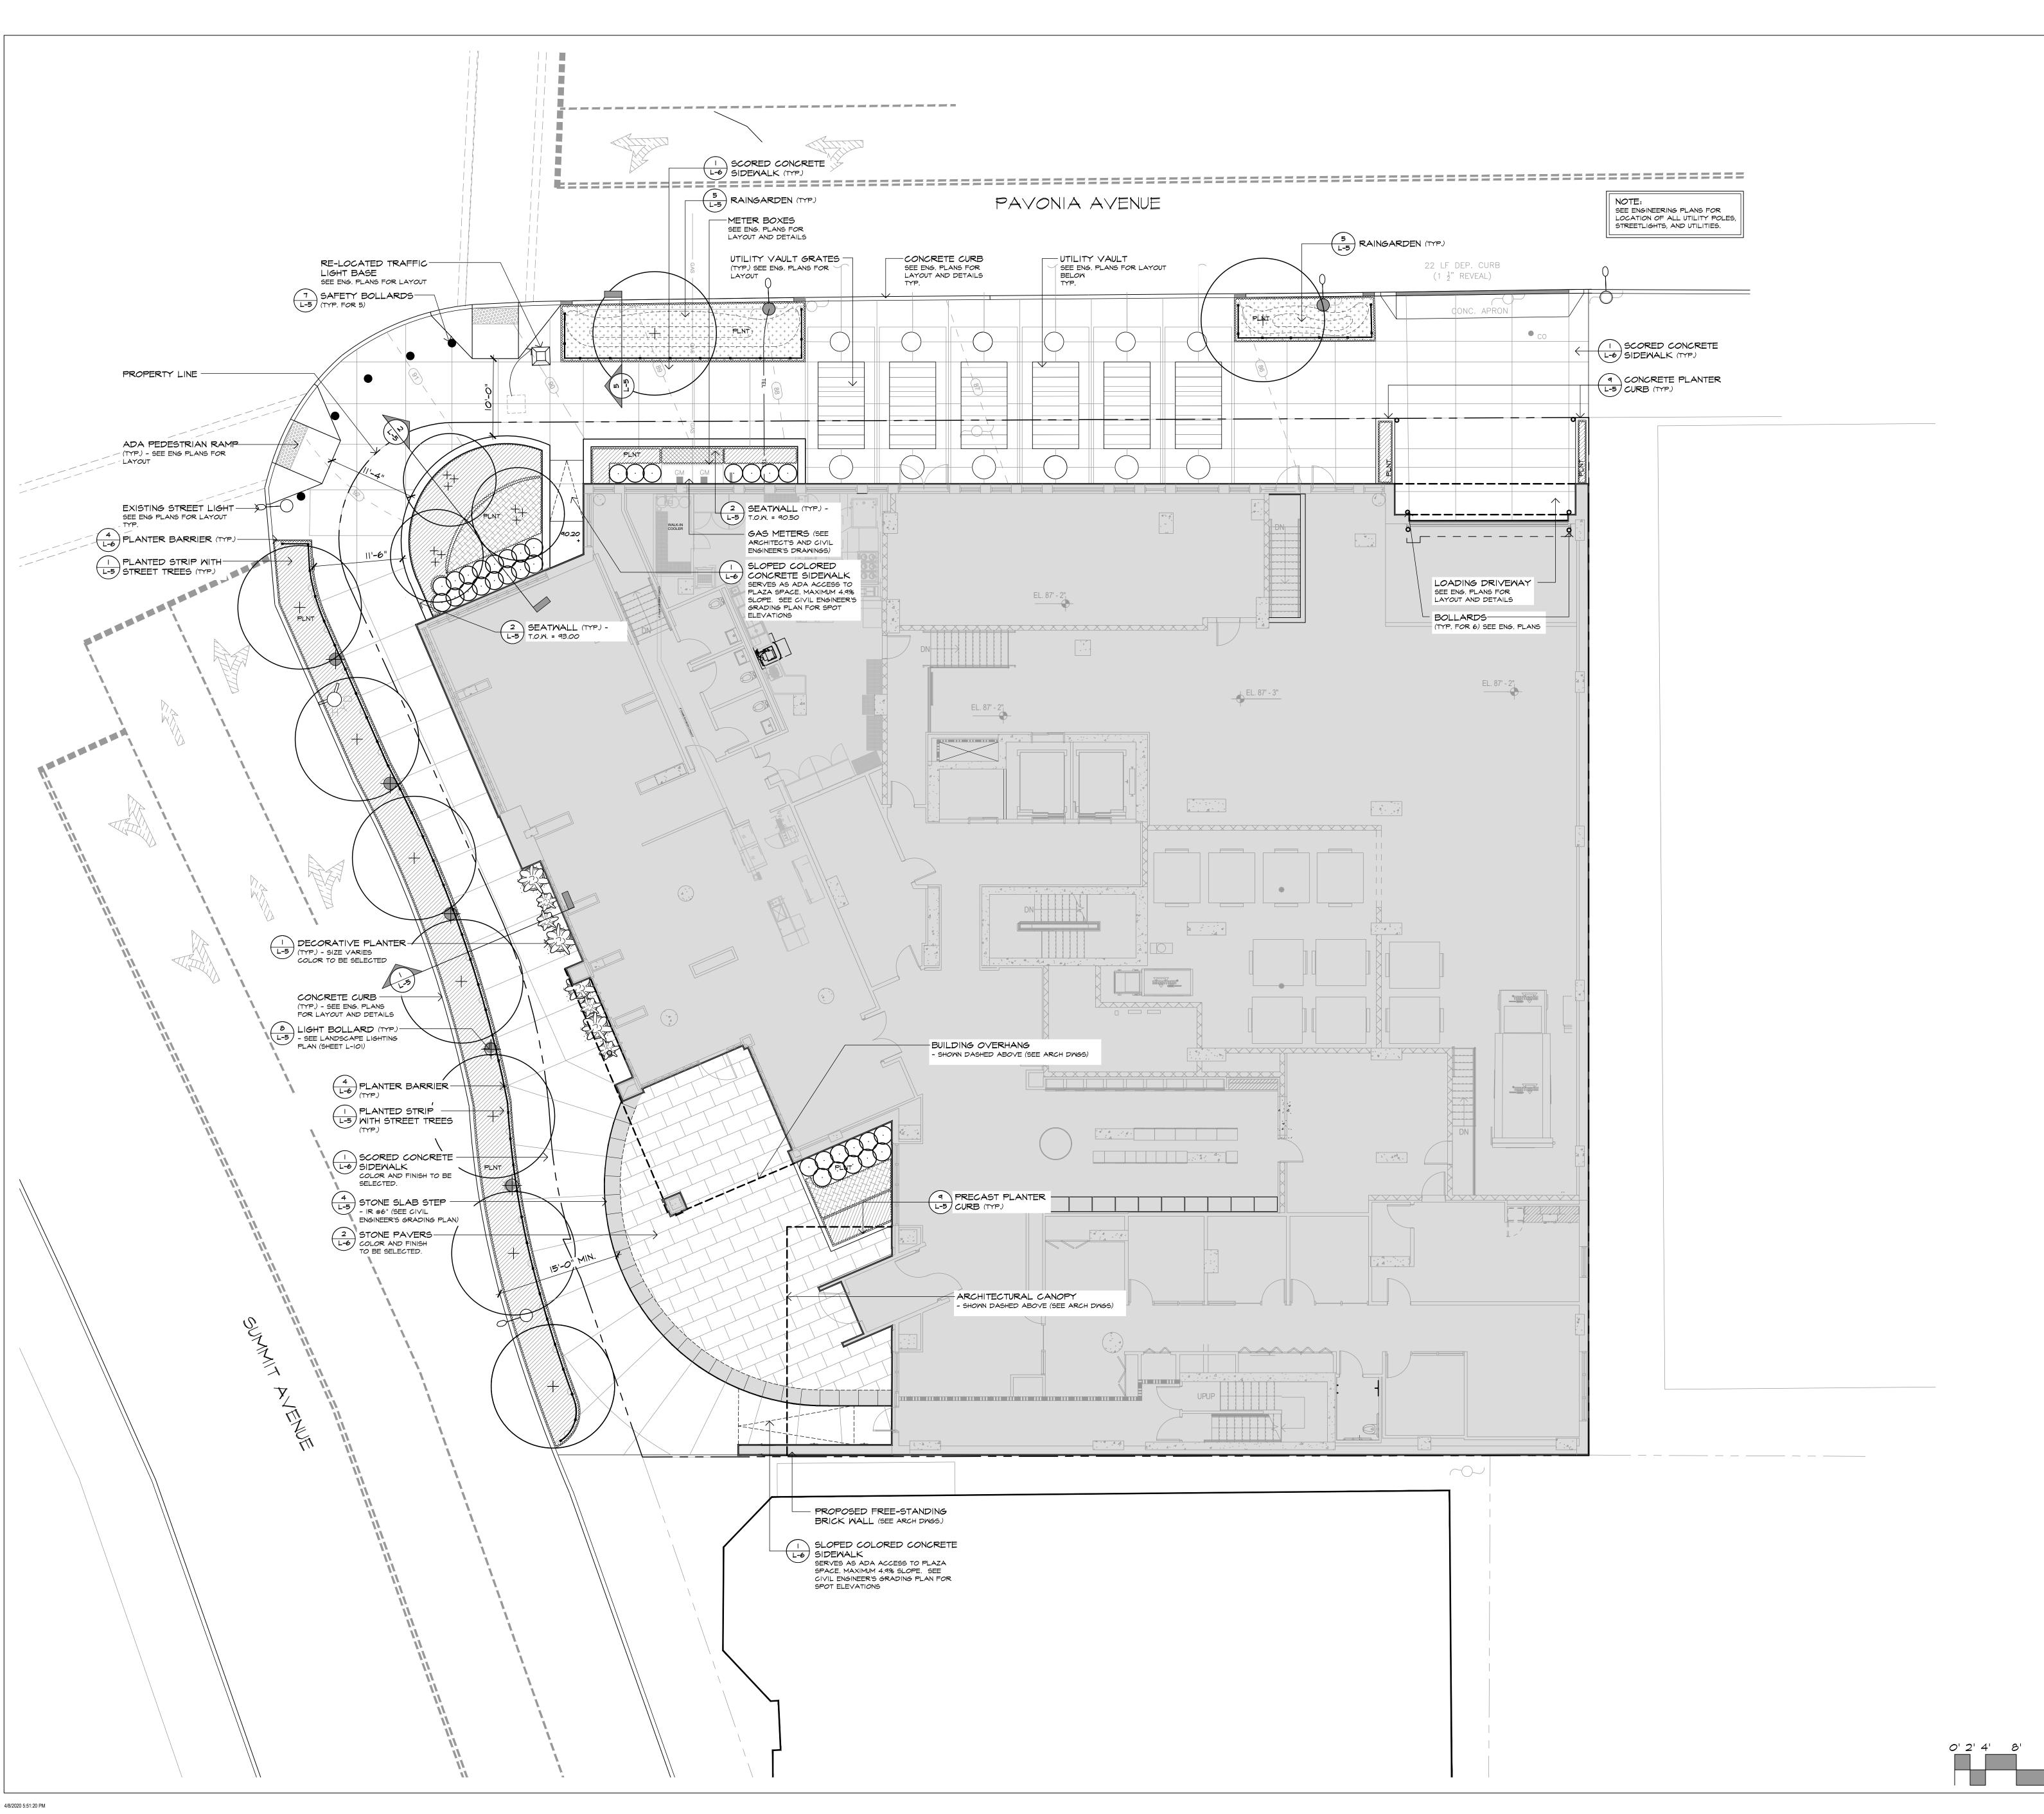



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532 SUMMIT AVE & 571-573-575-577 PAVONIA AVE, JERSEY CITY, NJ

CLIENT: 575 PAVONIA LLC 50 WASHINGTON STREET HOBOKEN, NJ 07030

ARCHITECT:

122 MAIN STREET, MADISON, NJ 07940

DESIGN ARCHITECT: CONCRETE OUDEZIJDS ACHTERBURGWAL 78A

1012 DR AMSTERDAM CIVIL ENGINEER: INSITE ENGINEERING, LLC


1955 ROUTE 34, SUITE 1A WALL, NJ 07719 STRUCTURAL ENGINEER:

DESIMONE CONSULTING ENGINEERS 140 BROADWAY, 25TH FLOOR NEW YORK, NY 10005

MEP ENGINEER: BARONE ENGINEERING ASSOCIATES LLC 100 OAK RIDGE ROAD OAK RIDGE, NJ 07438

LANDSCAPE ARCHITECT: MELILLO + BAUER ASSOCIATES INC 200 UNION AVENUE BRIELLE, NJ 08730

LIGHTING DESIGNER: MAP DESIGN STUDIO 50 BAYARD ST SUITE 8A NEW YORK, NY 10013

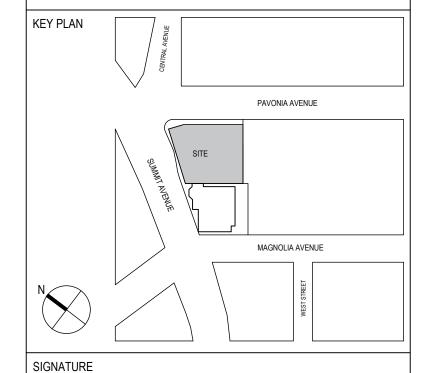

NOT FOR CONSTRUCTION


08/14/2020 PLANNING BOARD SUBMISSION


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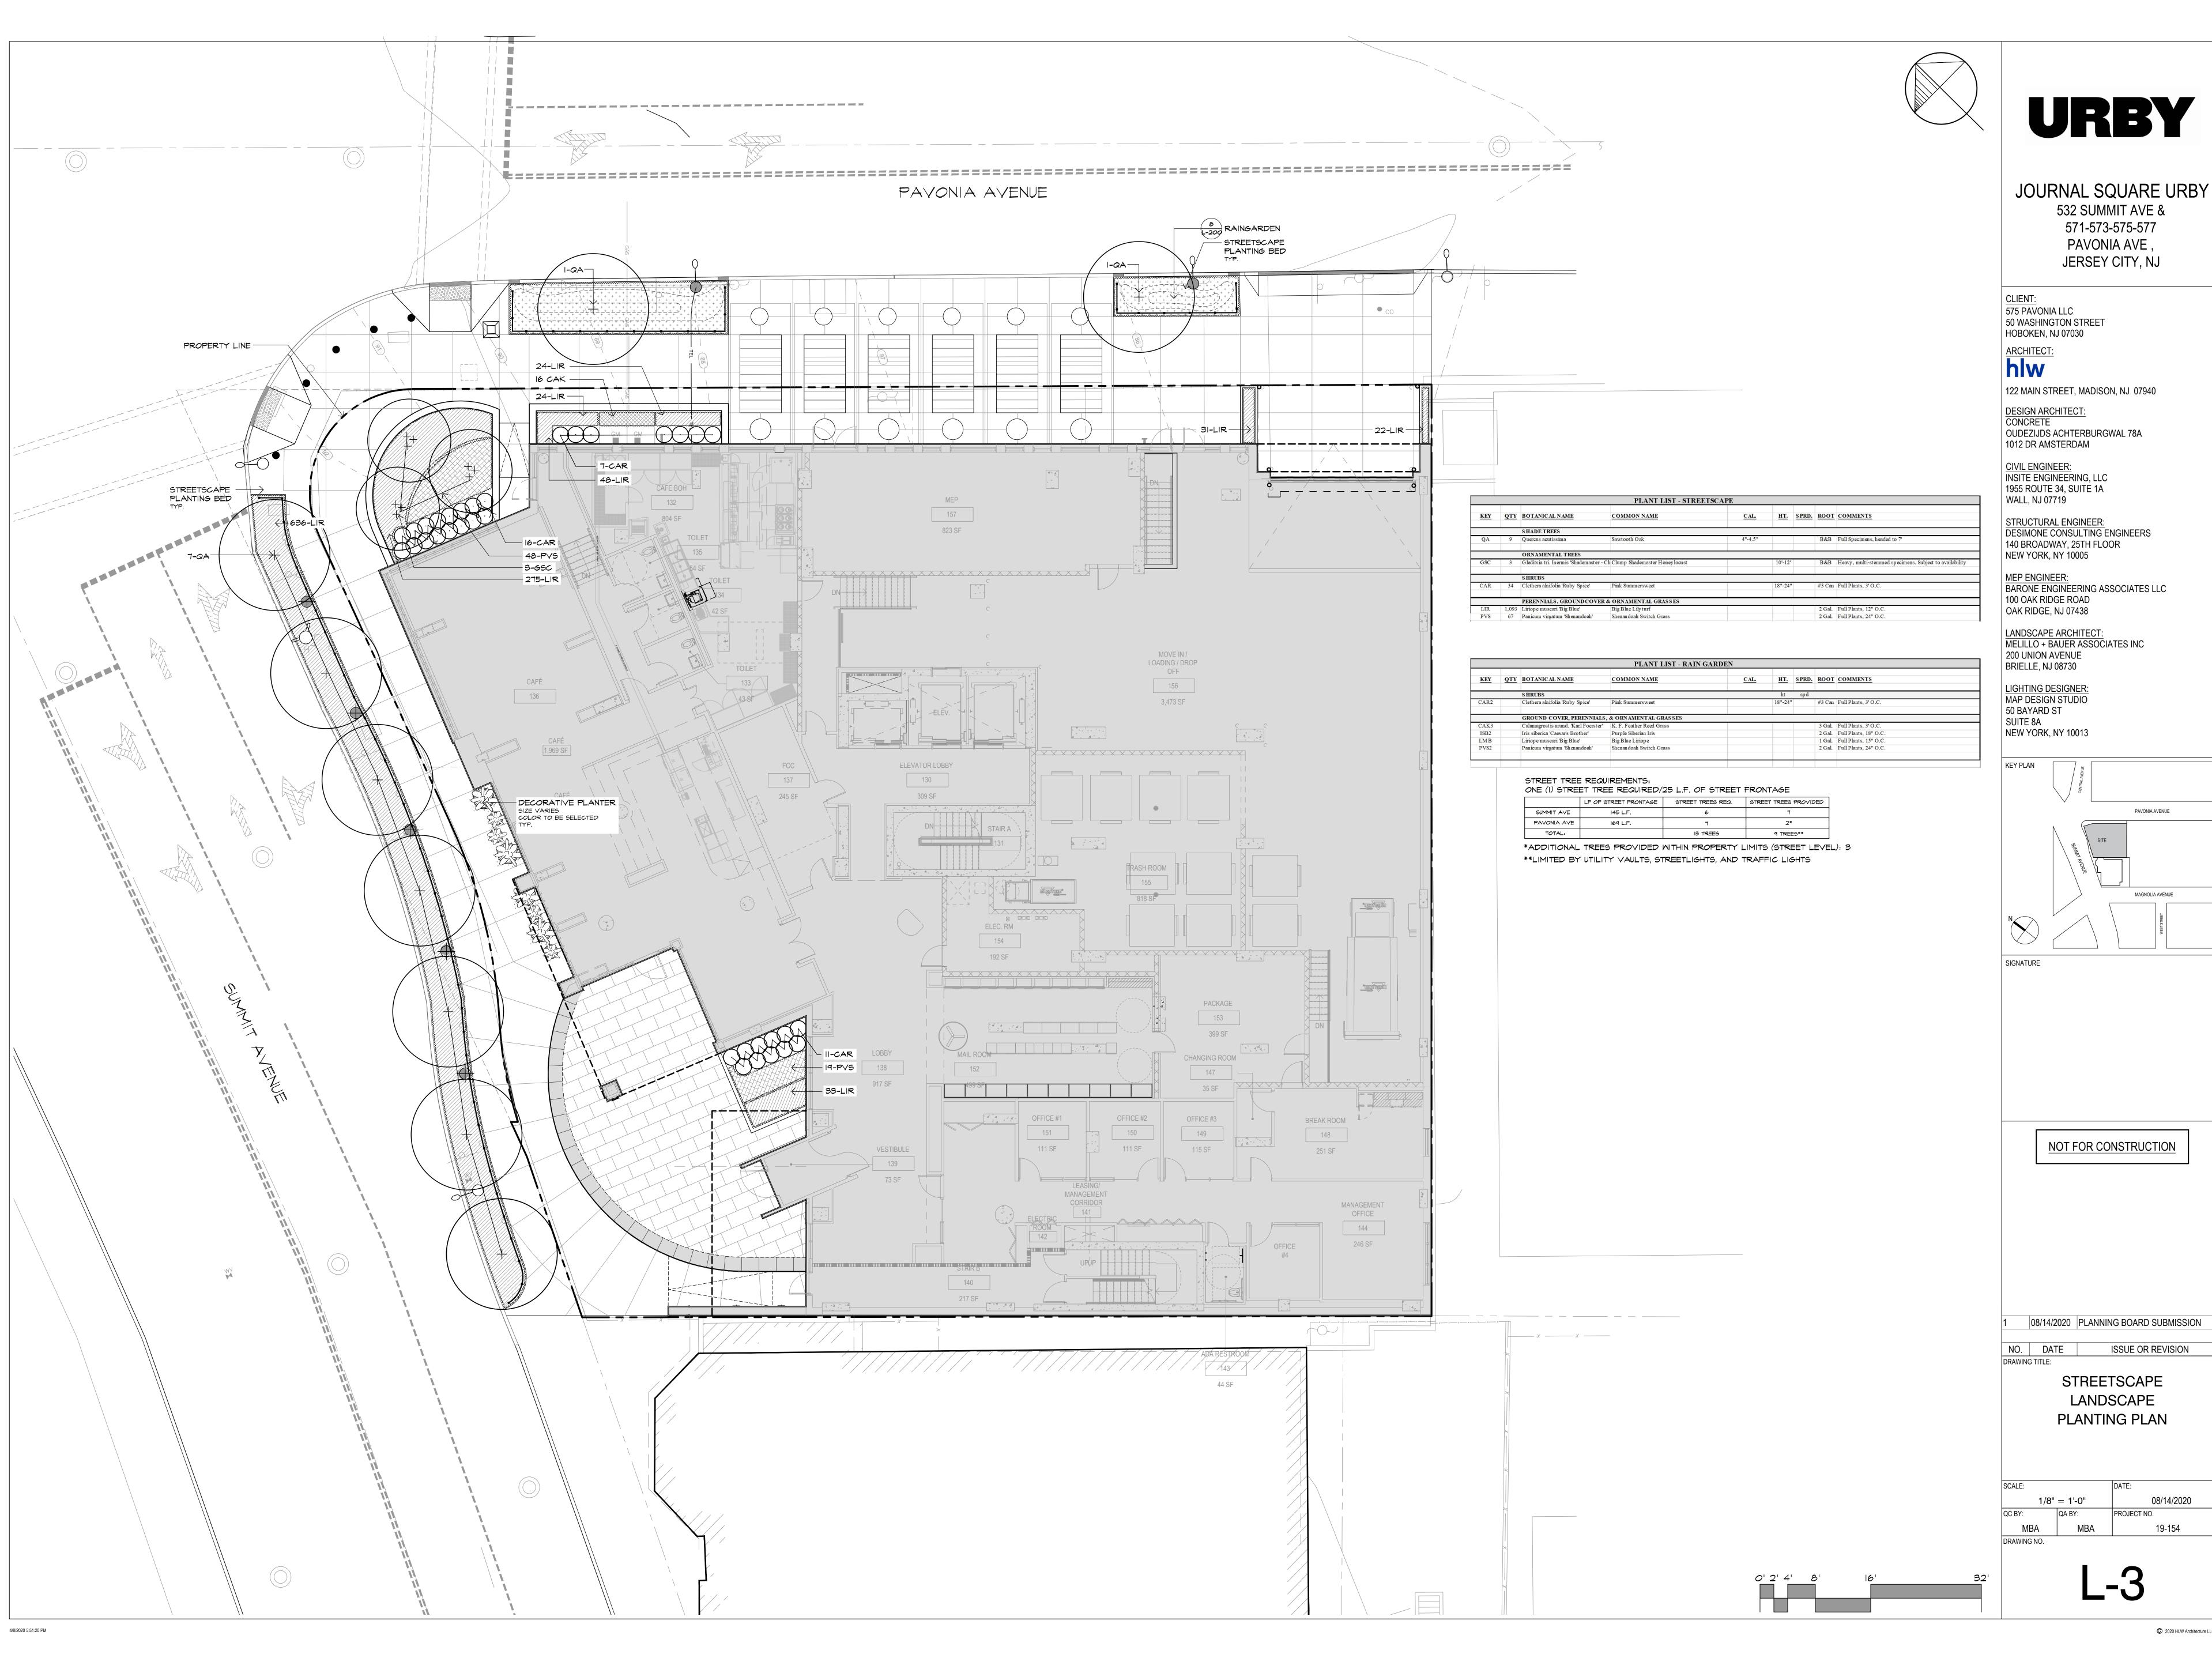
> STREETSCAPE LANDSCAPE MATERIALS PLAN

08/14/2020 MBA 19-154 DRAWING NO.







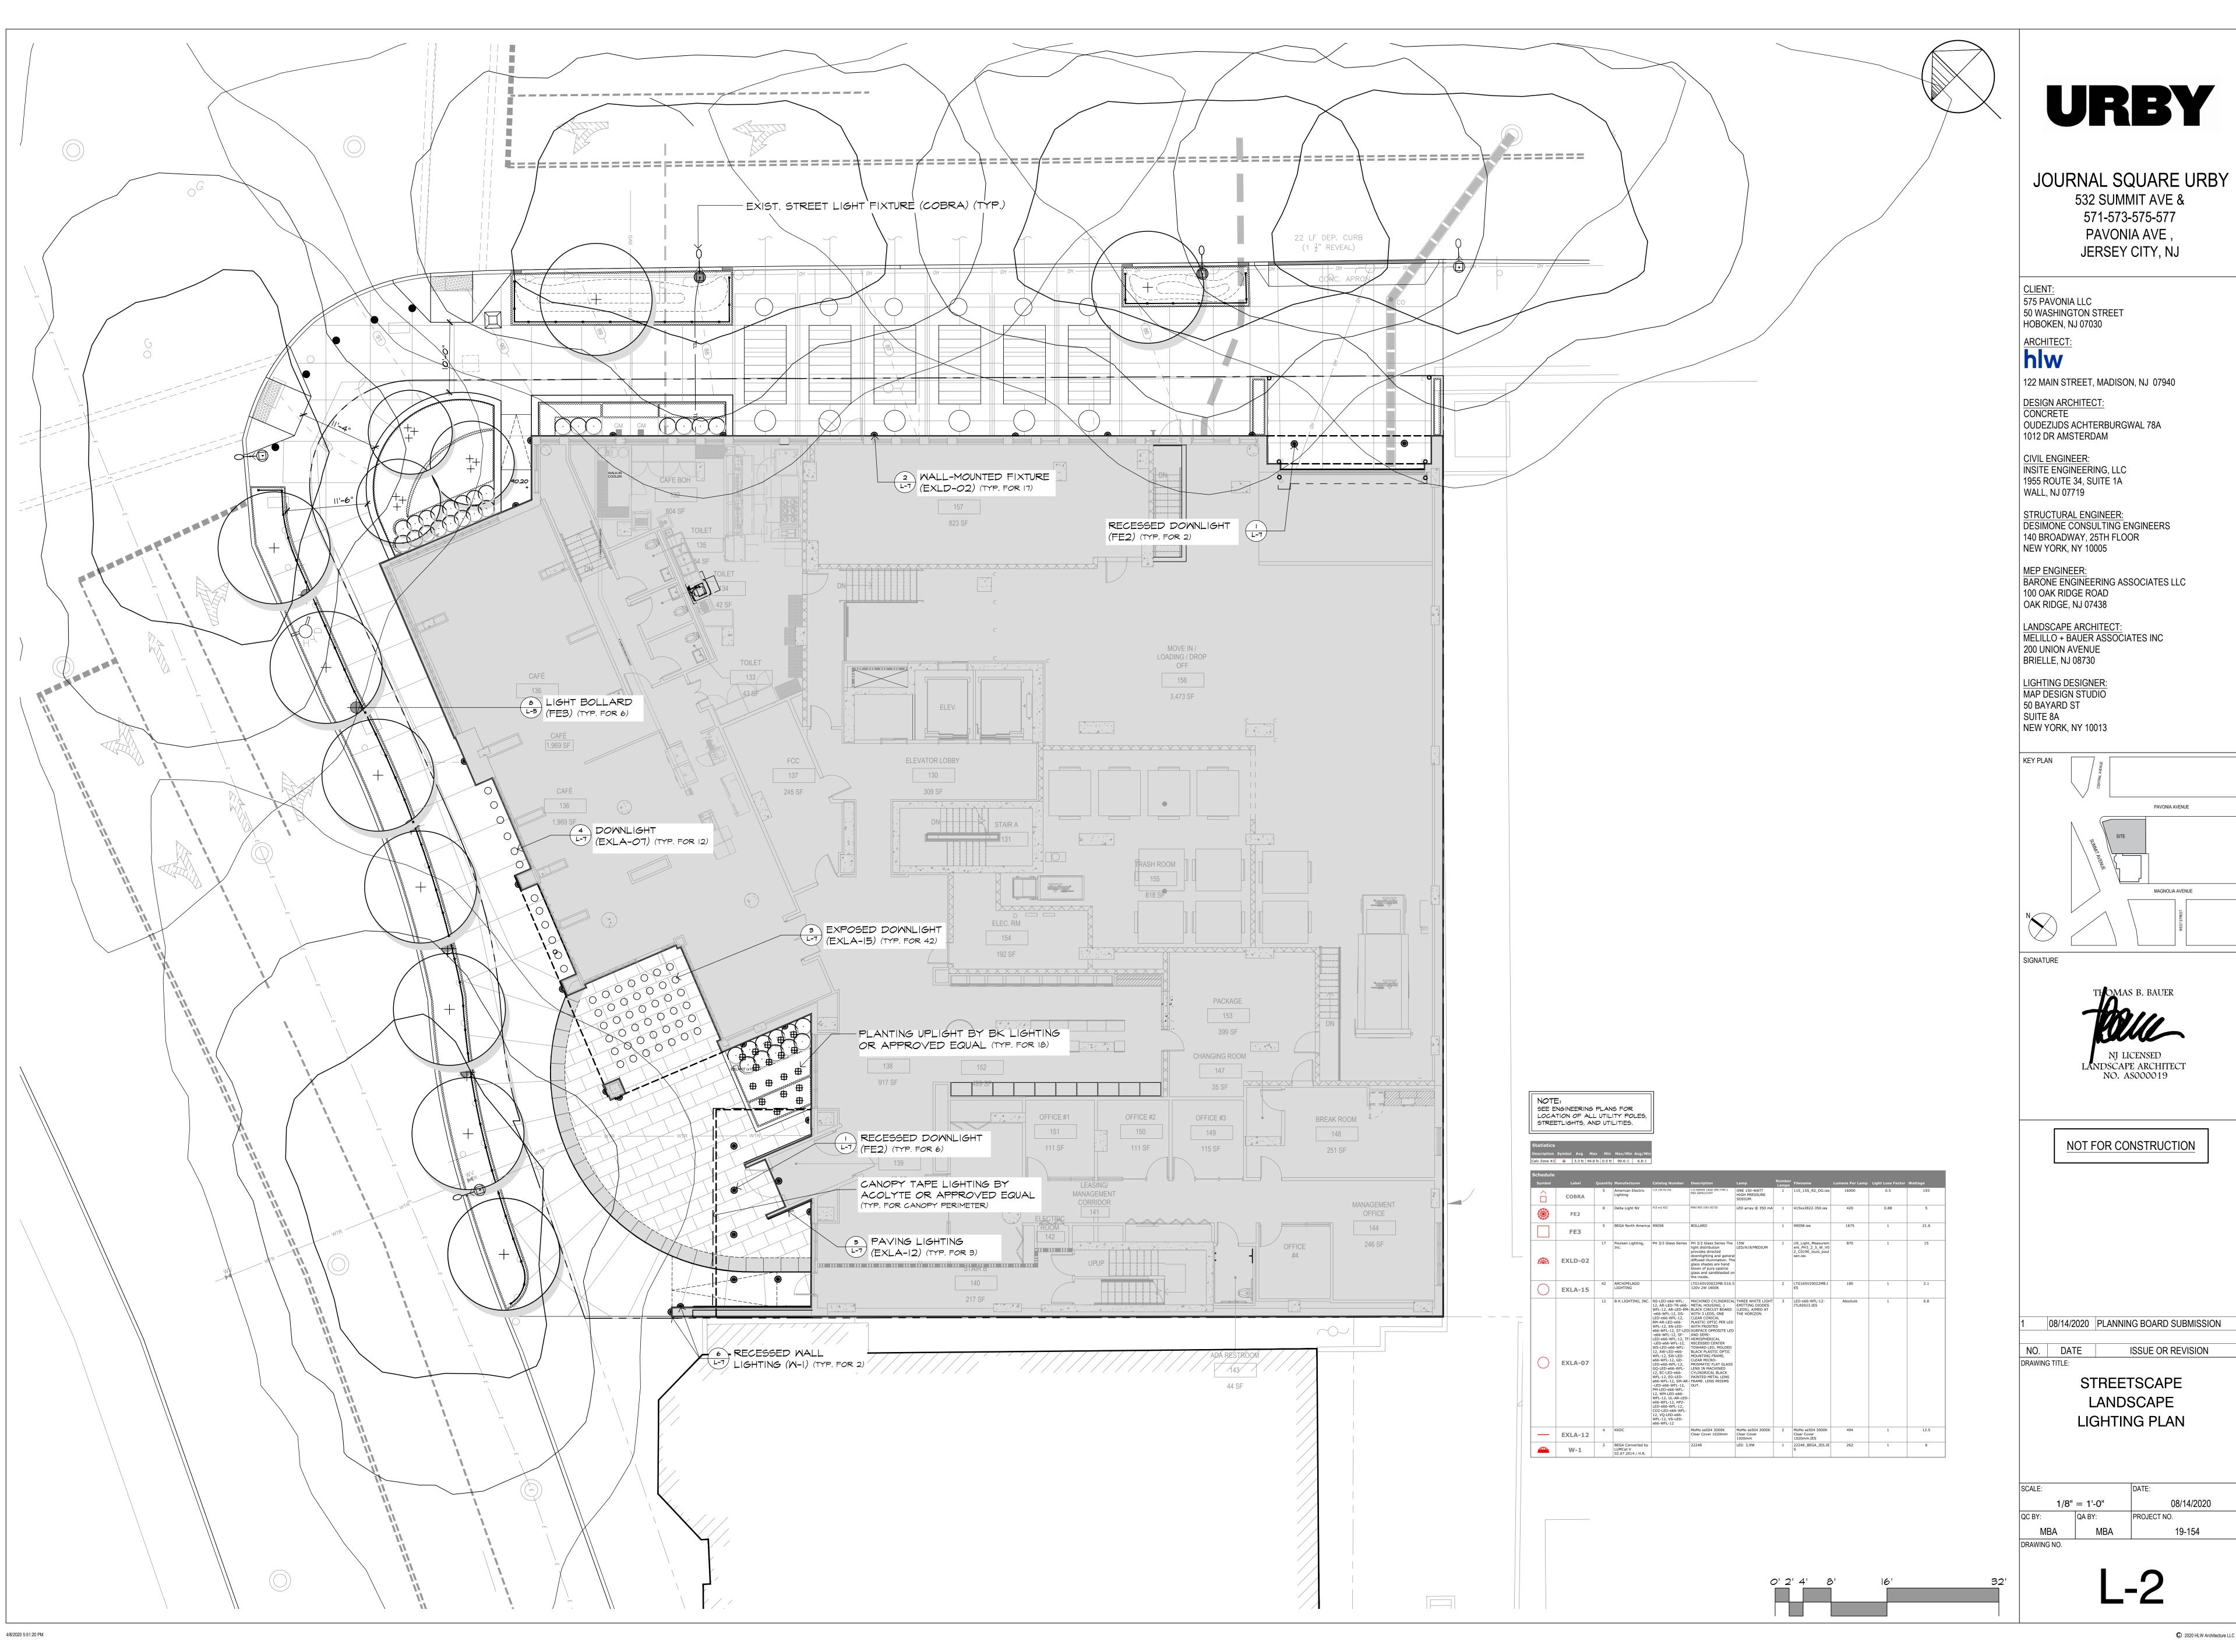

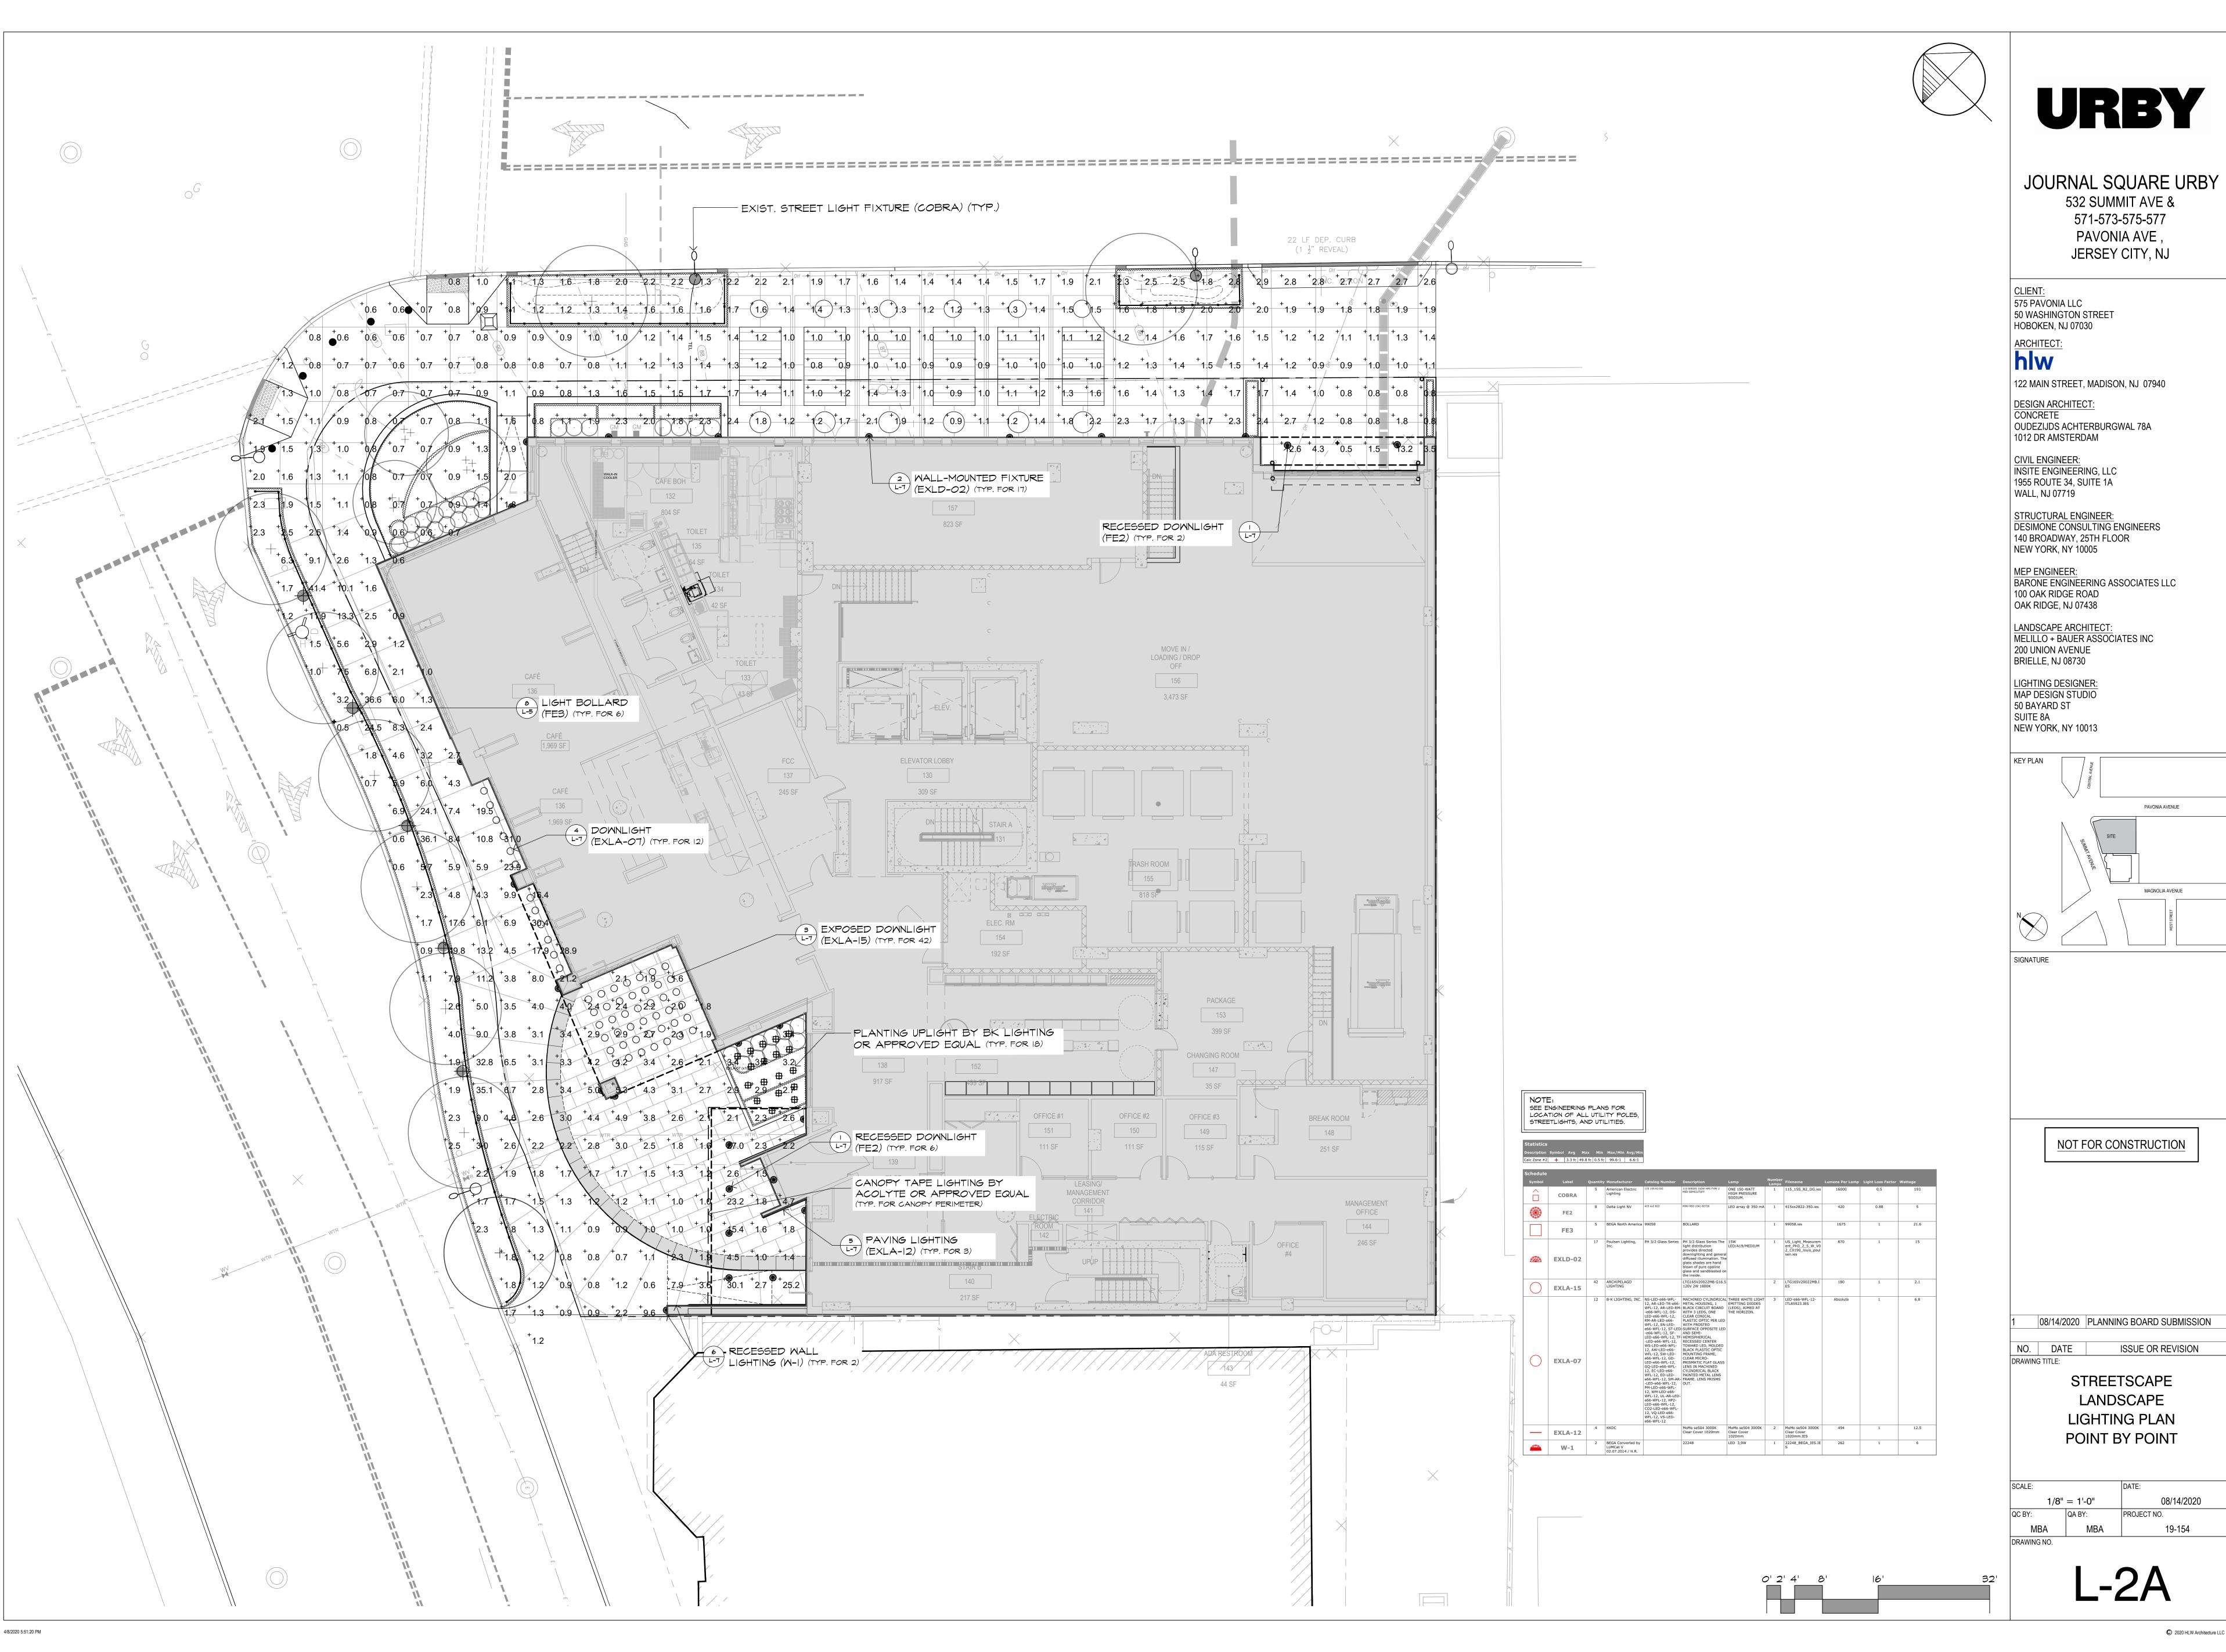

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532 SUMMIT AVE & 571-573-575-577 PAVONIA AVE , JERSEY CITY, NJ

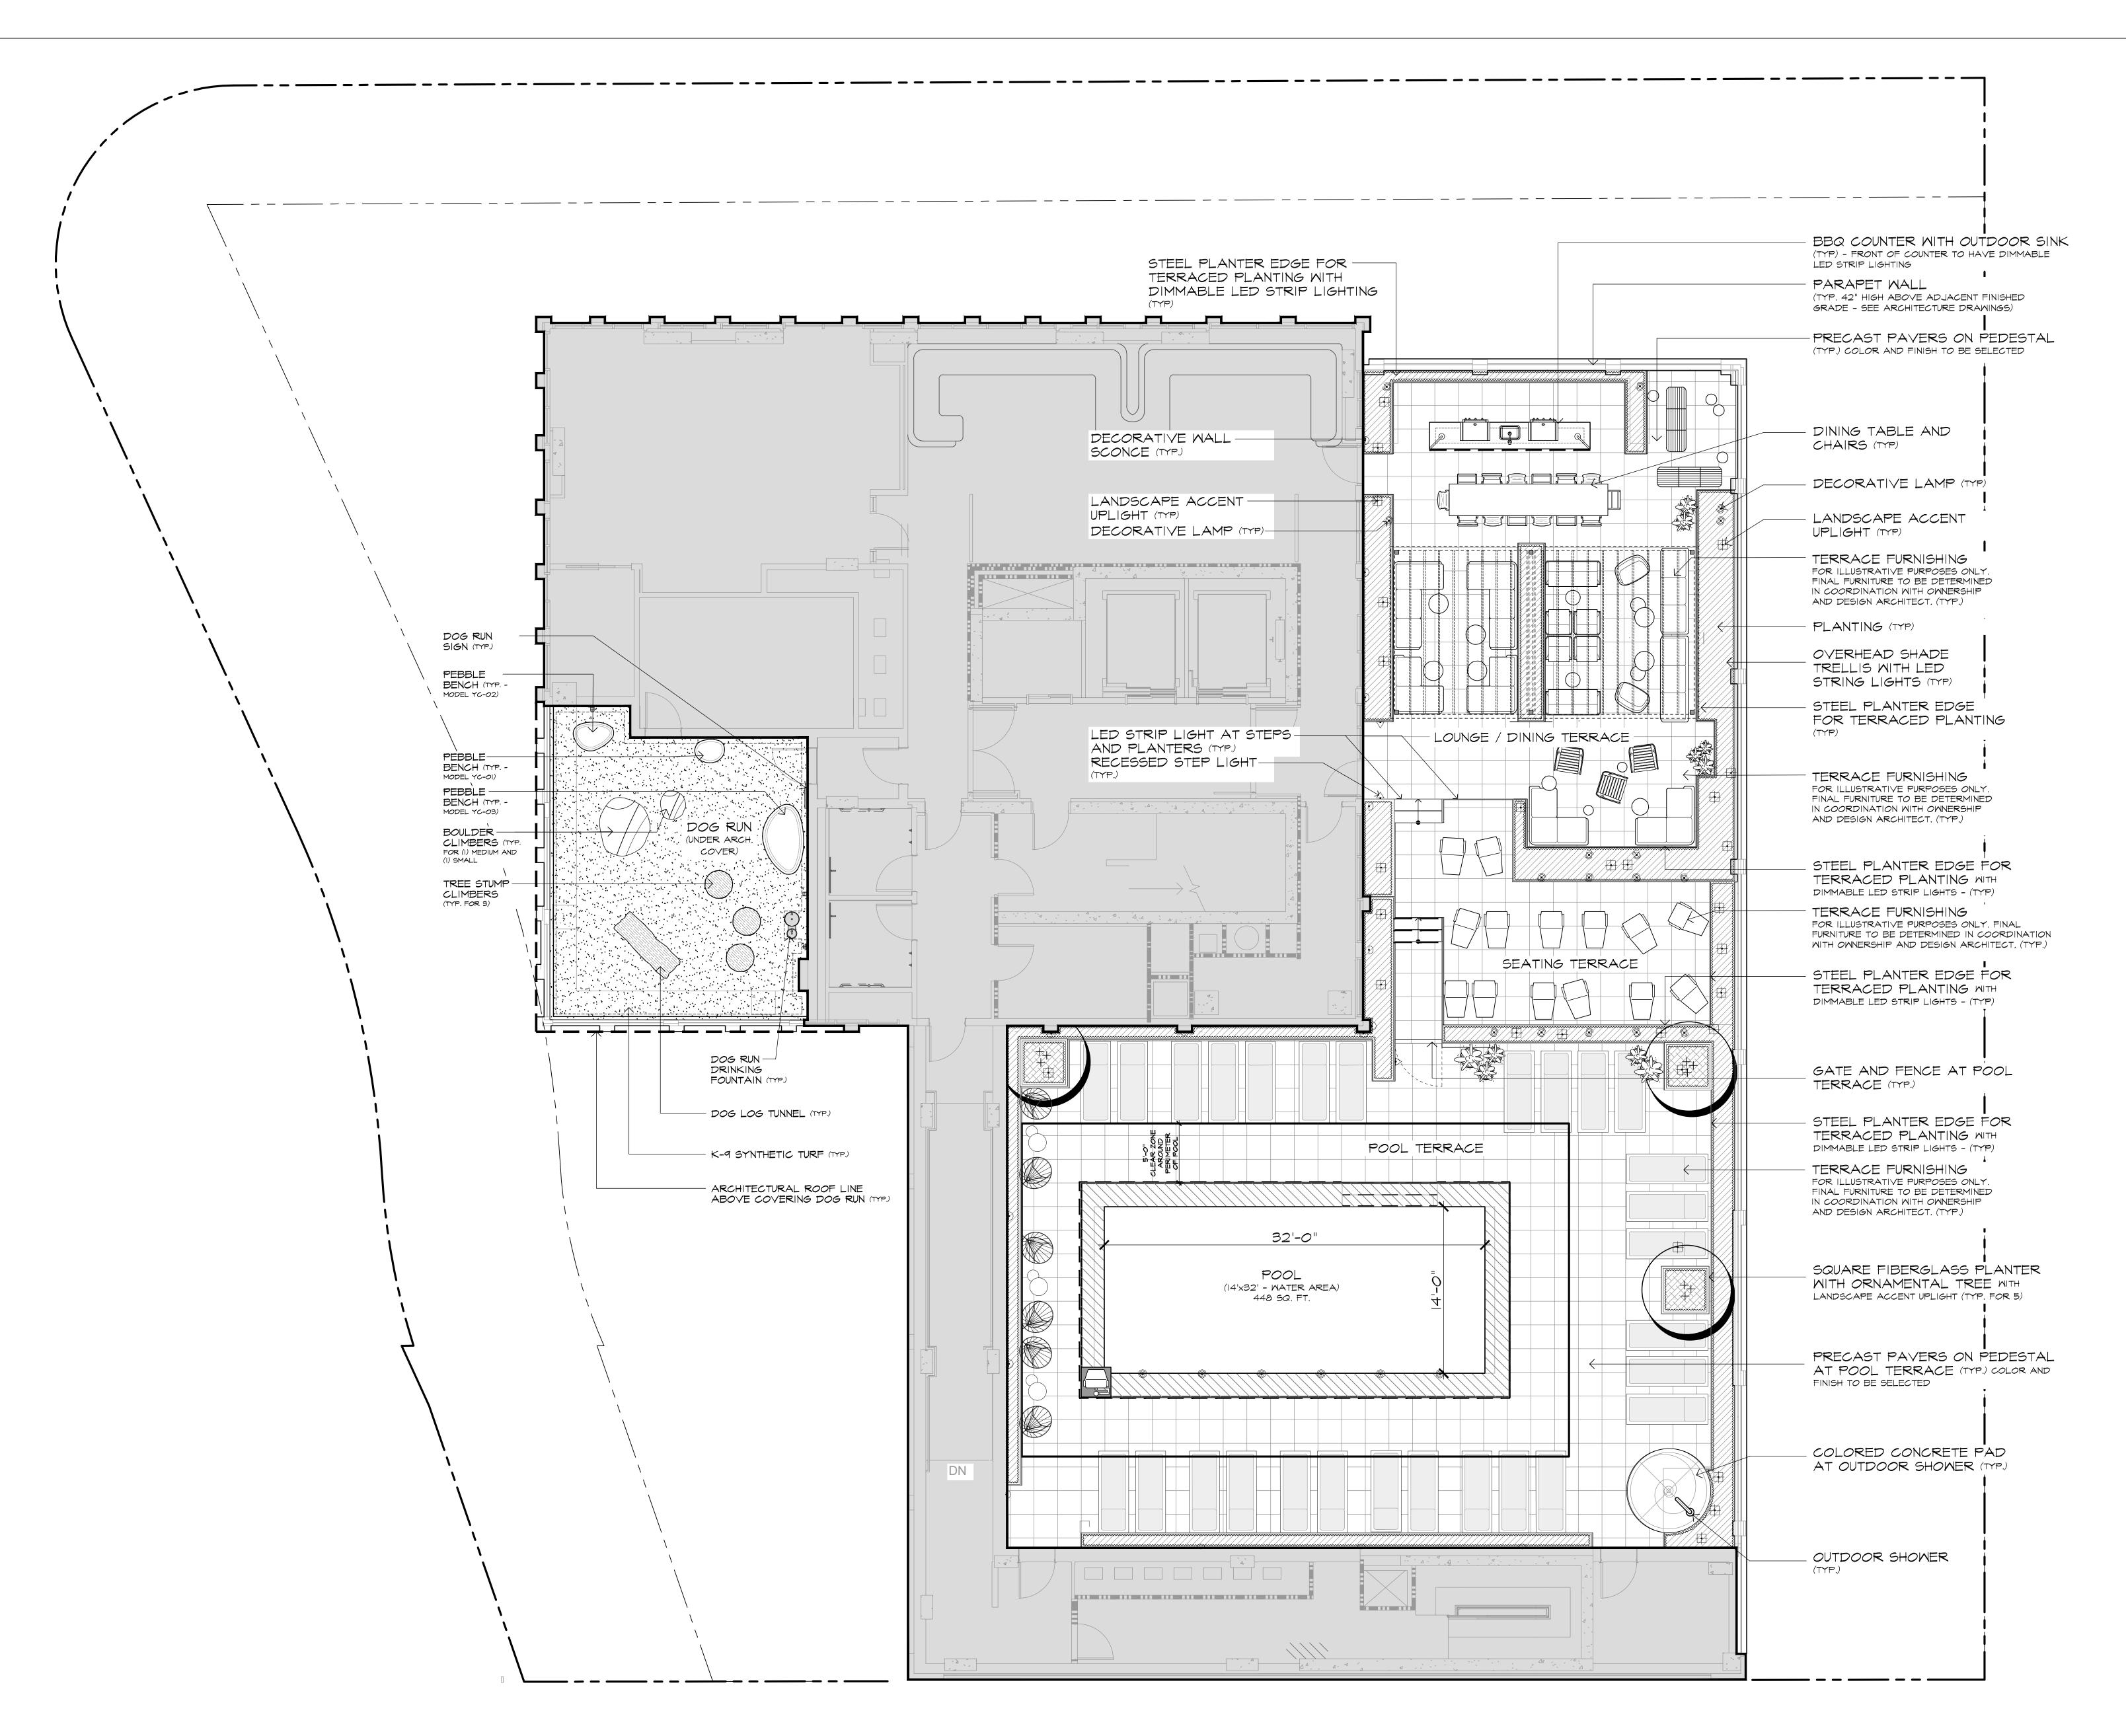CLIENT: 575 PAVONIA LLC 50 WASHINGTON STREET HOBOKEN, NJ 07030

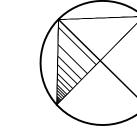ARCHITECT

122 MAIN STREET, MADISON, NJ 07940

DESIGN ARCHITECT: CONCRETE OUDEZIJDS ACHTERBURGWAL 78A

1012 DR AMSTERDAM

CIVIL ENGINEER:

CIVIL ENGINEER: INSITE ENGINEERING, LLC 1955 ROUTE 34, SUITE 1A WALL, NJ 07719


STRUCTURAL ENGINEER:
DESIMONE CONSULTING ENGINEERS
140 BROADWAY, 25TH FLOOR
NEW YORK, NY 10005

MEP ENGINEER: BARONE ENGINEERING ASSOCIATES LLC


BARONE ENGINEERING ASSOCIATES LL 100 OAK RIDGE ROAD OAK RIDGE, NJ 07438

LANDSCAPE ARCHITECT: MELILLO + BAUER ASSOCIATES INC 200 UNION AVENUE BRIELLE, NJ 08730

LIGHTING DESIGNER:
MAP DESIGN STUDIO
50 BAYARD ST
SUITE 8A
NEW YORK, NY 10013

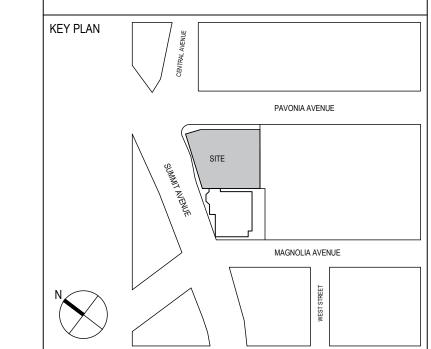

SIGNATURE

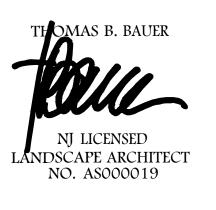

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08/14/2020 PLANNING BOARD SUBMISSION


NO. DATE ISSUE OR REVISION DRAWING TITLE:

ROOF DECK 25th FLOOR LANDSCAPE PLANS

SCALE:		DATE:
3/16" = 1'-0"		08/14/2020
QC BY:	QA BY:	PROJECT NO.
MBA	MBA	19-154
DRAWING NO		



L-4

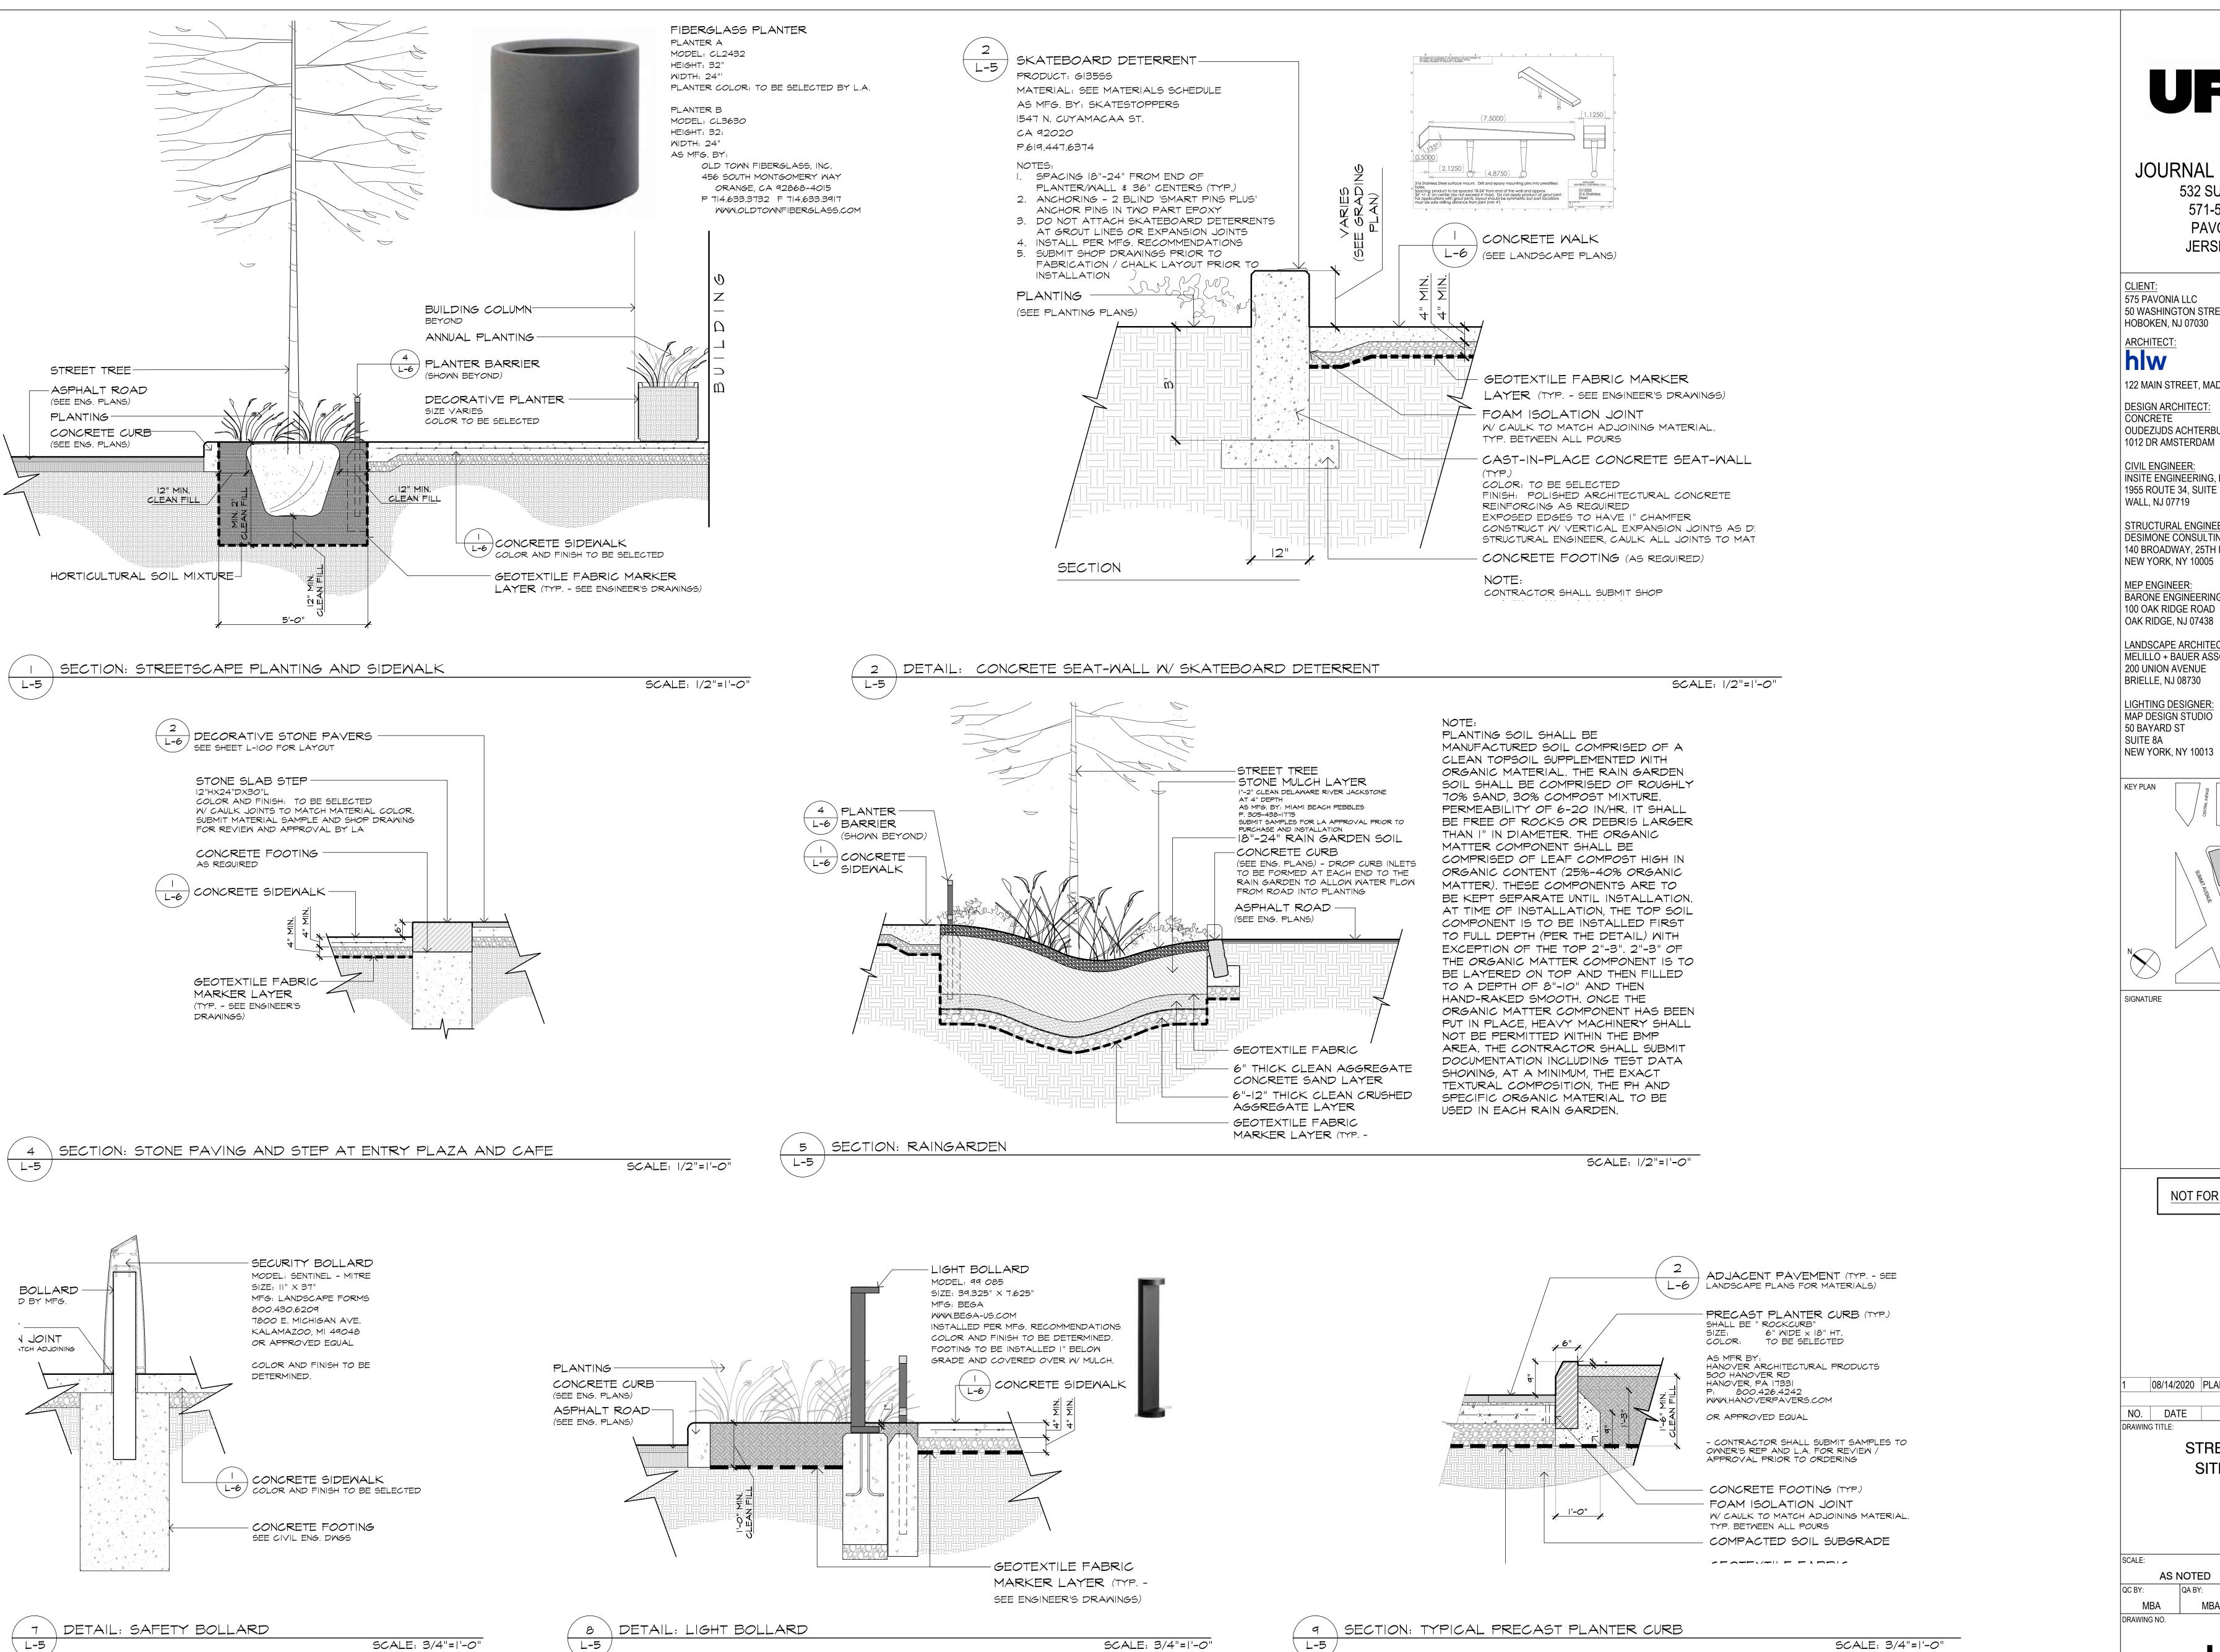

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532 SUMMIT AVE & 571-573-575-577 PAVONIA AVE, JERSEY CITY, NJ

575 PAVONIA LLC 50 WASHINGTON STREET HOBOKEN, NJ 07030

122 MAIN STREET, MADISON, NJ 07940

DESIGN ARCHITECT: OUDEZIJDS ACHTERBURGWAL 78A

CIVIL ENGINEER: INSITE ENGINEERING, LLC


1955 ROUTE 34, SUITE 1A WALL, NJ 07719

STRUCTURAL ENGINEER: DESIMONE CONSULTING ENGINEERS 140 BROADWAY, 25TH FLOOR NEW YORK, NY 10005

MEP ENGINEER: BARONE ENGINEERING ASSOCIATES LLC 100 OAK RIDGE ROAD

LANDSCAPE ARCHITECT MELILLO + BAUER ASSOCIATES INC 200 UNION AVENUE

LIGHTING DESIGNER: MAP DESIGN STUDIO 50 BAYARD ST NEW YORK, NY 10013

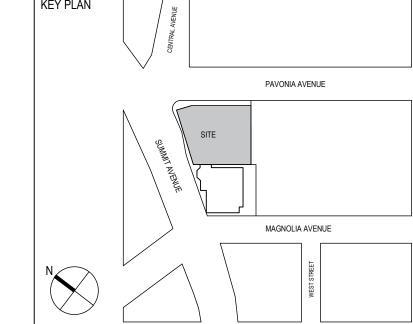

NOT FOR CONSTRUCTION

08/14/2020 PLANNING BOARD SUBMISSION


NO. DATE ISSUE OR REVISION

> STREETSCAPE SITE DETAIL

08/14/2020 **AS NOTED** IQA BY: PROJECT NO. MBA 19-154

L-5

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INSTALL PER MFG. RECOMMENDATIONS AND SPECIFICATIONS

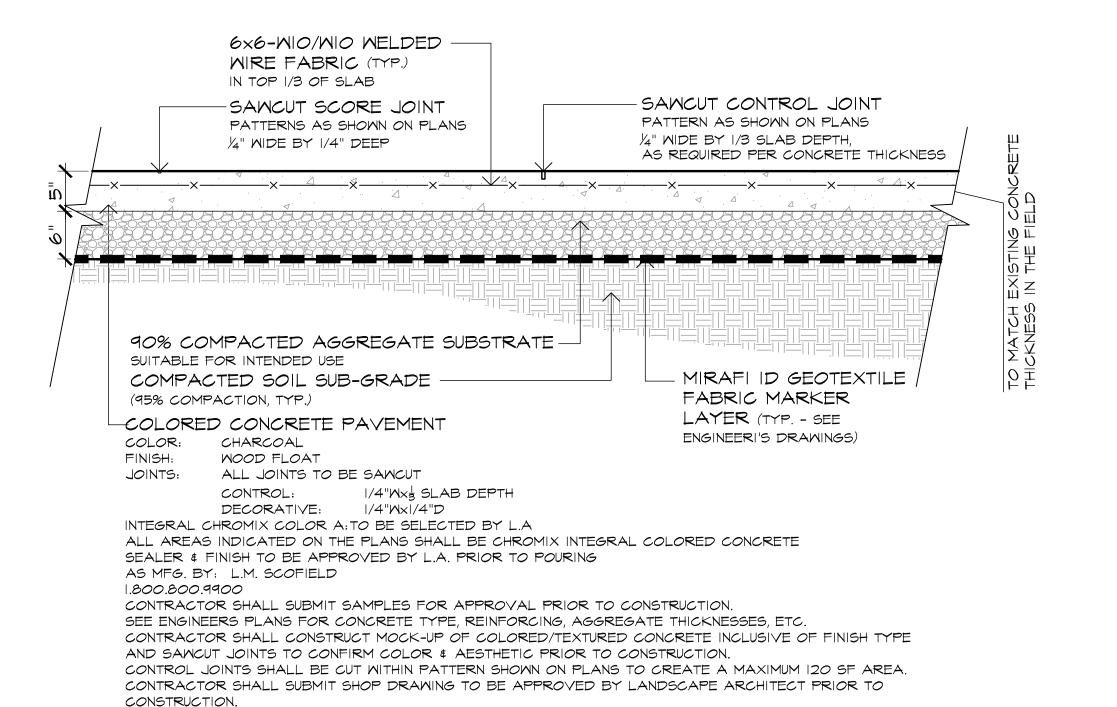
L-6 /

PLAN

SECTION: COLORED CONCRETE PAVEMENT

ELEVATION: PLANTER BARRIER SLOPED END SECTION

DETAIL: PLANTED TREE PIT WITH TREE PIT BARRIER

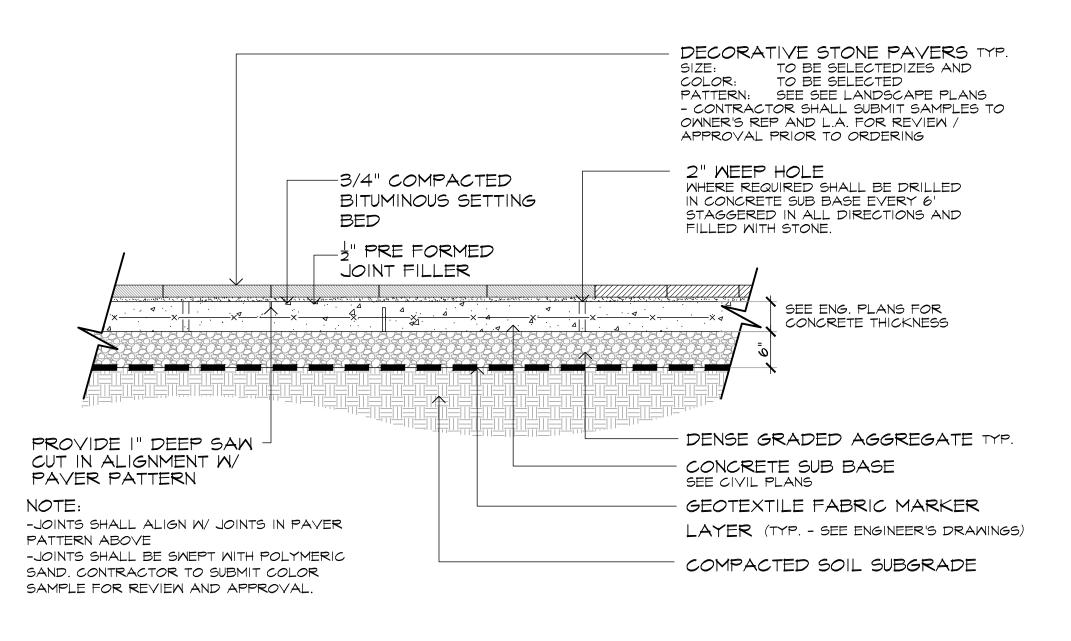

(SHOWN DASHED - MIN. 2' EMBEDMENT

SECTION

SCALE: 3/4"=1'-0"


INTO CONCRETE FOOTING)


8" DIA SONOTUBE FOOTING TYP. FOR

ALL POSTS

SCALE: 3/4"=1'-0"

SECTION: TYPICAL PRECAST DECORATIVE PAVER TREATMENT

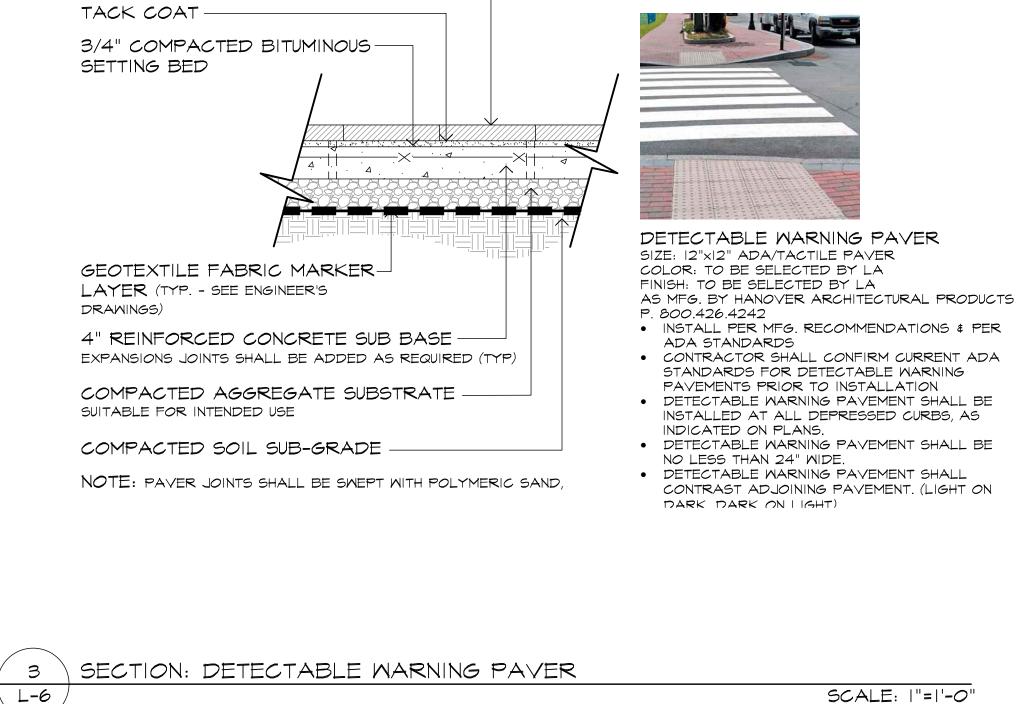

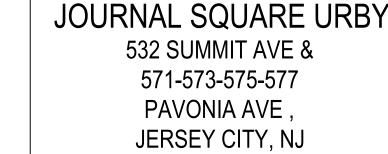

CLIENT: 575 PAVONIA LLC 50 WASHINGTON STREET HOBOKEN, NJ 07030

SCALE: |"=1'-0'

SCALE: |"=|'-0"

ARCHITECT

122 MAIN STREET, MADISON, NJ 07940

DESIGN ARCHITECT CONCRETE OUDEZIJDS ACHTERBURGWAL 78A

1955 ROUTE 34, SUITE 1A

1012 DR AMSTERDAM **CIVIL ENGINEER:** INSITE ENGINEERING, LLC


WALL, NJ 07719 STRUCTURAL ENGINEER:

DESIMONE CONSULTING ENGINEERS 140 BROADWAY, 25TH FLOOR NEW YORK, NY 10005

MEP ENGINEER: BARONE ENGINEERING ASSOCIATES LLC 100 OAK RIDGE ROAD OAK RIDGE, NJ 07438

LANDSCAPE ARCHITECT MELILLO + BAUER ASSOCIATES INC 200 UNION AVENUE BRIELLE, NJ 08730

LIGHTING DESIGNER: MAP DESIGN STUDIO 50 BAYARD ST SUITE 8A NEW YORK, NY 10013

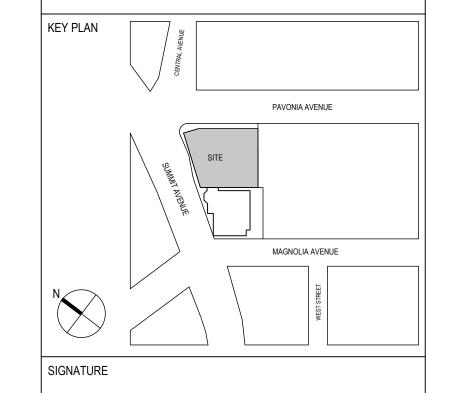


NOT FOR CONSTRUCTION

08/14/2020 PLANNING BOARD SUBMISSION

NO. DATE ISSUE OR REVISION DRAWING TITLE:


> STREETSCAPE SITE DETAIL

08/14/2020 **AS NOTED** IQA BY: PROJECT NO. MBA MBA 19-154 DRAWING NO.

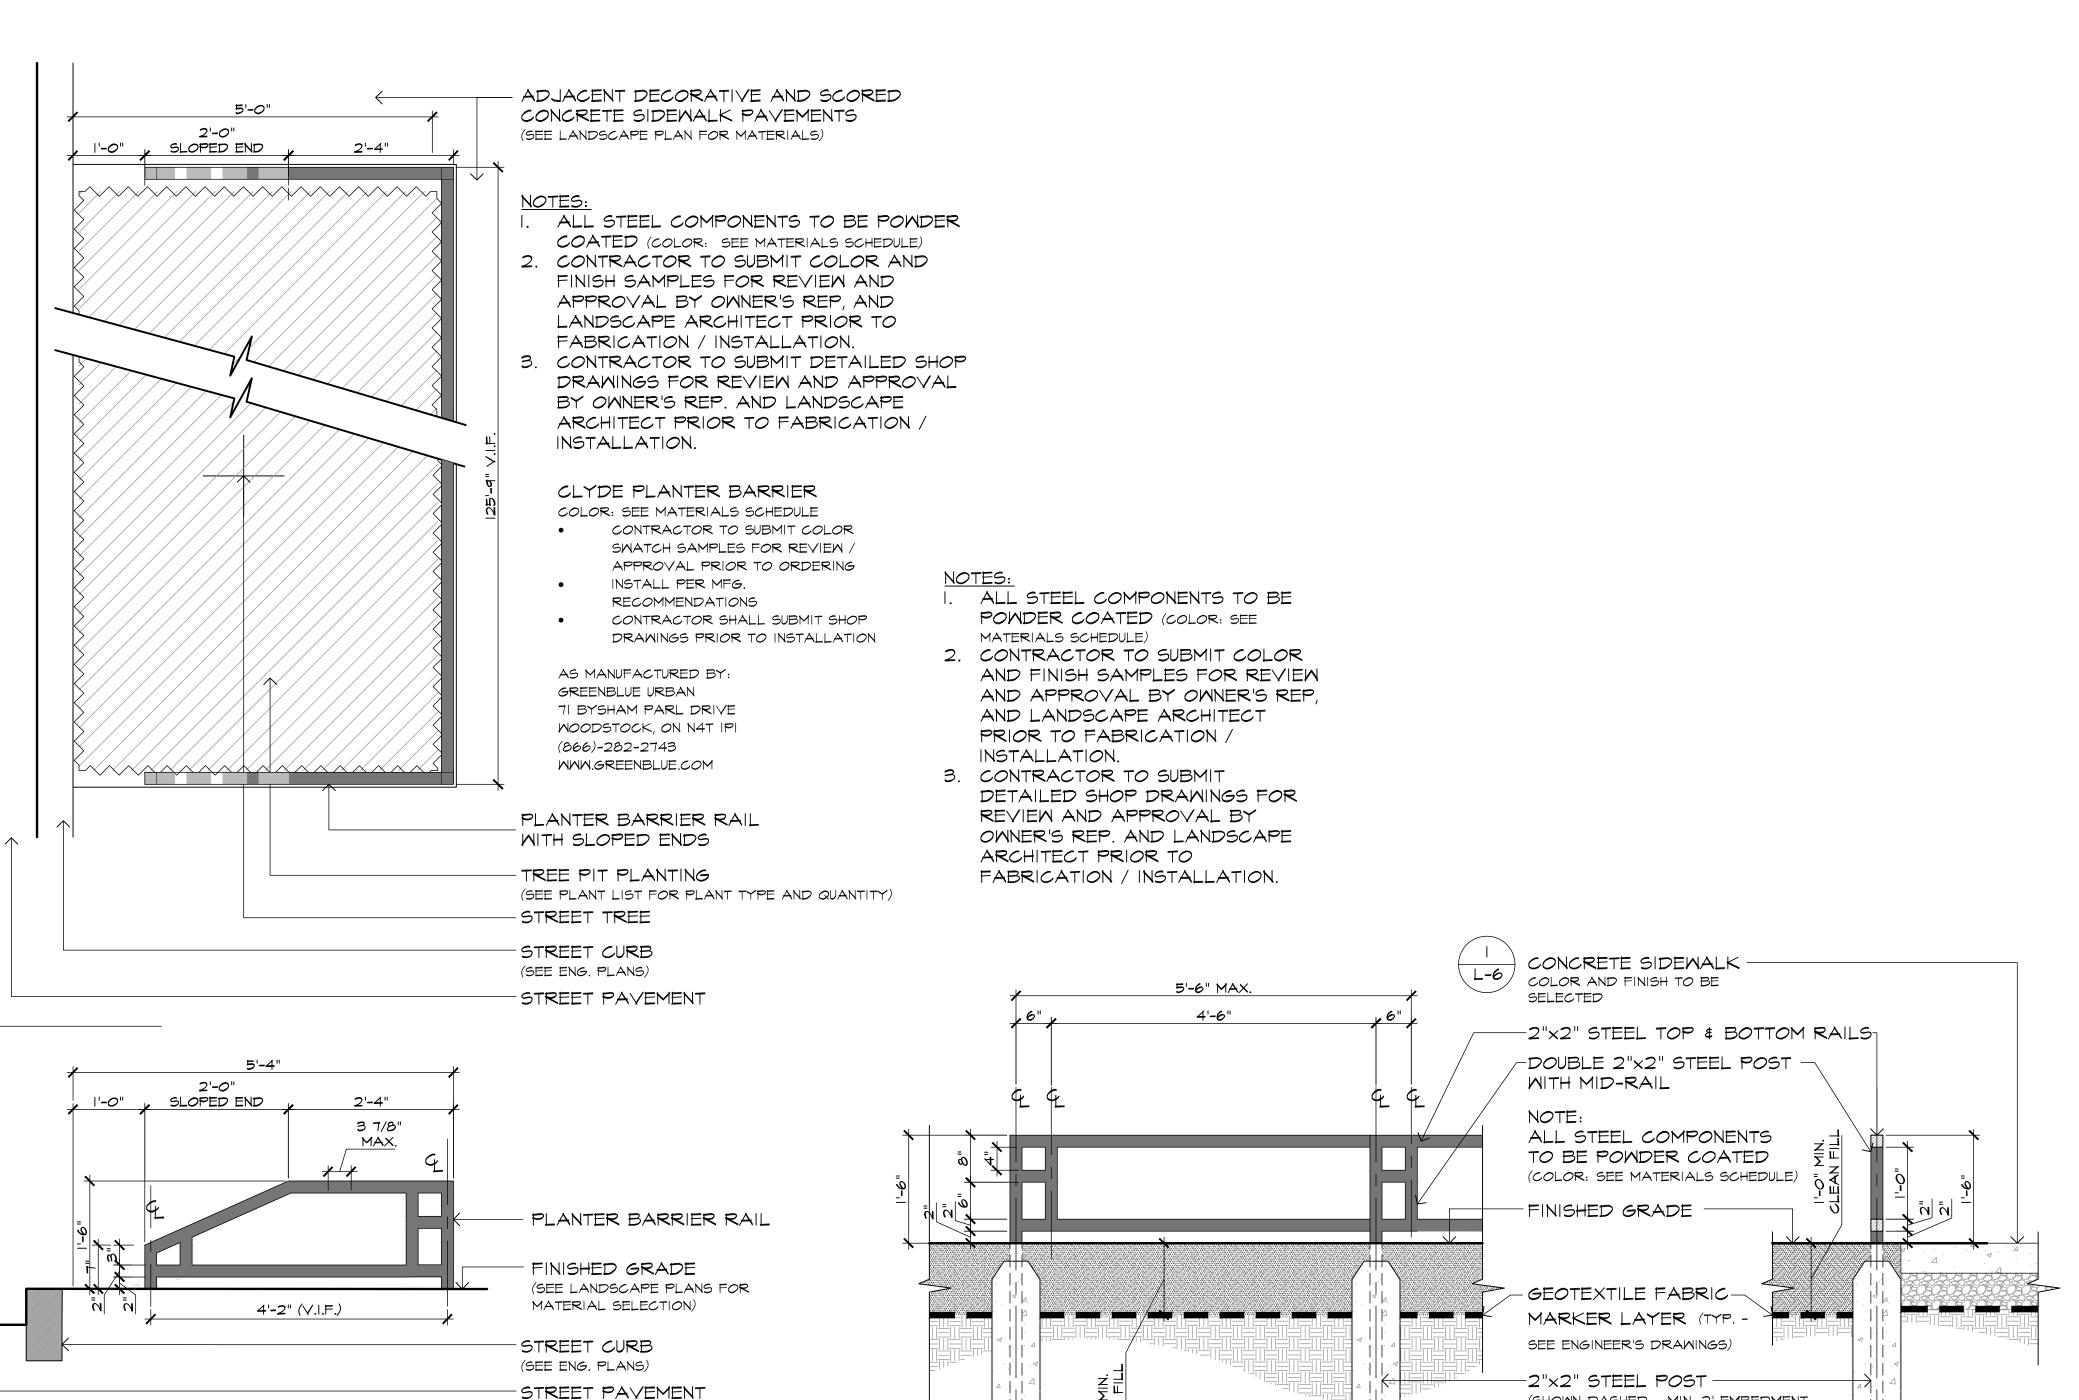

ELEVATION

SCALE: |"=1'-0"

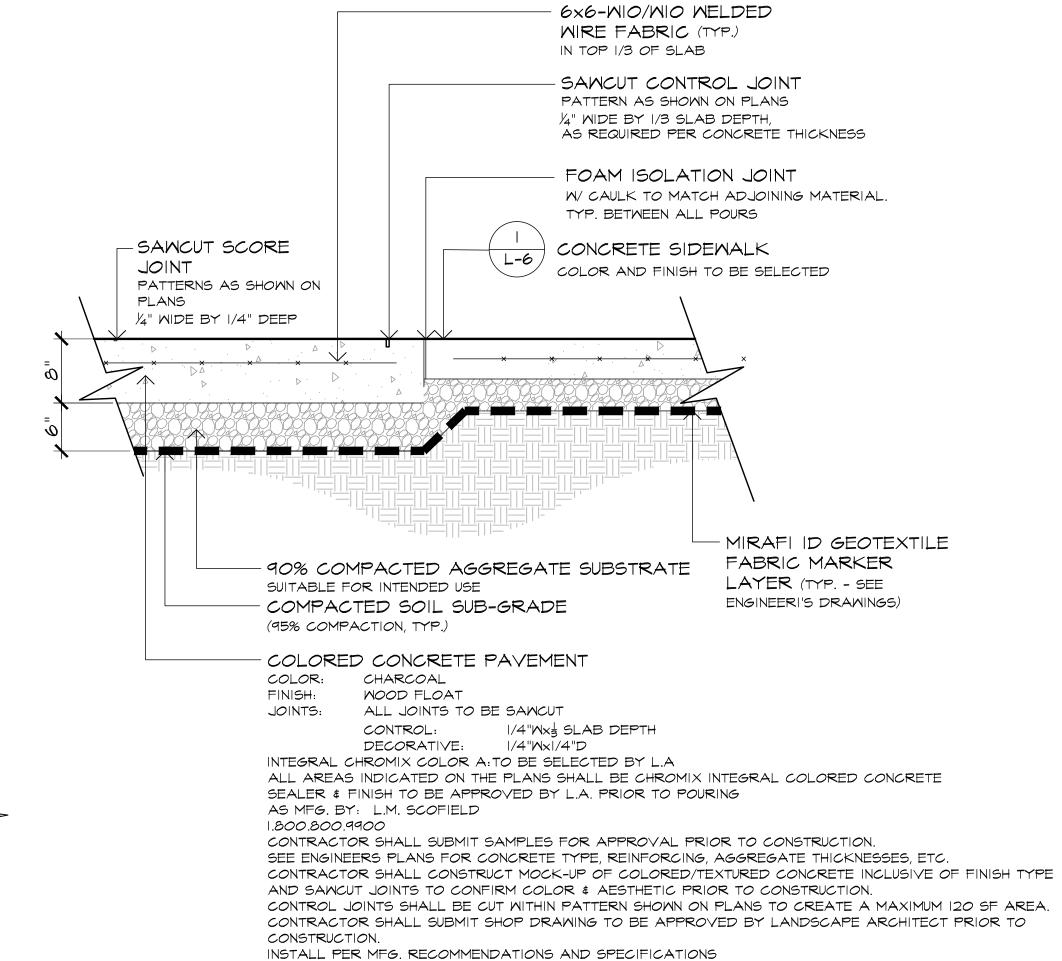

SECTION: VEHICULAR CONCRETE SIDEMALK

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532 SUMMIT AVE & 571-573-575-577 PAVONIA AVE, JERSEY CITY, NJ

CLIENT: 575 PAVONIA LLC 50 WASHINGTON STREET HOBOKEN, NJ 07030

ARCHITECT

122 MAIN STREET, MADISON, NJ 07940

DESIGN ARCHITECT: CONCRETE OUDEZIJDS ACHTERBURGWAL 78A 1012 DR AMSTERDAM

CIVIL ENGINEER: INSITE ENGINEERING, LLC 1955 ROUTE 34, SUITE 1A WALL, NJ 07719


STRUCTURAL ENGINEER: DESIMONE CONSULTING ENGINEERS 140 BROADWAY, 25TH FLOOR NEW YORK, NY 10005

MEP ENGINEER: BARONE ENGINEERING ASSOCIATES LLC 100 OAK RIDGE ROAD OAK RIDGE, NJ 07438

LANDSCAPE ARCHITECT: MELILLO + BAUER ASSOCIATES INC 200 UNION AVENUE BRIELLE, NJ 08730

LIGHTING DESIGNER: MAP DESIGN STUDIO 50 BAYARD ST SUITE 8A NEW YORK, NY 10013

KEY PLAN

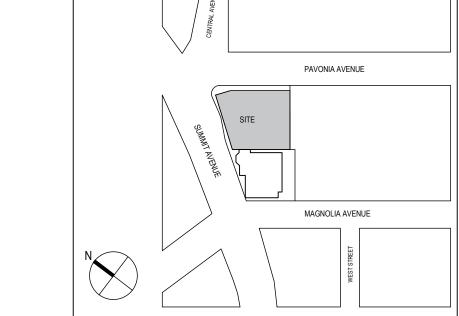

SIGNATURE

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08/14/2020 PLANNING BOARD SUBMISSION ISSUE OR REVISION NO. DATE

DRAWING TITLE: STREETSCAPE

SITE DETAIL

AS NOTED

2"-11/16 Ø82mm 0"-20"

DETAIL: CANOPY DOWNLIGHTS FE2 - CUT SHEET

RECESSED CANOPY FIXTURE MODEL: MINI REO (OK) LAMP: 5M FINISH: TO BE SELECTED BY LANDSCAPE ARCHITECT

- CONTRACTOR SHALL SUBMIT COLOR SAMPLES TO OWNER'S REP FOR REVIEW & APPROVAL PRIOR TO ORDERING - CONTRACTOR SHALL PROVIDE SHOP DRAWINGS FOR CUSTOM UNITS PRIOR TO FABRICATION - CUSTOM DIMENSIONS SHALL BE VERIFIED IN FIELD PRIOR TO FABRICATION

AS MFG BY (OR APPROVED EQUAL): DELTA LIGHTING 255 FIFTH AVENUE NEW YORK, NY 10016 (646) 973-3284

MMM.DELTALIGHT.US INSTALL PER MFG. RECOMMENDATIONS



FACADE LIGHTING FIXTURE MODEL: PH 3-3 1/2 WALL LAMP: I5M FINISH: BLACK

- CONTRACTOR SHALL SUBMIT COLOR SAMPLES TO OWNER'S REP FOR REVIEW & APPROVAL PRIOR TO ORDERING - CONTRACTOR SHALL PROVIDE SHOP DRAWINGS FOR CUSTOM UNITS PRIOR TO FABRICATION - CUSTOM DIMENSIONS SHALL BE VERIFIED IN FIELD PRIOR TO FABRICATION

AS MFG BY (OR APPROVED EQUAL): LOUIS POULSEN 3260 MERIDIAN PARKWAY FORT LAUDERDALE, FL 33331 (954) 349-2525 MMM.LOUISPOULSEN.COM

INSTALL PER MFG. RECOMMENDATIONS

2 \ DETAIL: FACADE LIGHTING EXLD-02 - CUT SHEET L-7 / N.T.S.

"B/E" CAP

CANOPY-MOUNTED FIXTURE MODEL: DELTA STAR LAMP: 7W, 4K, WIDE FLOOD FINISH: TO BE SELECTED BY LANDSCAPE ARCHITECT

- CONTRACTOR SHALL SUBMIT COLOR SAMPLES TO OWNER'S REP FOR REVIEW & APPROVAL PRIOR TO ORDERING - CONTRACTOR SHALL PROVIDE SHOP DRAWINGS FOR CUSTOM UNITS PRIOR TO FABRICATION - CUSTOM DIMENSIONS SHALL BE VERIFIED IN FIELD PRIOR TO FABRICATION - FIXTURE TO BE MOUNTED TO CEILING -APPROPRIATE HARDWARE AND ACCESSORIES SHALL BE PROVIDED

AS MFG BY (OR APPROVED EQUAL): B-K LIGHTING 40429 BRICKYARD DRIVE MADERA, CA 93636 (559) 438-58*00* MMM.BKLIGHTING.COM INSTALL PER MFG. RECOMMENDATIONS

IN GROUND LIGHTING FIXTURE MODEL: MoMo, 504 SERIES LAMP: 12.5M, 2500K, MID OUTPUT FINISH: TO BE SELECTED BY LANDSCAPE ARCHITECT

- CONTRACTOR SHALL SUBMIT COLOR SAMPLES TO OWNER'S REP FOR REVIEW & APPROVAL PRIOR TO ORDERING - CONTRACTOR SHALL PROVIDE SHOP DRAWINGS FOR CUSTOM UNITS PRIOR TO FABRICATION - CUSTOM DIMENSIONS SHALL BE VERIFIED IN FIELD PRIOR TO FABRICATION - CONTRACTOR TO CONFIRM LENGTH REQUIRED PER ARCHITECTURAL DRAWINGS AND SHALL COORDINATE MOUNTING

AS MFG BY (OR APPROVED EQUAL): B-K LIGHTING 40429 BRICKYARD DRIVE MADERA, CA 93636 (559) 438-5800 MMM.BKLIGHTING.COM

INSTALL PER MFG. RECOMMENDATIONS

DETAIL: CANOPY LIGHTING EXLA-07 - CUT SHEET

N.T.S,

N.T.S.

DETAIL: IN GROUND PAVING LIGHTING EXLA-12 - CUT SHEET

3 \ DETAIL: CAFE CANOPY LIGHTING EXLA-15 - CUT SHEET

L-7 /

RECESSED WALL-MOUNTED FIXTURE B
 MODEL: LED RECESSED WALL LUMINAIRE LAMP: 6W, DIRECTED FINISH: TO BE SELECTED BY LANDSCAPE

- CONTRACTOR SHALL SUBMIT COLOR SAMPLES TO OWNER'S REP FOR REVIEW & APPROVAL PRIOR TO ORDERING - CONTRACTOR SHALL PROVIDE SHOP DRAWINGS FOR CUSTOM UNITS PRIOR TO FABRICATION - CUSTOM DIMENSIONS SHALL BE VERIFIED IN FIELD PRIOR TO FABRICATION - CONTRACTOR TO COORDINATE WITH ARCHITECTURAL DRAWINGS TO CONFIRM LOCATION AND INSTALLATION AS MFG BY (OR APPROVED EQUAL): BEGA LIGHTING 1000 BEGA WAY CARPINTERIA, CA 93013 (805) 684-0533

ARCHITECT

MMM.BEGA-US.COM

INSTALL PER MFG. RECOMMENDATIONS

CAFE CANOPY FIXTURE

MODEL: VINTAGE GLOBE, GI6.5

AS MFG BY (OR APPROVED EQUAL):

MMM.ARCHIPELAGOLIGHTING.COM

INSTALL PER MFG. RECOMMENDATIONS

LAMP: 2W FINISH: CLEAR AMBER LENS

ARCHIPELAGO LIGHTING 4615 STATE STREET

MONTCLAIR, CA 91763

(866) 912-3220

DETAIL: RECESSED WALL LIGHTING W-I - CUT SHEET

N.T.S.

08/14/2020


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ATTACHMENT DETAIL PRUNE DAMAGED AND CONFLICTING BRANCHES MAINTAINING NORMAL TREE SHAPE. NEVER OUT CENTRAL TRUNK OR LEADER AND DO NOT REMOVE TERMINAL BUDS OF BRANCHES THAT EXTEND TO THE EDGE OF THE CROWN. TREE WRAP - WRAP TREE WITH BREATHABLE FABRIC FROM TRUNK VERTICAL STAKES, 3" O.D., -FLARE TO THE FIRST BRANCH. SECURE WITH BIO-DEGRADABLE TAPE CEDAR OR APPROVED EQUIVALENT, EQUALLY SPACED. ARBOR TIE DRIVE STAKE AT SLIGHT ANGLE. REMOVE ALL ROPE FROM TRUNK AND TOP OF BALL. REMOVE BURLAP TREE SIZE 8'-10' HT. FROM THE TOP (HALF) ½ OF THE ROOT BALL. WHEN A WIRE BASKET IS 2 @ 6' PRESENT THE WIRE BASKET SHALL BE REMOVED FROM THE TOP HALF OF THE ROOT BALL OR AS MUCH AS POSSIBLE TO PRESERVE THE INTEGRITY 10'-2" CAL. 2 @ 7' OF THE ROOT BALL. 2"-4" CAL. 2 @8' 4"-6" CAL. 3 @10' +6" CAL. SEE MAJOR TREE THE TRUNK FLARE OF EACH TREE SHALL BE VISIBLE AT THE TOP OF THE GUYING DETAIL ROOT BALL. IF NURSERY GRADE IS ABOVE THE FLARE THE CONTRACTOR SHALL CAREFULLY EXCAVATE THE TOP OF THE ROOT BALL TO EXPOSE THE TRUNK FLARE. TREES WHOSE TRUNK FLARE IS NOT VISIBLE SHALL BE REJECTED. DO NOT COVER THE THE TOP OF THE ROOT BALL WITH SOIL. – 3" SHREDDED HARDWOOD BARK MULCH, UNIFORMLY SPREAD. MULCH SHALL NOT BE IN CONTACT WITH THE TRUNK OF THE TREE - FINISH GRADE — 3" SAUCER RIM -BACKFILL MIXTURE, SHALL BE A THOROUGHLY MIXED BLEND OF TOPSOIL & SOIL AMENDMENTS. AMENDMENTS SHALL BE ADDED AS RECOMMENDED BY A CERTIFIED SOIL TEST. AIR POCKETS SHALL REMOVED FROM BACKFILL. TAMP SOIL AROUND ROOT BALL BASE FIRMLY TO PREVENT THE ROOT BALL FROM SHIFTING. GEOTEXTILE FABRIC MARKER LAYER (TYP. - SEE ENGINEER'S DRAWINGS) PLACE ROOT BALL ON UNEXCAVATED OR TAMPED SOIL. 1'-0" MIN' CLEAN FILL. UNDISTURBED GRADE 1'-0" MIN' CLEAN FILL 5'-0" MIN.

CONTRACTOR SHALL PARTIALLY FILL WITH WATER A REPRESENTATIVE NUMBER OF PITS IN EACH AREA OF THE PROJECT PRIOR TO PLANTING TO DETERMINE IF THERE IS ADEQUATE PERCOLATION. IF PIT DOESN'T PERCOLATE, MEASURES MUST BE TAKEN TO ASSURE PROPER DRAINAGE CONTRACTOR SHALL REMOVE STAKING, GUYING AND WRAP AT END OF GUARANTEE PERIOD. ALL PLANTING MUST BE GUARANTEED FOR ONE FULL GROWING SEASON FROM THE TIME OF FINAL ACCEPTANCE BY THE OWNER OR GOVERNING AUTHORITY. ON ALL FALL PLANTINGS THE CONTRACTOR SHALL WRAP THE TREES SPECIFIED BY THE LANDSCAPE ARCHITECT (ACER Spp.) FROM THE TRUNK FLARE TO THE FIRST BRANCH. TREE WRAP SHALL BE REMOVED BY APRIL I. TREE WRAP SHALL BE BREATHABLE AND AS APPROVED BY THE LANDSCAPE ARCHITECT. TREE WRAP SHALL BE INSTALLED AT THE TIME OF PLANTING AND BE REMOVED AS DIRECTED BY THE LANDSCAPE ARCHITECT

TREE WRAP SHALL BE REMOVED NO LATER THAN 12 MONTHS AFTER PLANTING. TREES WHOSE NORTH ORIENTATION IS NOT CHANGED FROM THE NURSERY DO NOT NEED TO BE WRAPPED UNLESS OTHERWISE DIRECTED BY THE LANDSCAPE ARCHITECT. GUYS ON MULTI-STEM TREES TO BE MADE ON HEAVIEST BRANCHES OF PLANT


SECTION: TREE PLANTING \ L-8

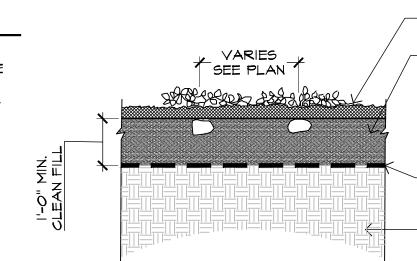

3" SHREDDED HARDWOOD BARK MULCH COVERING ENTIRE PLANTING BED. BACKFILL MIXTURE, SHALL BE A THOROUGHLY MIXED BLEND OF TOPSOIL \$ SOIL AMENDMENTS. AMENDMENTS SHALL BE ADDED AS RECOMMENDED BY A CERTIFIED SOIL TEST. BACKFILL SHALL BE WATERED WHILE PLANTING TO ELIMINATE AIR POCKETS.

GEOTEXTILE FABRIC MARKER LAYER (TYP. - SEE ENGINEER'S DRAWINGS) UNDISTURBED SUBGRADE



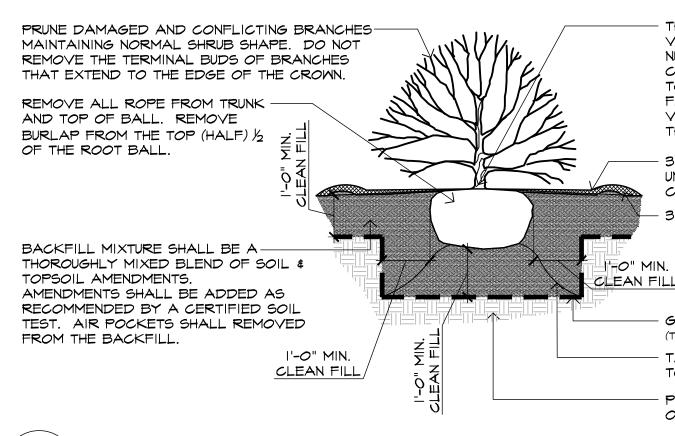

SECTION: SHRUB PLANTING

THE TRUNK FLARE OF EACH SHRUB SHALL BE VISIBLE AT THE TOP OF THE ROOT BALL. IF NURSERY GRADE IS ABOVE THE FLARE THE CONTRACTOR SHALL CAREFULLY EXCAVATE THE TOP OF THE ROOT BALL TO EXPOSE THE TRUNK FLARE. TREES WHOSE TRUNK FLARE IS NOT VISIBLE SHALL BE REJECTED. DO NOT COVER THE THE TOP OF THE ROOT BALL WITH SOIL.

3" SHREDDED HARDWOOD BARK MULCH, UNIFORMLY SPREAD. MULCH SHALL NOT BE IN CONTACT WITH THE TRUNK OF THE SHRUB. 3" SAUCER RIM

GEOTEXTILE FABRIC MARKER LAYER (TYP. - SEE ENGINEER'S DRAWINGS) TAMP SOIL AROUND ROOT BALL BASE FIRMLY TO PREVENT THE ROOT BALL FROM SHIFTING. PLACE ROOT BALL ON UNEXCAVATED

OR TAMPED SOIL.

SCALE: N.T.S.

000000

SMART CONTROLLER

SOIL MOISTURE SENSOR

BASE·LINE

LEED IRRIGATION REQUIREMENTS

POLYETHYLENE IRRIGATION PIPE AND FITTINGS

AUTOMATIC CONTROLLER CONTROLLER SHALL BE MANUFACTURED BY BASELINE INC, OR APPROVED EQUAL AND INSTALLED PER MANUFACTURER'S SPECIFICATIONS. FINAL MODEL TO BE SELECTED AS PER PROJECT DEMANDS AND SHOP DRAWINGS SHALL BE SUBMITTED TO LANDSCAPE ARCHITECT FOR APPROVAL PRIOR INSTALLATION. BASESTATION IRRIGATION CONTROLLERS ARE ADVANCED SMART CONTROLLERS. THE COMPREHENSIVE FEATURES OF THE BASESTATION INCLUDE PATENTED TWO-WIRE TECHNOLOGY, CONVENTIONAL WIRE AND RETROFIT SOLUTIONS, ADVANCED FLOW MANAGEMENT OPTIONS, AND FLEXIBLE CENTRAL CONTROL COMMUNICATION OPTIONS. THE BASESTATION CAN INCORPORATE UP TO 25 OF BASELINE'S SOIL MOISTURE SENSORS FOR SMART, ET-BASED IRRIGATION MANAGEMENT THAT CAN REDUCE

SOIL MOISTURE & RAIN SENSORS SENSORS SHALL BE MANUFACTURED BY BASELINE OR APPROVED EQUAL. ACTUAL MODEL SHALL BE SELECTED BY DESIGN/BUILD CONTRACTOR.

WATER USE BY UP TO 62 PERCENT OR MORE.

IN-LINE DRIP TUBING AND EQUIPMENT IN-LINE DRIP TUBING TO BE MANUFACTURED BY NETAFIM IRRIGATION, STAINLESS STEEL CLAMPS SHALL BE USED TO SECURE IN-LINE DRIP TUBING TO INSERT BARBED FITTINGS. FILTERS SHALL CONSIST OF A TWO PIECE THREADED HOUSING WITH O-RING SEAL. FILTERS & SCREENS SHALL BE SIZED APPROPRIATELY. PRESSURE REGULATORS SHALL BE INCORPORATED TO ASSURE CORRECT INCOMING PRESSURE INTO DRIP TUBING AS RECOMMENDED BY MFG.

IRRIGATION NOTES:

SCALE: N.T.S.

- ALL PLANTED AREAS AND LAWN SHALL BE IRRIGATED. INTENSIVE EXTENSIVE PLANTING SHALL BE ZONED SEPARATELY FOR THE PURPOSES OF IRRIGATION. CONTRACTOR SHALL SUBMIT DETAILED SHOP DRAWINGS PROVIDING IRRIGATION LAYOUT, DETAILS, ETC. PRIOR TO CONSTRUCTION. 2. IOTH FLOOR LANDSCAPE DECK SHALL UTILIZE DRIP IRRIGATION SYSTEM.
- CONTRACTOR SHALL SUBMIT SHOP DRAWINGS PRIOR TO INSTALLING. SPACING AND DEPTH PLACEMENT AS RECOMMENDED BY MFG. IRRIGATION CONTROL CLOSETS SHALL BE LOCATED AS NOTED ON MEP PLANS
- PLANTER WALLS SHALL BE SLEEVED TO MINIMIZE PENETRATIONS TO THE SLAB FOR IRRIGATION LINES. IRRIGATION LINES SHALL BE RUN WITHIN PLANTING AREAS OR UNDER
- PEDESTAL PAVERS FOR ROOFTOP APPLICATIONS. 5. EXTENSIVE IRRIGATION SHALL BE PER EXTENSIVE GREEN ROOF MFG. RECOMMENDATIONS
- IRRIGATION REQUIREMENTS MEP PLANS SHALL INCLUDE A I INCH IRRIGATION EXCLUSION WATER METER AND A I INCH REDUCED-PRESSURE BACK FLOW PREVENTION DEVICE WITH A I INCH ISOLATION SHUT-OFF IMMEDIATELY DOWNSTREAM OF THE BACKFLOW PREVENTER AND A I INCH DRAIN IN THE PIPE TO REMOVE WATER IN THE LINE.
- THE IRRIGATION SYSTEM WILL REQUIRE 55 PSI DYNAMIC PRESSURE AT A MAXIMUM FLOW RATE OF 20-GPM AT THE IRRIGATION CONTRACTOR'S POINT OF CONNECTION OUTSIDE OF THE BUILDING AT THE STREETSCAPE, THE IOTH FLOOR LANDSCAPE DECK AND THE ROOFTOP.
- THE POINT OF CONNECTION SHALL BE A COPPER PIPE STUBBED OUT OF T BUILDING INTO THE PLANTING MEDIA, WITH MALE PIPE THREADS. THIS ALLOWS THE IRRIGATION CONTRACTOR TO THREAD A GATE VALVE TO TH COPPER PIPE OUTSIDE OF THE BUILDING. A WINTERIZATION POINT SHALL E INSTALLED BY THE IRRIGATION CONTRACTOR IMMEDIATELY DOWNSTREAM OF THE COPPER STUB. SEE PLANS FOR STUB OUT LOCATIONS.
- 9. A DEDICATED 20 AMP, I20-VOLT CIRCUIT WILL BE REQUIRED TO OPERAT THE IRRIGATION CONTROLLER. THE IRRIGATION CONTROLLER WILL NEED 1 BE MOUNTED WITHIN A MECHANICAL ROOM, APPROXIMATELY 18 INCH X 18 INCH SQUARE WALL SPACE IS REQUIRED AND NEEDS TO BE PROPERLY GROUNDED. A 1.5 INCH ELECTRICAL CONDUIT TO BE USED FOR THE 24-VOI IRRIGATION CONTROL WIRES WILL BE NEEDED TO BE ROUTED FROM THE IRRIGATION CONTROLLER AND STUBBED OUT OF THE BUILDING TO THE LOCATION OF THE WATER SUPPLY STUB OUT AT THE STREETSCAPE, THE IC FLOOR LANDSCAPE DECKS AND THE ROOFTOP.

SCALE: NOT TO SCALE

PLANT NOTES:

- I. THE CONTRACTOR SHALL FURNISH QUANTITIES NECESSARY TO COMPLETE THE PLANTING AS SHOWN ON THE PLANTING PLANS. A. ALL PLANTS SHALL EQUAL OR EXCEED MEASUREMENTS SPECIFIED IN THE PLANT LIST WHICH
 - ARE THE MINIMUM ACCEPTABLE. B. PLANTS SHALL BE MEASURED BEFORE PRUNING. NECESSARY PRUNING SHALL BE PERFORMED AFTER THE PLANT IS UNTIED AND PRIOR TO INSTALLATION. LANDSCAPE ARCHITECT SHALL BE NOTIFIED OF ANY MAJOR PRUNING REQUIREMENTS DUE TO DAMAGE. THE LANDSCAPE ARCHITECT RESERVES THE RIGHT TO REJECT ANY PLANT MATERIAL THAT NEEDS SIGNIFICANT PRUNING DUE TO DAMAGE FROM SHIPMENT OR HANDLING
 - C. WHEN FORMAL ARRANGEMENTS OR CONSECUTIVE ORDER OF TREES OR SHRUBS IS SHOWN, STOCK SHALL BE SELECTED FOR UNIFORM HEIGHT AND SPREAD AND LABELED BY NUMBER TO ASSURE SYMMETRY IN PLANTING.
- 2. WHEN ALL PLANT MATERIAL HAS BEEN SELECTED AND PRE-TAGGED BY THE LANDSCAPE CONTRACTOR, THE LANDSCAPE ARCHITECT SHALL BE NOTIFIED IN ORDER TO SCHEDULE HIS NURSERY INSPECTION WITH A MINIMUM OF 3 DAYS ADVANCE NOTICE.
 - A. THE CONTRACTOR SHALL ACCOMPANY THE LANDSCAPE ARCHITECT ON ALL INSPECTIONS. B. THE CONTRACTOR SHALL HAVE SUFFICIENT ALTERNATE CHOICES TO PREVENT LOSS OF TIME IN THE EVENT THAT SOME TREES FAIL TO MEET THE APPROVAL OF THE LANDSCAPE ARCHITECT.
 - C. ALL TREES MUST BE APPROVED IN THE FIELD BY THE LANDSCAPE ARCHITECT BEFORE DIGGING BEGINS.
- 3. LOCATIONS OF PLANT MATERIAL SHOWN ON PLANS ARE APPROXIMATE. FINAL LOCATIONS WILL VARY FROM PLAN AND SHALL BE DETERMINED IN THE FIELD UNDER THE DIRECTION OF THE LANDSCAPE ARCHITECT. A. CONTRACTOR SHALL PROVIDE PRE-MARKED, COLOR-CODED FLAGS FOR ALL SHADE TREES, EVERGREEN TREES AND FLOWERING TREES.
 - B. LANDSCAPE ARCHITECT SHALL PLACE THE COLOR-CODED FLAGS TO INDICATE PLANT C. CONTRACTOR SHALL PLACE TREES ABOVE GROUND IN ACCORDANCE WITH THE FLAGGED
 - LOCATION. THE LANDSCAPE ARCHITECT MAY REQUEST THE CONTRACTOR TO MOVE, TURN OR RELOCATE THE PLANT MATERIAL AT THIS TIME. UNDER NO CIRCUMSTANCES SHALL THE
 - CONTRACTOR PRE-DIG TREE PITS. D. UPON FINAL APPROVAL BY THE LANDSCAPE ARCHITECT OF TREE PLACEMENT, CONTRACTOR SHALL PAINT A CIRCLE AROUND THE BALL OF THE TREE, MOVE TREE AND EXCAVATE TREE PIT.
- 4. PLANTS SHALL BE TYPICAL OF THEIR SPECIES AND VARIETY; HAVE NORMAL GROWTH HABITS; WELL DEVELOPED BRANCHES, DENSELY FOLIATED; VIGOROUS ROOT SYSTEMS, BE FREE FROM DEFECTS AND INJURIES AND COMPLY WITH ANY SPECIAL INSTRUCTIONS NOTED WITHIN THE PLANT LIST. 5. PLANT MATERIAL SHALL BE PLANTED ON THE DAY OF DELIVERY. IN THE EVENT THIS IS NOT POSSIBLE, THE CONTRACTOR SHALL PROTECT PLANT STOCK WHICH HAS NOT BEEN PLANTED. PLANTS SHALL NOT REMAIN
- UNPLANTED FOR LONGER THAN A THREE DAY PERIOD AFTER DELIVERY. 6. QUALITY, BRANCHING AND SIZE OF PLANTS, INCLUDING ROOT SIZE, SHALL BE IN ACCORDANCE WITH "AMERICAN STANDARDS FOR NURSERY STOCK" ANSI Z60 .I-2004 (MOST RECENT EDITION) AS PUBLISHED BY THE AMERICAN NURSERY AND LANDSCAPE ASSOCIATION.
- 7. B&B PLANTS SHALL BE HANDLED FROM THE BOTTOM OF THE ROOT BALL ONLY. PLANTS WITH BROKEN, SPLIT OR DAMAGED ROOT BALLS SHALL BE REJECTED. 8. ALL PLANTING BEDS SHALL BE MULCHED TO A DEPTH OF 3-4 INCHES WITH SHREDDED HARDWOOD BARK MULCH. MULCH SHOULD NOT COME INTO CONTACT WITH THE ROOT COLLAR OF TREES OR SHRUBS. MULCH SHALL BE TREATED WITH A PRE-EMERGENT HERBICIDE. THE TOP OF THE ROOT BALL FOR ALL B&B PLANTS SHALL BE EXCAVATED TO EXPOSE THE ROOT FLARE. THE ROOT FLARE SHALL BE AT THE TOP OF THE BALL AND PLANTED LEVEL OR I" ABOVE FINISHED GRADE. ALL BEDLINES SHALL BE CUT FOUR INCHES DEEP
- INTO A "V" SHAPED GROOVE TO PROVIDE A WELL DEFINED EDGE. THE LAYOUT OF ALL BEDLINES SHALL BE APPROVED BY THE LANDSCAPE ARCHITECT ON-SITE PRIOR TO CUTTING. 9. THE CONTRACTOR SHALL BE RESPONSIBLE FOR ALL UTILITY MARK OUTS AND COMPLIANCE WITH ALL FEDERAL, STATE OR LOCAL CODES, LAWFUL ORDERS OR REGULATIONS GOVERNING UPON THIS WORK.
- 10. THE CONTRACTOR SHALL BE RESPONSIBLE FOR THE PROPER INSTALLATION AND MAINTENANCE OF ALL TREE GUYS, STAKES, SUPPORTS AND MULCH RINGS OR BEDS DURING THE CONSTRUCTION AND MAINTENANCE
- II. THE CONTRACTOR SHALL REPORT ANY SOIL OR DRAINAGE CONDITIONS CONSIDERED DETRIMENTAL TO THE GROWTH OF THE PROPOSED PLANT MATERIAL 12. TREES SHALL BE PRUNED OF ANY BRANCHES THAT INTERFERE WITH PEDESTRIANS, VEHICLES OR SIGNS.
- 13. SHADE TREES MUST BE SINGLE TRUNK, TREE FORM SPECIMENS. ALL PARKING LOT AND STREET TREES SHALL BE LIMBED TO A HEIGHT OF SEVEN FEET. 14. ANY DISCREPANCY BETWEEN THE PLANS AND FIELD CONDITIONS SHALL BE RESOLVED BY THE LANDSCAPE
- ARCHITECT IN THE FIELD. 15. ALL PLANTED AREAS & LAWN AREAS SHALL BE IRRIGATED WITH AN AUTOMATIC IRRIGATION SYSTEM THROUGH THE USE OF SURFACE OR DRIP-IRRIGATION TO PROVIDE ADEQUATE WATER TO PROMOTE HEALTHY PLANT MATERIAL AND SOUND HORTICULTURAL PRACTICE. IRRIGATION CONTRACTOR SHALL SUBMIT
- PROPOSED IRRIGATION PLANS TO LANDSCAPE ARCHITECT FOR REVIEW AND APPROVAL PRIOR TO INSTALLATION. 16. PLANTING OPERATIONS SHALL BE PERFORMED DURING PERIODS WITHIN THE PLANTING SEASON WHEN WEATHER AND SOIL CONDITIONS ARE SUITABLE AND IN ACCORDANCE WITH ACCEPTABLE LOCAL PRACTICE TREES AND SHRUBS SHOULD BE INSTALLED DURING THE FOLLOWING FALL AND SPRING SEASONS, WITH THE
- EXCEPTION OF TREES WHICH EXPERIENCE A FALL DIGGING HAZARD WHICH SHOULD ONLY BE PLANTED IN
- 17. ALL PLANT MATERIAL SHALL BE GUARANTEED FOR A MINIMUM PERIOD OF I YEAR FROM THE TIME OF LANDSCAPE APPROVAL BY LANDSCAPE ARCHITECT AND/OR REVIEWING AUTHORITY.
- 18. ALL SUBSTITUTIONS SHALL BE SUBMITTED TO THE LANDSCAPE ARCHITECT FOR REVIEW AND APPROVAL PRIOR TO PLANTING

AUG. 15-DEC. 15 EVERGREEN TREES OCT. 15-DEC. 15 DECIDUOUS TREES MAR. I-MAY 15 ALL PLANTS

FALL DIGGING HAZARD BETULA VARIETIES CARPINUS VARIETIES CELTIS VARIETIES CERCIDIPHYLLUM VARIETIES CRATAEGUS VARIETIES FAGUS VARIETIES

HALESIA VARIETIES ILEX OPACA VARIETIES ALL TREEFORM EVERGREEN ILEX VARIETIES LIQUIDAMBAR VARIETIES

LIRIODENDRON TULIPIFERA MALUS-IN LEAF NYSSA SYLVATICA OSTRYA VARIETIES PRUNUS-ALL STONE FRUITS PYRUS VARIETIES QUERCUS-ALL OAKS EXCEPT Q. PALUSTRIS SALIX-WEEPING VARIETIES TILLA TOMENTOSA VARIAETIES ZELKOVA VARIETIES

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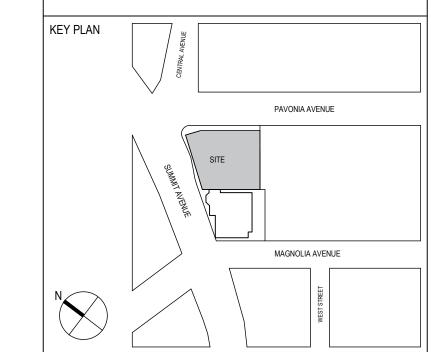
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SIGNATURE

NOT FOR CONSTRUCTION

08/14/2020 | PLANNING BOARD SUBMISSION

NO. DATE ISSUE OR REVISION DRAWING TITLE:

> PLANTING & **IRRIGATION DETAILS AND NOTES**

AS NOTED 08/14/2020

IRRIGATION CONTROLLER AND COMPONENTS

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